




SHERWOOD OLD TOWN APARTMENTS

LAND USE REVIEW SET

8/22/25

6665 SW WILLAMETTE

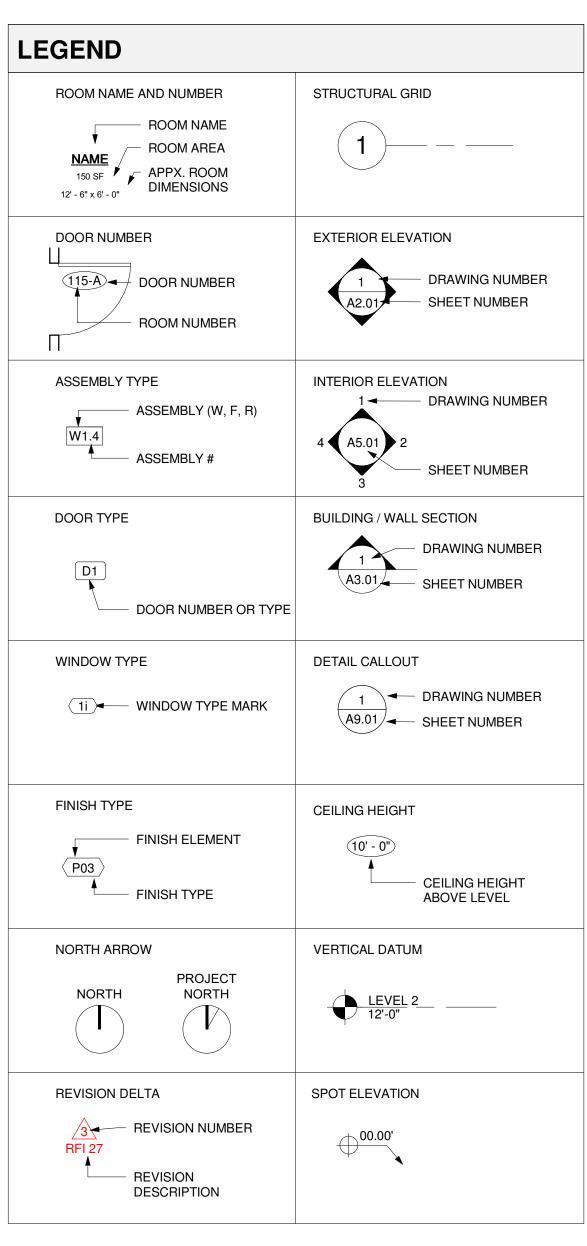

DIMENSIONS . DIMENSIONS ARE INDICATED IN THE DOCUMENTS. THE DRAWINGS SHALL NOT BE SCALED FOR DIMENSIONS. 2. IN MANY INSTANCES, THE ACTUAL DIMENSIONS MAY BE LESS IMPORTANT THAN IF ELEMENTS ARE TO BE EQUAL. IN THESE CASES, THE NOTATION "EQ" IS USED IN LIEU OF THE ACTUAL DIMENSION. 3. DETAILS WILL GOVERN ALL DIMENSIONS NOT SHOWN ON PLANS. REFERENCE DETAIL DIMENSION POINTS. 4. EXTERIOR GRID LINES CORRESPOND TO EXTERIOR FACE OF FRAMING 5. CONCRETE AND MASONRY WALLS ARE DIMENSIONED TO FACE OF BRICK VENEER OR FACE OF CONCRETE UNLESS NOTED OTHERWISE. 6. INTERIOR WALLS ARE DIMENSIONED TO FACE OF FRAMING UNLESS NOTED 7. INTERIOR WALLS WHICH ARE EQUALLY SPACED ARE DIMENSIONED TO CENTERLINE. DOORS ARE LOCATED BY ONE OF THE FOLLOWING: A. 4" FROM FACE OF ADJACENT WALL TO DOOR SIDE FACE OF JAMB. - ADJACENT WALL - DOOR 4" TYP.-B. AS DIMENSIONED.

WWF

XFRMR

TRANSFORMER

TRANSFER

WELDED WIRE FABRIC

ABBREVIATIONS					
AB	ANCHOR BOLT	HDWD	HARDWOOD	S	SOUTH
ABV	ABOVE	HGT	HEIGHT	SC	SOLID CORE
ACT	ACOUSTICAL CEILING TILE	HM	HOLLOW METAL	SC	SHOWER CURTAIN
AC	ARCHITECTURAL CONCRETE	HNDRL	HANDRAIL	SD	SOAP DISPENSER
A/C	ASPHALTIC CONCRETE	HORIZ	HORIZONTAL	SCHED	SCHEDULE
AD	AREA DRAIN	HP	HIGH PERFORMANCE	SECT	SECTION
ADD	ADDENDUM	HR	HOUR	SF	SQUARE FOOT (FEET)
ADJ	ADJACENT	HSTL	HOLLOW STEEL	SH	SHOWER HEAD`
AF	ACCESS FLOOR	HT	HEIGHT	SHTHG	SHEATHING
AFF AFP	ABOVE FINISH FLOOR	HTG HTR	HEATING HEATER	SHT	SHEET
AFP	ACOUSTICAL FIBERGLASS PANEL	HV	HOSE VALVE	SIM	SIMILAR
AFG	ABOVE FINISH GRADE	HVAC	HEATING, VENTILATING & AIR	SLR	SEALER
AGG	AGGREGATE	117710	CONDITIONING	SOG	SLAB ON GRADE
AHU	AIR HANDLING UNIT			SPEC	SPECIFICATION
ALT	ALTERNATE	ID	INSIDE DIAMETER/DIMENSION	SND	SANITARY NAPKIN DISPOSAL
ALUM	ALUMINUM	IN	INCH	SNV	SANITARY NAPKIN
AMT	AMOUNT	INCL	INCLUDE(D)	SIVV	VENDOR
APPROX	APPROXIMATE	INFO	INFORMATION	SQ	SQUARE
ARCH	ARCHITECT(URAL)	INSUL	INSULATION	SS	STAINLESS STEEL
AUTO	AUTOMATIC	INT	INTERIOR	ST	STREET
		INV	INVERT	STC	STUCCO
BC	BOTTOM OF CURB	JB	II INICTION POY	STD	STANDARD
BD BFF	BOARD BELOW FINISH ELOOP	JST	JUNCTION BOX JOIST	STL	STEEL
BLDG	BELOW FINISH FLOOR BUILDING	JS1 JT	JOINT	STN	STAIN (ED)
BLDG	BLOCK	01	JUII 1	STAG	STAGGERED
BLKG	BLOCKING	KO	KNOCKOUT	STOR	STORAGE
BM	BEAM	KP	KICK PLATE	STR	STRUCTURAL
BO	BOTTOM OF			STUC	STUCCO
BOD	BOTTOM OF DECK	L	LENGTH	SURF SUSP	SURFACE SUSPENDED
BOR	BOTTOM OF REVEAL	LAM	LAMINATE	SWS	SEE WALL SECTIONS
BOT	BOTTOM	LAV	LAVATORY	SYM	SYMMETRICAL
BRG	BEARING	LB	POUND OR LAG BOLT	SYS	SYSTEM
BRK	BRICK	LF	LINEAR FOOT OR FEET	0.0	3 · 3 · 2 · ·
BSMT	BASEMENT	LH	LEFT HAND	TB	TACKBOARD
OAD	CARINETRY	LIN	LINOLEUM LIVE LOAD	TEMP	TEMPORARY
CAB CB	CABINETRY CATCH BASIN	LL LT	LIGHT	TEMP GL	
CEM	CEMENT	LVR	LOUVER	T&B	TOP & BOTTOM
CEN PT	CENTER POINT		EGGVER	T&G	TONGUE & GROOVE
CG	CORNER GUARD	М	METRIC	THK	THICK
CH	BABY CARE CENTER	MACH	MACHINE	THRSH	THRESHOLD
CHK	CLOTHES HOOK	MAS	MASONRY	THRU	THROUGH
CIP	CAST-IN-PLACE	MATL	MATERIAL	T.I.	TENANT IMPROVEMENT
CL	CENTER LINE	MAX	MAXIMUM	TO TOC	TOP OF TOP OF CONCRETE OR
CLG	CEILING	MB	MARKER BOARD	100	CURB
CLR	CLEAR	MDF	MEDIUM DENSITY FIBERBOARD	TOP	TOP OF PLATE
CMU	CONCRETE MASONRY UNIT	MDO	MEDIUM DENSITY OVERLAY	TOS	TOP OF STEEL
COL	COLUMN	MECH	MECHANICAL	TOT	TOTAL
CONC	CONCRETE	MEMB	MEMBRANE	TOW	TOP OF WALL
CONT	CONTINUOUS	MFR	MANUFACTURER	TPD	TOILET PAPER
CORR	CORRIDOR	MH	MANHOLE		DISPENSER
COV PL CPT	COVER PLATE CARPET	MH MIN	MOP HOOK MINIMUM	TRD	TREAD
CPTT	CARPET TILE	MI	MIRROR	TSD	TOILET SEAT COVER
CR	CURTAIN ROD	MISC	MISCELLANEOUS	T (2)	DISPENSER
CRT	CRITICAL	MO	MASONRY OPENING	TYP	TYPICAL
CTR	CENTER	MR	MIRROR	LIKITIS	LINEINIOUES
	5 -	MRG	MOISTURE RESISTANT GYP.	UNFIN UNO	UNFINISHED UNLESS NOTED
DBL	DOUBLE		BOARD	UNU	OTHERWISE
DET	DETAIL	MTD	MOUNTED	UR	UNRATED
DF	DRINKING FOUNTAIN	MTL	METAL	J	_ · · · · · · · · · · · ·
DIA	DIAMETER	/ b IN	NITNA	V	VOLTAGE
DIFF	DIFFUSER	(N) N	NEW NORTH	VB	VAPOR BARRIER
DIM	DIMENSION DEAD LOAD	N NA	NORTH NOT APPLICABLE	VENT	VENTILATION
DL DN	DOWN	NA NIC	NOT APPLICABLE NOT IN CONTRACT	VERT	VERTICAL
DN DR	DOOR	NO.	NUMBER	VEST	VESTIBULE
DRN	DRAIN	NOM	NOMINAL	VFY	VERIFY
DS	DOWNSPOUT	NTS	NOT TO SCALE	VIF	VERIFY IN FIELD
DWG	DRAWING	-		VNR	VENEER
		OA	OUTSIDE AIR	W	WEST
E	EAST	OC	ON CENTER	W/	WITH
EA	ELEVATOR ANNUNCIATOR	OD	OUTSIDE	WD	WOOD
EB	EXPANSION BOLT	~ = -:	DIAMETER/DIMENSION	WD ACT	ACOUSTICAL WOOD
EC	ELEVATOR CALL STATION	OFCI	OWNER FURNISHED-		PANEL
EJ	EXPANSION JOINT	OFOL	CONTRACTOR INSTALLED	WDW	WINDOW
ELEC	ELECTRICAL	OFOI	OWNER FURNISHED-OWNER	WLD	WELD (ED)
ELEV	ELEVATION EMERCENCY	OPNG	INSTALLED OPENING	WOC	WALK ÒFF CARPET
EMER	EMERGENCY ENCLOSURE	OPNG OPP	OPPOSITE	WOM	WALK OFF MAT
ENCL ENGR	ENCLOSURE ENGINEER	OPP HD	OPPOSITE OPPOSITE HAND	WGL	WIRE GLASS
ENGR EP	ELECTRICAL PANEL	OPT	OPTIONAL	W/O	WITHOUT
EPNT	EPOXY PAINT	ORIG	ORIGINAL	WP	WATERPROOFING
EQ	EQUAL	OVHD	OVERHEAD	WR	WASTE RECEPTACLE
EQUIP	EQUIPMENT	J.1.15	5 <u></u>	WSCT	WAINSCOT
EXH	EXHAUST	PAV	PAVING OR PAVERS	WSTL	WEATHERED STEEL
(E)	EXISTING	PC	PRECAST CONCRETE	WT WTD	WEIGHT
EXP	EXPANSION	PCF	POUNDS PER CUBIC FOOT	WTR W/W	WATER WALL TO WALL
EXT	EXTERIOR	PD	PAPER TOWEL DISPENSER	VV/VV	WALL TO WALL

PAPER TOWEL DISPENSER

PAPER TOWEL DISPENSER/

WASTE RECEPTACLE

PERFORATED

PLATE

PLASTER

PLUMBING

PLYWOOD PANEL

PRELIMINARY

PROJECTION SCREEN

PRESSURE TREATED

POUNDS PER CUBIC INCH

THERMAL RESISTANCE (R-

REINFORCE (D) (ING) (MENT)

PAINT

PAINTED

QUARRY TILE

QUARTER

VALUE)

RADIUS RUBBER BASE

RETURN AIR

ROOF DRAIN

RECESSED

REQUIRED

REVISION

REFLECTED

ROOF VENT

RIGHT OF WAY

ROUGH OPENING

ROOM

RISER

ROUND

REFERENCE

REFRIGERATOR

RESILIENT FLOORING

PROPERTY LINE

PLASTIC LAMINATE

PD/WR

PLAM

PLAS

PNL

P-#

PRELIM

PTD

REF

REFR

REINF

REQD

REV

RSR

R/W

PLUMB

PLYWD

FIRE ALARM VISUAL DEVICE

FIRE ALARM CONTROL PANEL

FIRE ALARM PULL STATION

FIRE ALARM VISUAL DEVICE

AND ANNUNCIATOR

FIRE EXTINGUISHER

FIRE EXTINGUISHER

EXTERIOR

FLAT BAR

CABINET

FLOOR DRAIN

FOUNDATION

FINISH FLOOR

FINISH GRADE

FLUORESCENT

FACE OF FINISH

FACE OF STUDS

FIREPROOFING

FIRE RESISTIVE

DISPENSER

FIELD VERIFY

GALVANIZED

GRAB BAR

FOOTING

GAUGE

GLASS

GROUND

HOSE BIBB

HARDWARE

HEADER

HAND DRYER

FOOT OR FEET

FACE OF CONCRETE

FACE OF MASONRY

FEMININE SUPPLIES

GENERAL CONTRACTOR

GYPSUM WALL BOARD

GALVANIZED SHEET METAL

FIBERGLASS REINFORCED

FINISH(ED)

FLOOR

FACE OF

FACP

FAP

FAV

FB

FD FDN

FE

FG

FIN

FO

FOC

FOF

FOS

FPRF

FRAP

FRP

FSD

FTG

FT

FV

GA

GB GC

GL

GND

GSM

GWB

HD

HDR

HDW

GALV

FLUOR

DRAWINGS FOR LAND USE REVIEW ONLY

THIS ARCHITECTURAL DRAWING SET HAS BEEN PREPARED SOLELY FOR THE PURPOSE OF LAND USE APPLICATION REVIEW BY THE CITY OF SHERWOOD. THE DRAWINGS ARE INTENDED TO DEMONSTRATE GENERAL DESIGN INTENT AND CONFORMANCE WITH APPLICABLE ZONING, SITE PLANNING, AND OLD TOWN OVERLAY STANDARDS. THEY ARE NOT INTENDED FOR PERMIT, CONSTRUCTION, OR BIDDING PURPOSES.

PROJECT SUMMARY

PROJECT NAME: SHERWOOD OLD TOWN APARTMENTS ADDRESS:

15665 SW WILLAMETTE, SHERWOOD, OR 97140

BUILDING CODE: 2022 OSSC

ZONING: SHERWOOD MUNICIPAL CODE, TITLE 16

DESCRIPTION: NEW 32-UNIT APARTMENT BUILDING ON EXISTING UNDEVELOPED

PROJECT DIRECTORY

PLANNING CONSULTANT

DBM PROPERTIES, LLC 8101 SW NYBERG STREET SUITE 202

TUALATIN, OR 97062 CONTACT: ADRIAN OLTEAN E: ADRIAN@TEAMROCKPOINT.COM P: 503-969-2518

ARCHITECT

OWNER

ATTUNE ARCHITECTURE LLC 7888 SE JEFFERSON ST. MILWAUKIE, OR 97267 CONTACT: MATTHEW RUSNAC E: MATTHEW@ATTUNEARCH.COM P: (503) 740-9608

LIAM F. BEAN 315 COMMERCIAL ST SE, APT 340 SALEM OREGON, 97301

P: (916) 396-6001 E: LIAMFRANCISBEAN@GMAIL.COM

DRAWING INDEX

REV DATE SHEET# SHEET NAME GENERAL G000 COVER SHEET G001 **GENERAL INFORMATION** G002 OVERVIEW SITE PLAN G003 3D IMAGES LANDSCAPE

L100 LANDSCAPE PLAN

ARCHITECTURAL SITE PLAN & ZONING SUMMARY A002 ZONING ELEVATION

A101 FLOOR PLANS A102 FLOOR PLANS A103 UNIT PLANS A200 EXTERIOR ELEVATIONS EXTERIOR ELEVATIONS

VICINITY MAP





PRELIMINARY - NOT FOR CONSTRUCTION OR PERMITTING

Project Name

SHERWOOD OLD TOWN APARTMENTS

Project Address 15665 SW WILLAMETTE


SHERWOOD, OR 97140

revision:

set issue date: 8/22/25

sheet name:

GENERAL **INFORMATION**

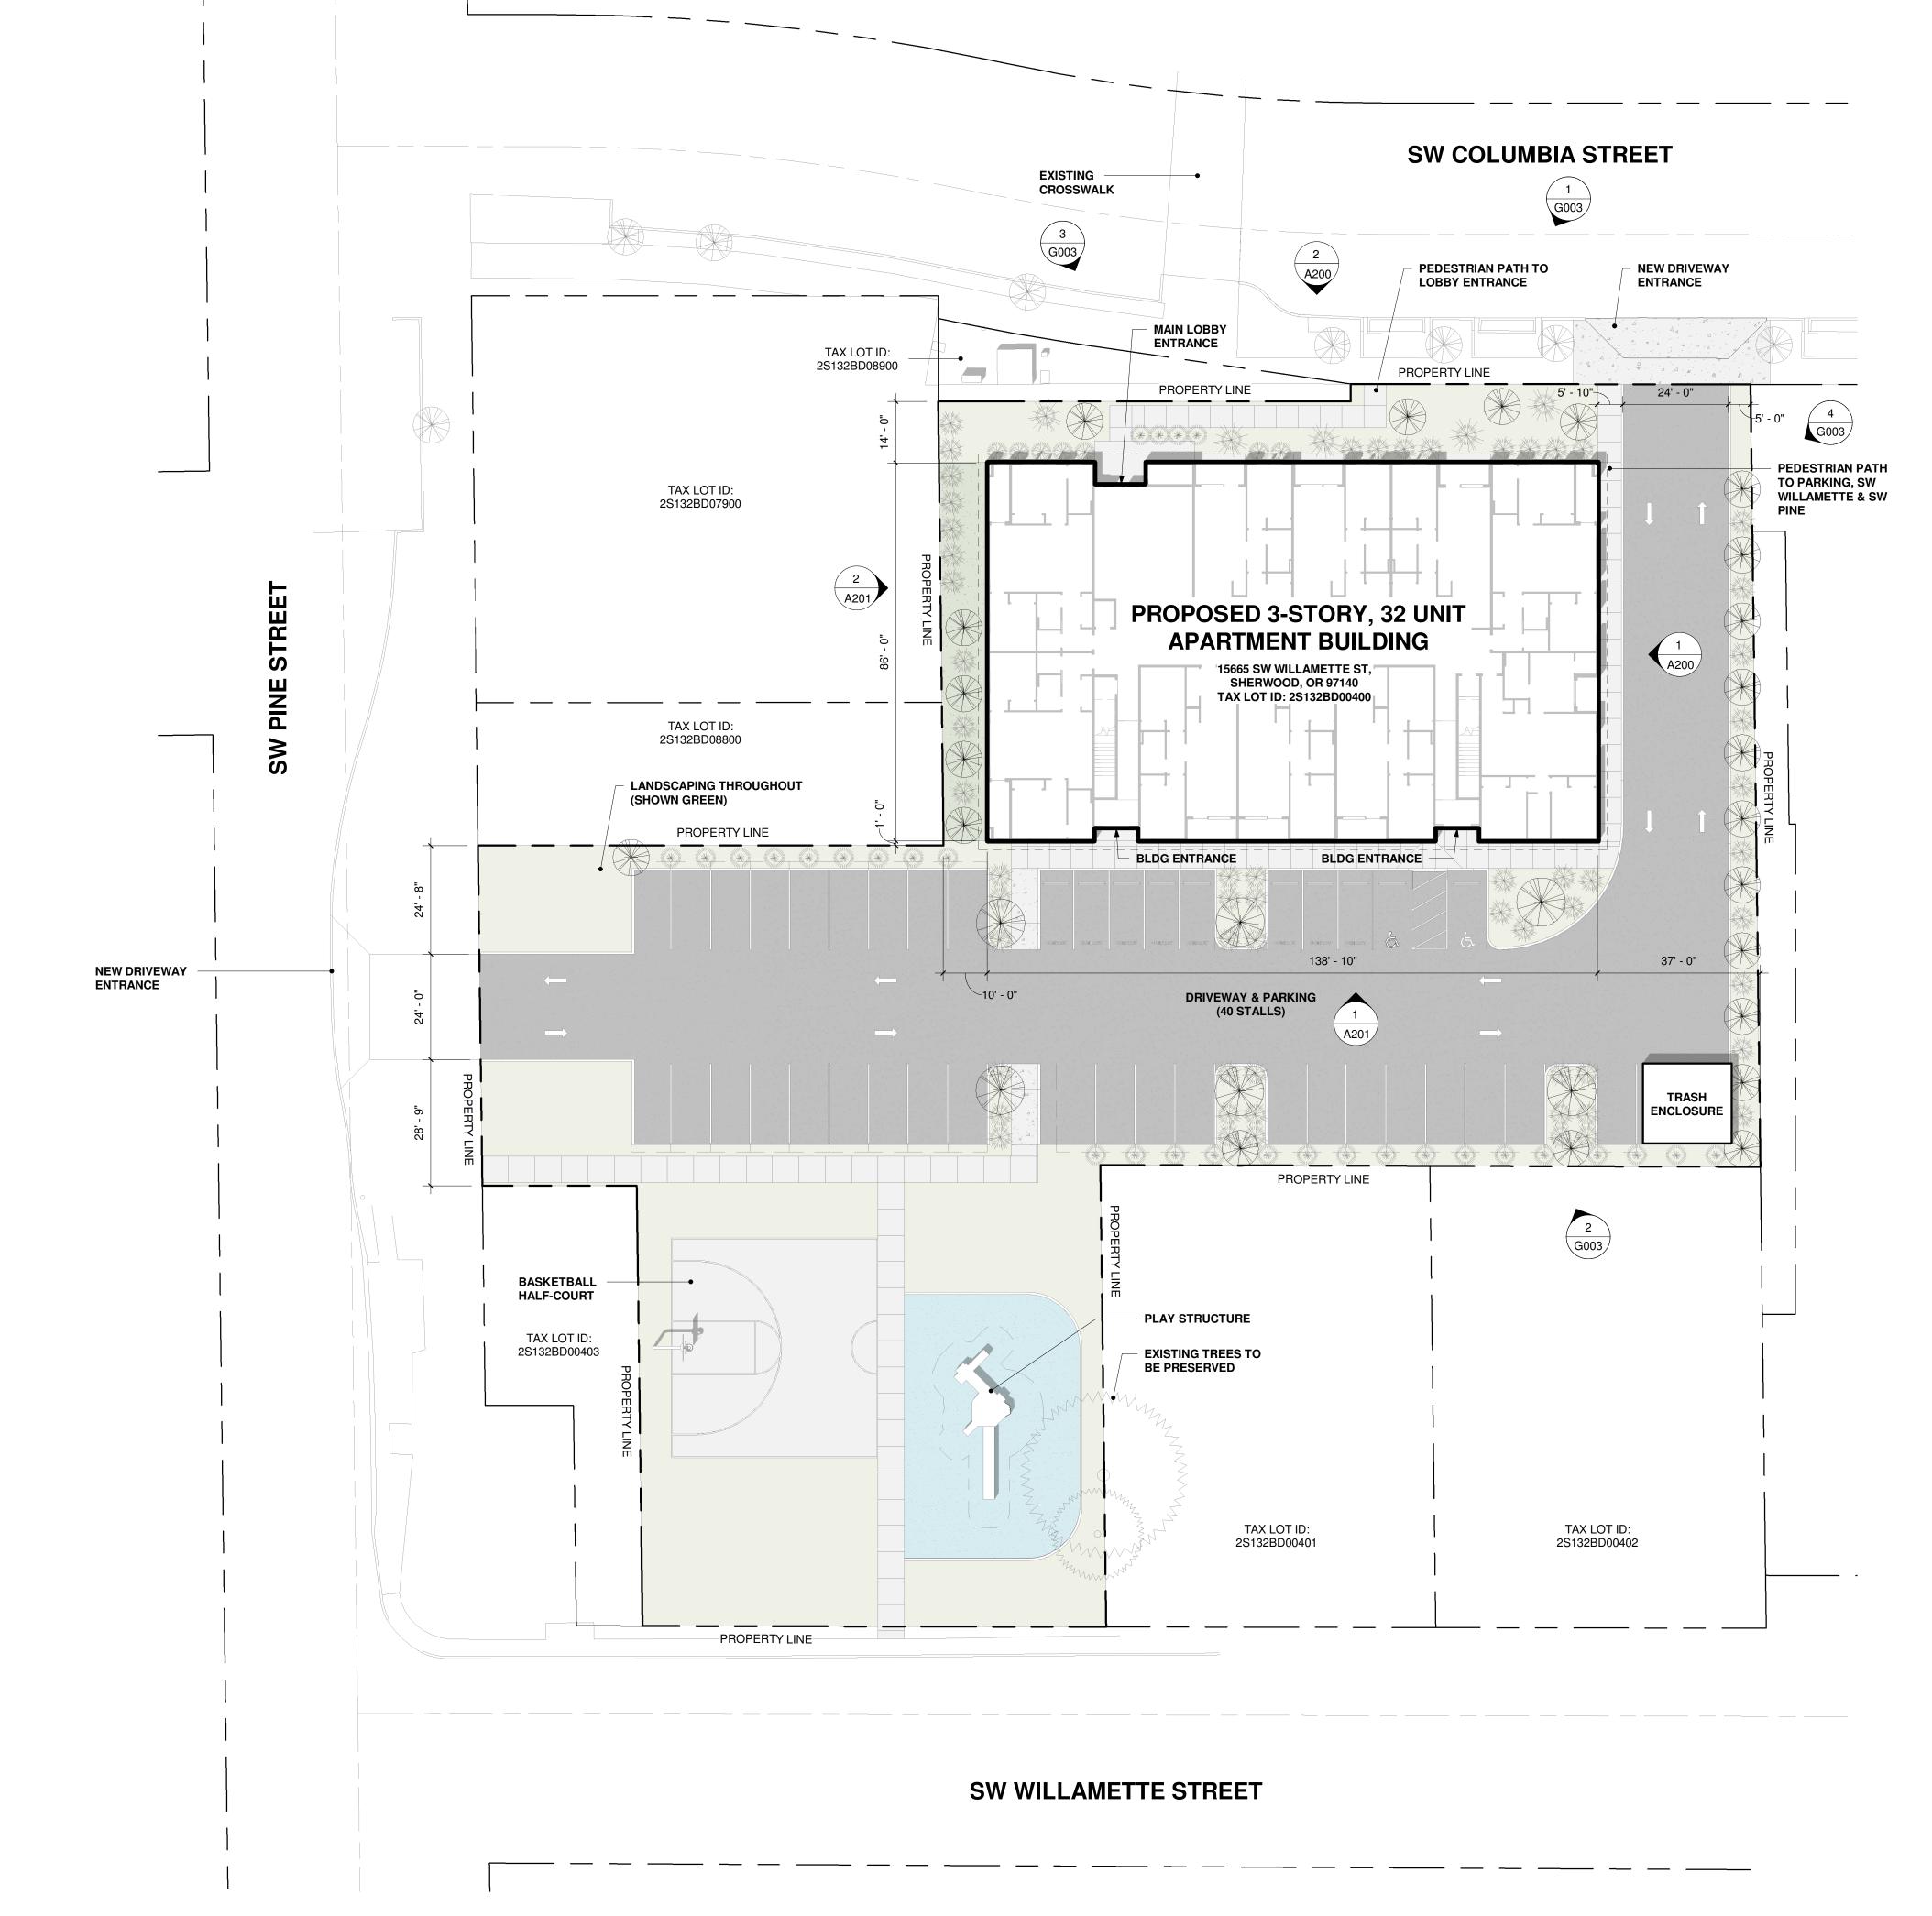

NOTE: THIS SITE PLAN IS PROVIDED FOR NEIGHBORHOOD MEETING PURPOSES ONLY. SEE SUBSEQUENT L & A-SERIES SHEETS FOR DETAILED DESIGN AND TECHNICAL INFORMATION ADDRESSING THE TYPE IV LAND USE REVIEW REQUIREMENTS.





PRELIMINARY - NOT FOR CONSTRUCTION OR PERMITTING

Project Name

SHERWOOD OLD TOWN APARTMENTS

Project Address
15665 SW WILLAMETTE
SHERWOOD, OR 97140

revisio

set issue date: 8/22/25

sheet name:

OVERVIEW SITE PLAN

G002

GENERAL NOTE – 3D VIEWS
THESE PERSPECTIVE IMAGES ARE PROVIDED FOR
REFERENCE ONLY. THEY ARE INTENDED TO ILLUSTRATE OVERALL MASSING AND CHARACTER. FOR DESIGN DETAILS, DIMENSIONS, AND TECHNICAL INFORMATION, REFER TO THE FLOOR PLANS AND ELEVATIONS.



PRELIMINARY - NOT FOR CONSTRUCTION OR PERMITTING

Project Name

SHERWOOD **OLD TOWN APARTMENTS**

Project Address

15665 SW WILLAMETTE SHERWOOD, OR 97140









MAIN LOBBY ENTRY

SW COLUMBIA

EXISTING CROSSWALK

4 NE ELEVATION
G003






set issue date: 8/22/25

sheet name:

3D IMAGES

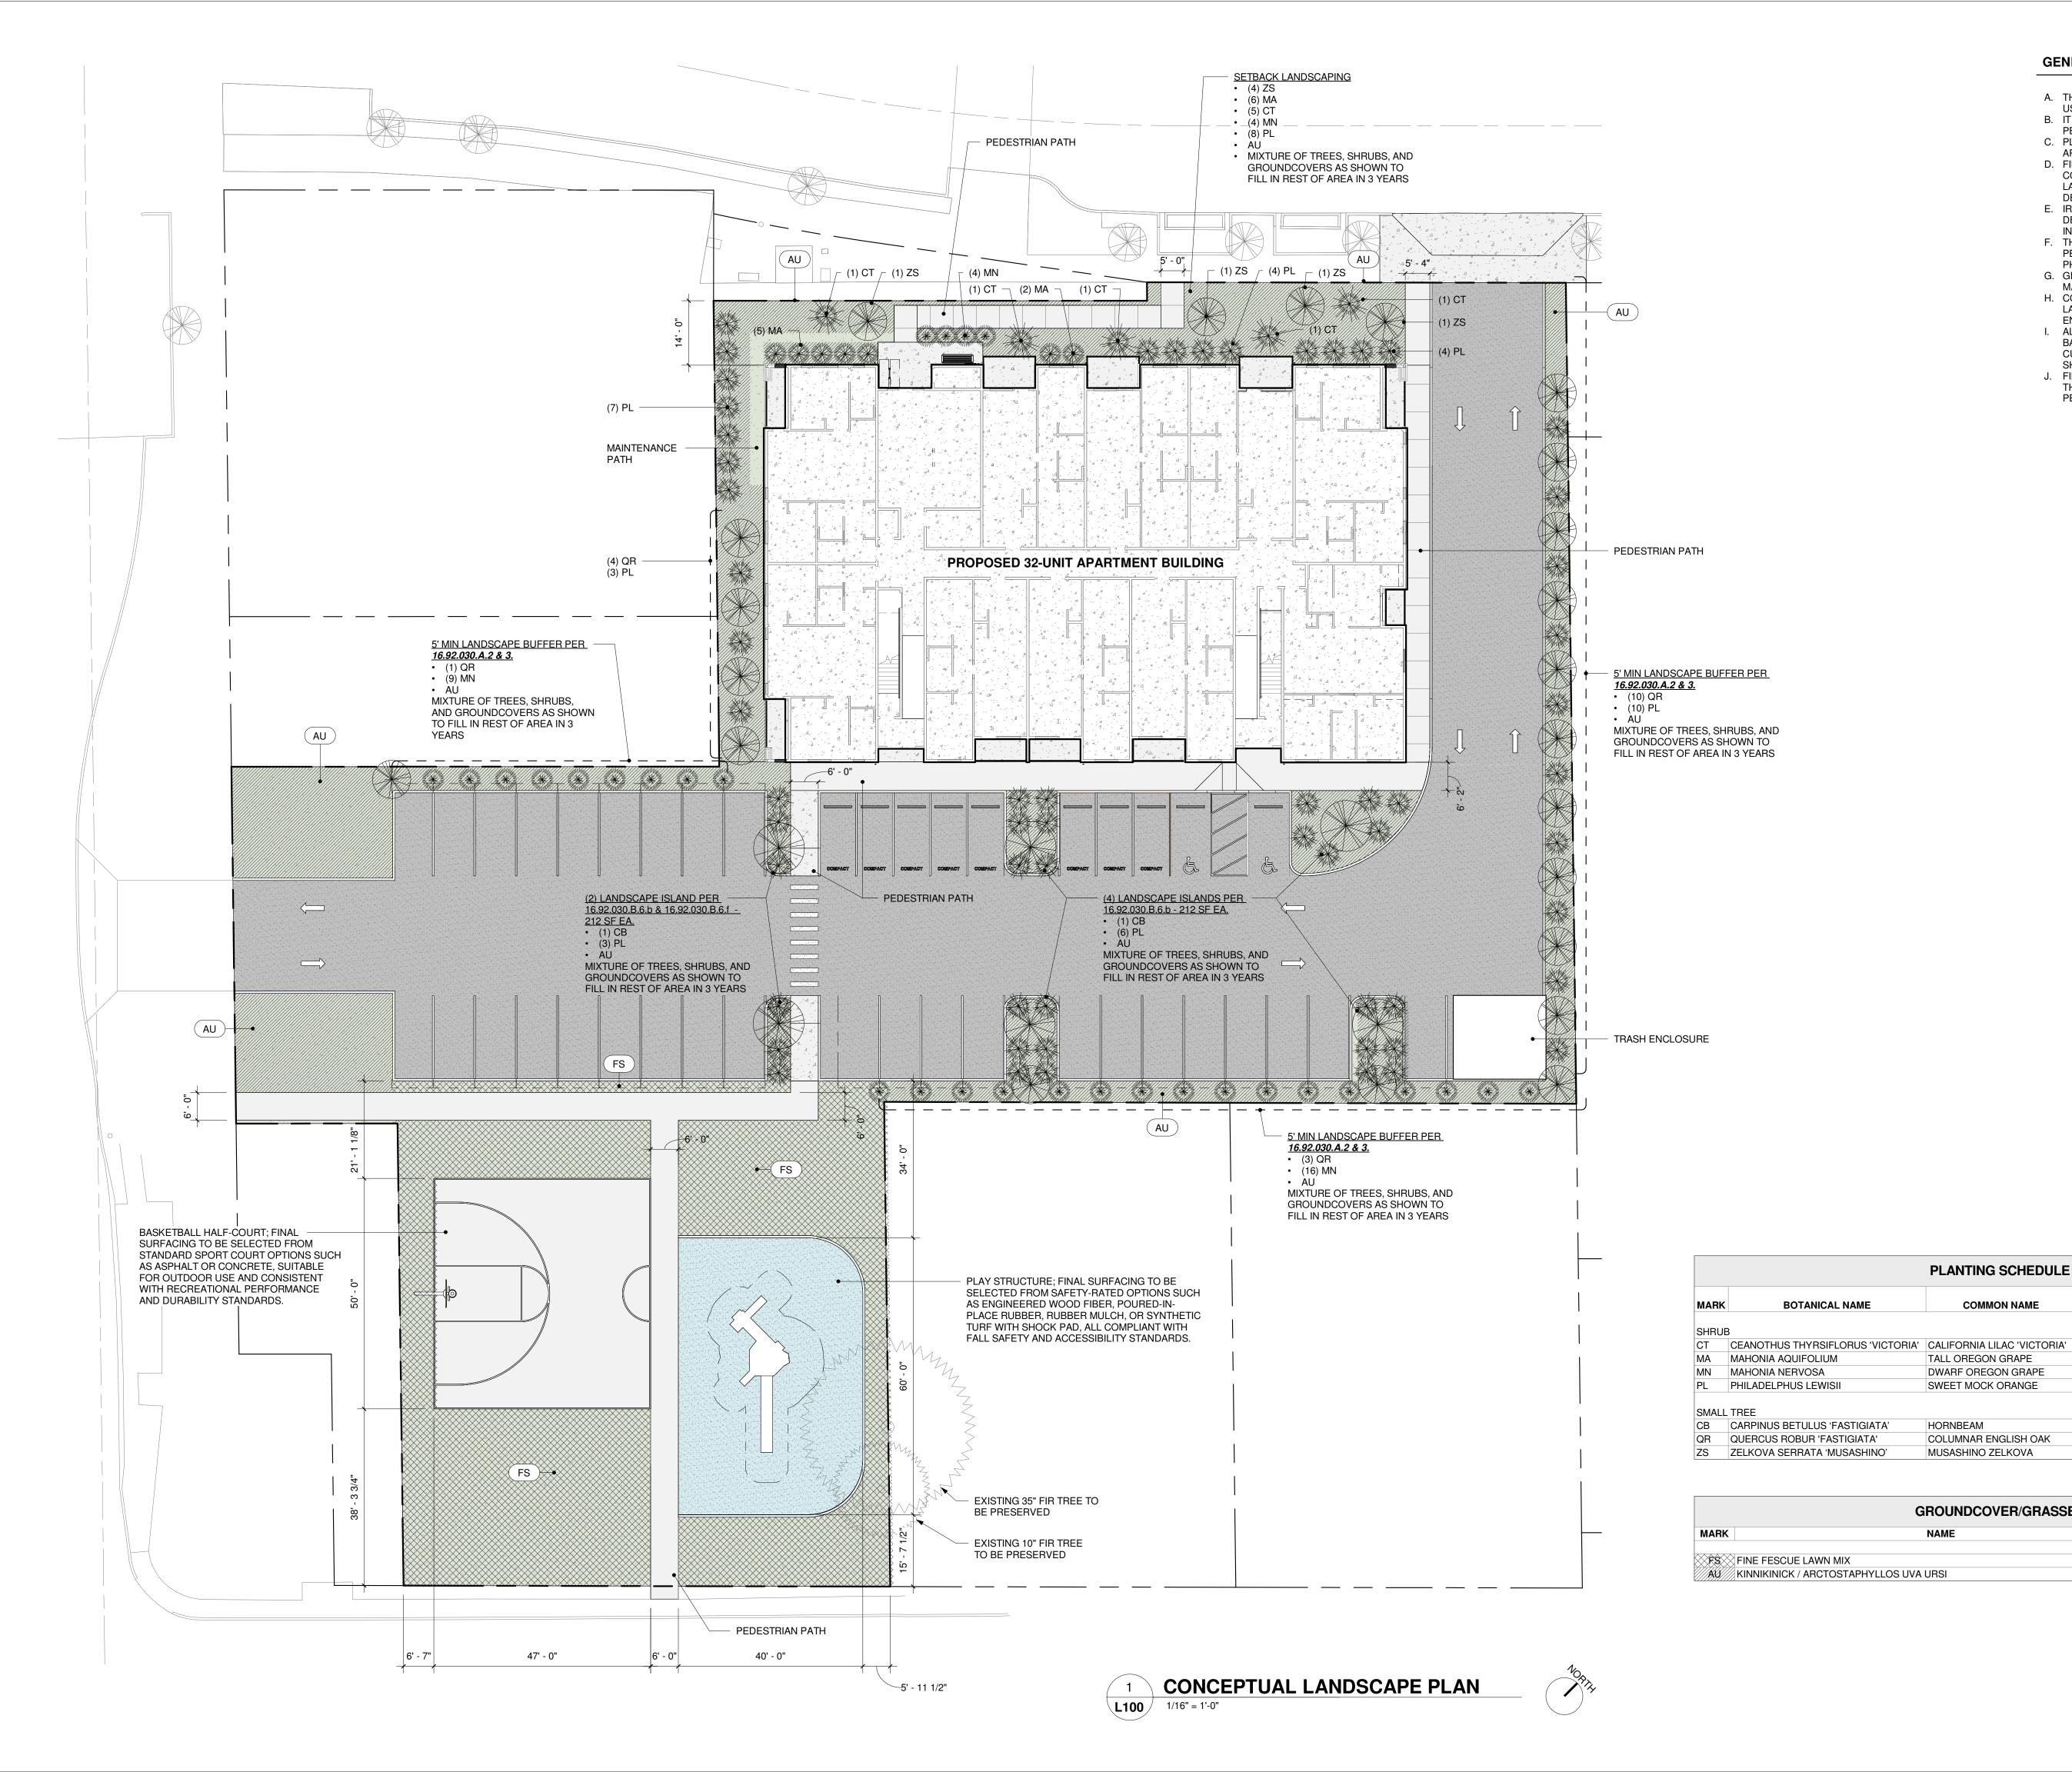

GENERAL NOTES - LANDSCAPE PLAN

- A. THIS PLAN IS CONCEPTUAL AND INTENDED FOR LAND USE REVIEW PURPOSES ONLY.
- B. IT IS NOT INTENDED FOR CONSTRUCTION,
- PERMITTING, OR FINAL DOCUMENTATION.
- C. PLANT SPECIES, SPACING, AND QUANTITIES SHOWN ARE ILLUSTRATIVE ONLY. D. FINAL PLANT SELECTION AND LAYOUT ARE TO BE
- CONFIRMED AND SPECIFIED BY A LICENSED LANDSCAPE ARCHITECT OR QUALIFIED LANDSCAPE DESIGNER. E. IRRIGATION DESIGN, SOIL PREPARATION, PLANTING
- DETAILS, AND INSTALLATION METHODS ARE NOT INCLUDED IN THIS PLAN. F. THESE ELEMENTS WILL BE DEVELOPED IN THE
- PERMIT AND CONSTRUCTION DOCUMENTATION PHASES.
- G. GRADING, DRAINAGE, AND STORMWATER MANAGEMENT ARE NOT ADDRESSED IN THIS PLAN.
- H. COORDINATION WITH THE CIVIL ENGINEER AND LANDSCAPE ARCHITECT IS REQUIRED FOR FINAL SITE ENGINEERING.
- I. ALL CODE COMPLIANCE INTERPRETATIONS ARE BASED ON PRELIMINARY UNDERSTANDING OF CURRENT ZONING REGULATIONS (CITY OF SHERWOOD CHAPTER 16.92).
- J. FINAL COMPLIANCE REVIEW AND CONFIRMATION ARE THE RESPONSIBILITY OF THE DESIGN TEAM DURING PERMITTING.

PLANTING SCHEDULE

TALL OREGON GRAPE

DWARF OREGON GRAPE

COLUMNAR ENGLISH OAK

GROUNDCOVER/GRASSES

MUSASHINO ZELKOVA

SWEET MOCK ORANGE

HORNBEAM

NAME

Attune Architecture LLC 7888 SE Jefferson St. Milwaukie, OR 97267

PRELIMINARY - NOT FOR CONSTRUCTION OR PERMITTING

Project Name

SHERWOOD **OLD TOWN APARTMENTS**

Project Address

15665 SW WILLAMETTE SHERWOOD, OR 97140

EVERGREEN/

SPACING

2' O.C.

QTY SIZE SPACING DECIDUOUS

2 GAL AS SHOWN

7 2 GAL AS SHOWN 29 2 GAL AS SHOWN

58 2 GAL AS SHOWN

6 2" CAL AS SHOWN

18 2" CAL AS SHOWN

4 2" CAL AS SHOWN

QTY


4538 SF

539 SF

set issue date: 8/22/25

sheet name:

LANDSCAPE PLAN

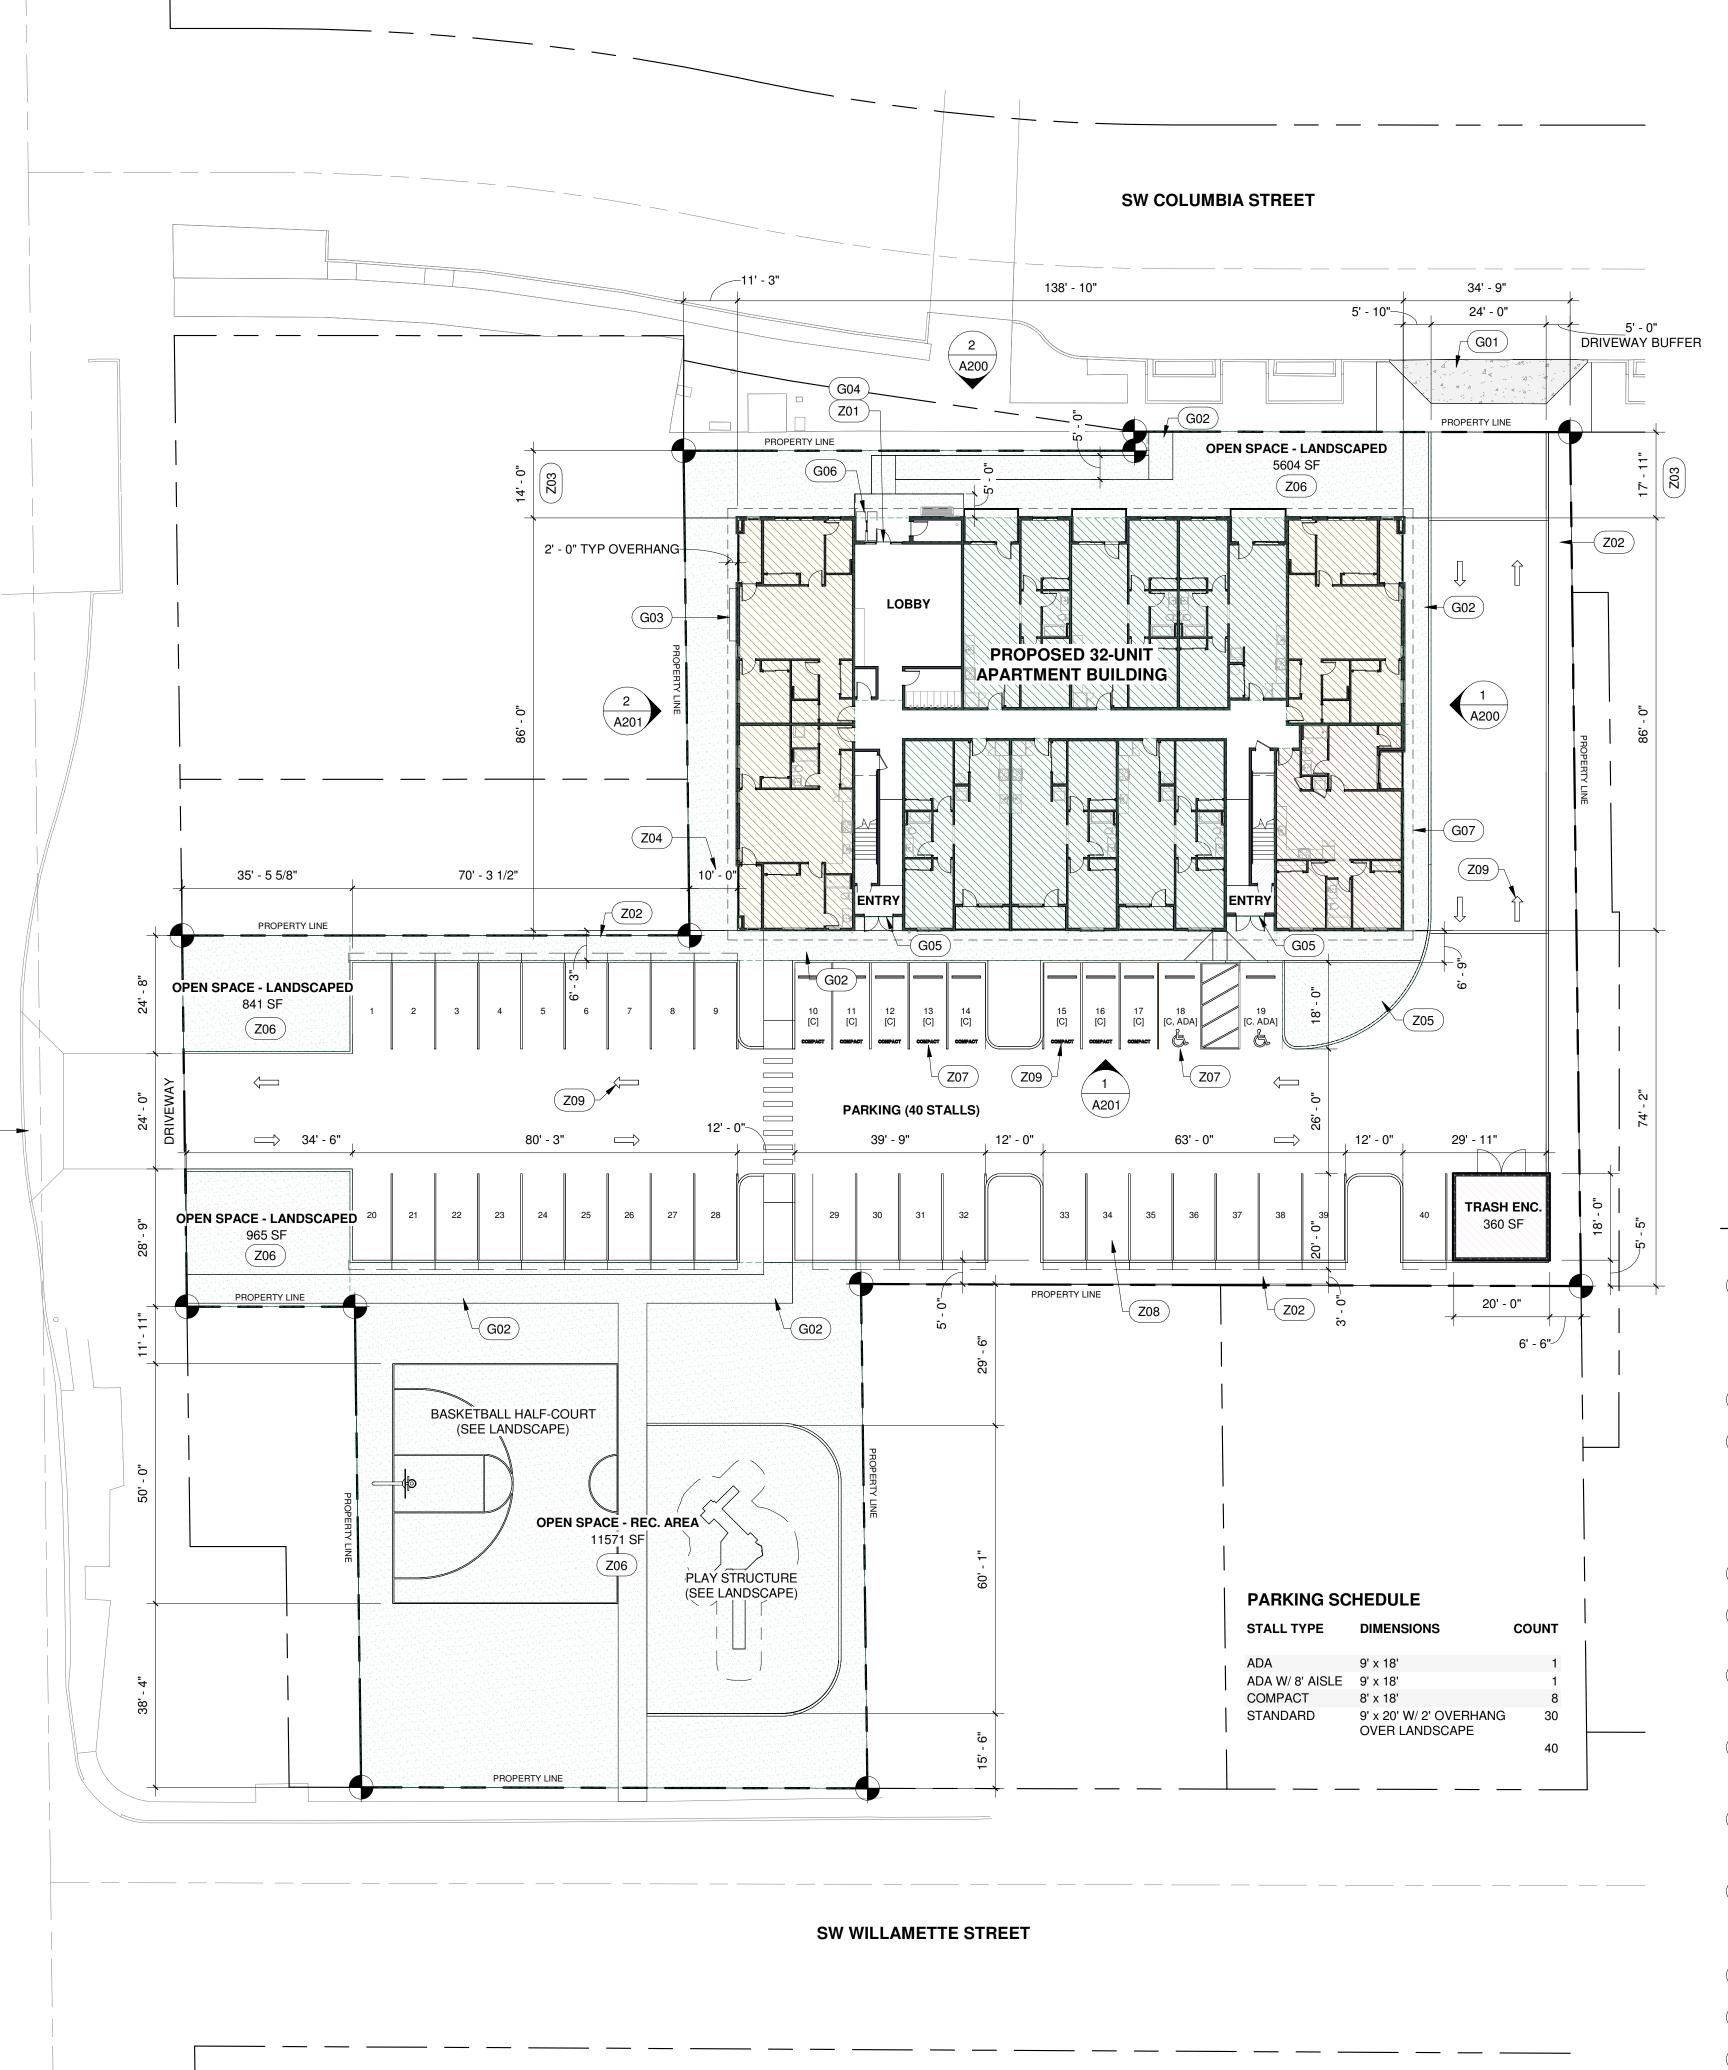





OPEN AREA SCHEDULE

OPEN SPACE - LANDSCAPED		7410 S
OPEN SPACE - REC. AREA		11571 S
TOTAL		18980 S
REQUIRED TOTAL OPEN SPACE AREA):	(20% OF SITE	9932 S
REQUIRED TO BE RECREATION	AREA (50%):	4966 S
UNIT TYPE COUNT		
UNIT TYPE	AREA	COUI
2-BED, 1-BATH	<varies></varies>	

1132 SF

AREA

BUILDING AREA SCHEDULE

2-BED, 2-BATH

3-BED, 2-BATH

TOTAL

NAME	UNIT TYPE	AREA
LEVEL 01-B		
CORRIDOR & STAIRS		1344 SF
LOBBY, LOUNGE, STORAGE		768 SF
UNIT 101	2-BED, 2 BATH	1050 SF
UNIT 102	2-BED, 2 BATH	1050 SF
UNIT 103	2-BED, 1-BATH	900 SF
UNIT 104	2-BED, 1-BATH	900 SF
UNIT 105	2-BED, 1-BATH	900 SF
JNIT 106	2-BED, 1-BATH	900 SF
UNIT 108	2-BED, 1-BATH	900 SF
JNIT 109	2-BED, 1-BATH	877 SF
UNIT 110	2-BED, 2 BATH	1050 SF
UNIT 111	3-BED, 2 BATH	1132 SF
SUBTOTAL		11770 SF
LEVEL 02		
CORRIDOR & STAIRS		1003 SF
UNIT 201	2-BED, 2 BATH	1050 SF
UNIT 202	2-BED, 2 BATH	1050 SF
UNIT 203	2-BED, 1-BATH	900 SF
INIT 004	0 DED 1 DATH	077 CF

ORRIDOR & STAIRS		1003 8
NIT 201	2-BED, 2 BATH	1050 5
NIT 202	2-BED, 2 BATH	1050 5
NIT 203	2-BED, 1-BATH	900 8
NIT 204	2-BED, 1-BATH	877 8
NIT 205	2-BED, 1-BATH	900 8
NIT 206	2-BED, 1-BATH	900 8
NIT 207	2-BED, 1-BATH	900 8
NIT 208	2-BED, 1-BATH	900 8
NIT 209	2-BED, 1-BATH	877 9
NIT 210	2-BED, 2 BATH	1050 \$
NIT 211	3-BED, 2 BATH	1132 9
UBTOTAL		11538 9
EVEL 03		
ORRIDOR & STAIRS		1016 9

LEVEL 03		
CORRIDOR & STAIRS		1016
UNIT 301	2-BED, 2 BATH	1050
UNIT 302	2-BED, 2 BATH	1050
UNIT 303	2-BED, 1-BATH	900
UNIT 304	2-BED, 1-BATH	877
UNIT 305	2-BED, 1-BATH	900
UNIT 306	2-BED, 1-BATH	900
UNIT 307	2-BED, 1-BATH	900
UNIT 308	2-BED, 1-BATH	900
UNIT 309	2-BED, 1-BATH	877
UNIT 310	2-BED, 2 BATH	1050
UNIT 311	3-BED, 2 BATH	1132
SUBTOTAL		11551
BUILDING TOTAL		34859

KEY NOTES

ZONING CODE RELATED

- COMPLIANCE WITH SZCDC 16.90.020.D: PROPOSED STREET-FACING LOBBY ENTRANCE DISTINGUISHED BY A METAL CANOPY, ENHANCED DOOR HEIGHT, AND WOODFINISH CLADDING TO EMPHASIZE PEDESTRIAN ORIENTATION AND ENTRY HIERARCHY. INCLUDES BENCH SEATING TO ENHANCE STREET FRONTAGE. SEE ELEVATIONS AND NARRATIVE FOR ADDITIONAL DETAIL.
- Z02 5' MIN PERIMETER LANDSCAPE BUFFER PER 16.92.030.A.2 & 3. REFERENCE LANDSCAPE PLANS FOR FURTHER DETAIL.
- COMPLIANCE WITH SZCDC 16.90.020.D.7.B: BUILDING MAINTAINS A CONSISTENT FRONTAGE APPROX. 17'-11" FROM SW COLUMBIA STREET TO SUPPORT PEDESTRIAN ORIENTATION WHILE RESPECTING SITE CONSTRAINTS. THE STANDARD DOES NOT REQUIRE A FIXED BUILD-TO LINE; DESIGN MEETS INTENT THROUGH CONTINUOUS FRONTAGE, DEFINED ENTRIES, AND STREET-FACING LOBBY. SEE NARRATIVE FOR DETAIL.
- PROPOSED SIDE SETBACK, SEE ZONING CODE SUMMARY FOR CALCULATION FOR MINIMUM REQUIRED SETBACK.
- (6) PROPOSED PARKING LANDSCAPE ISLANDS TO MEET THE REQUIREMENTS OF 16.92.030.B.6.b. SEE LANDSCAPE AND NARRATIVE FOR FURTHER DETAIL.
- OPEN SPACE, LANDSCAPED AND RECREATIONAL, AS REQUIRED BY 16.140.020. SEE OPEN AREA SCHEDULE FOR TOTAL AREAS AND REQUIRED AREAS. SEE LANDSCAPE PLAN AND NARRATIVE FOR FURTHER DETAIL.
- COMPACT & ADA STALLS: DIMENSIONS PER PARKING SCHEDULE. 4" HIGH MIN. WHEEL STOP LOCATED 3' FROM FRONT OF STALL TO PREVENT VEHICLE OVERHANG INTO PEDESTRIAN PATH, PER SZCDC 16.94.020.B.3.
- Z08 STANDARD STALLS: 18' PAVED DEPTH WITH 2' OVERHANG INTO 3' LANDSCAPE BUFFER; CURB ACTS AS WHEEL STOP IN LIEU OF FREESTANDING STOP, PER SZCDC 16.94.020.B.3.
- Z09 PARKING STRIPING & SIGNAGE: ALL STALLS, DRIVE AISLES, AND DIRECTIONAL FLOW MARKED PER SZCDC 16.94.010.F.

GENERAL

- G01 PROPOSED CURBCUT/ DRIVEWAY ACCESS. SEE CIVIL FOR FURTHER DETAIL.
- G02 PEDESTRIAN ACCESS WITH 5' MINIMUM WIDTH. SEE LANDSCAPE PLAN FOR FURTHER DETAIL.
- G03 PROPOSED LOCATION FOR ELECTRICAL METER BANK. SEE CIVIL FOR FURTHER DETAIL.
- G04 PROPOSED MAIN/LOBBY ENTRANCE.
- G05 PROPOSED SECONDARY BUILDING ENTRANCE.
- (G06) 2 SHORT TERM BIKE PARKING SPOTS (1 STAPLE RACK)
- G07 LINE OF ROOF ABOVE.

SUMMARY OF SCOPE OF WORK

NEW 32-UNIT APARTMENT BUILDING ON EXISTING UNDEVELOPED LOT AND ASSOCIATED SITE WORK THAT INCLUDES A 40-STALL PARKING LOT, PEDESTRIAN PATHS, OUTDOOR RECREATION AREAS AND LANDSCAPE AREAS.

ZONING SUMMARY

SITE INFO	
APPLICABLE ZONING:	SHERWOOD MUNICIPAL CODE (SMC), TITLE 16
PROPERTY ID:	2S132BD00400
LOT SIZE:	1.14 ACRES (49,659.4 SF)
LAND USE ZONING:	HDR
OVERLAY(S):	OLD TOWN OVERLAY

BASE ZONE REGULATIONS (SMC 16.12)				
DENSITY:	ALLOWED BASE DENSITY: 16.8 - 24 UNITS PER ACRE OR 27.36			
	PROPOSED DENSITY: 32 UNITS (+4 UNITS VIA MANDATORY ADJUSTMENT PROPOSED, SEE NARRATIVE)			
MAXIMUM HEIGHT:	40' OR 3 STORIES PROPOSED HEIGHT: 31' - 1" (LOW-SLOPE ROOF)			
SETBACKS	DESCRIPTION	REQUIRED	PROPOSED	
(16.12.20):	FRONT	14' MIN	14' & 17'-11"	
	SIDE	8' - 6 9/16" MIN*	10' @ SW & 34'-9" @ NE	
	REAR	20' MIN	74'-2"	
	*SIDE (PER 16.68): 8' - 6 9/16''			
CALC: 31.1' BLDG HEIGHT		EIGHT - 24' = 7.1'; 7.	1'*.5 = 3.55'; 5'+3.55' = <u>8.55' (8</u>	<u>8' - 6 9/16")</u>

PRELIMINARY BUILDING CODE SUMMARY

CHAPTER 1: ADMINISTRATION		
PROJECT ADDRESS:	15665 SW WILLAMETTE SHERWOOD, OR 97140	
JURISDICTIONAL AUTHORITY:	CITY OF SHERWOOD	
APPLICABLE CODE:	2022 OSSC	
APPLICABLE ZONING:	CITY OF SHERWOOD MUNICIPAL CODE, TITLE 16	
107.2.1:	SUMMARY OF AREAS BY OCCUPANCY	
	GROUP R-2: SEE OCCUPANCY SCHEDULE	

304.1	PROPOSED OCC	CUPANCIES:	R-2	
CHAPTER 5 GENERAL BUILDING HEIGHTS AND AREAS				
HEIGHTS AND STORIES (PER TABLE 504.3 & 504.4)				
DESCRIPTION	ALLOWABLE	PROPOSED	CODE REFERENCE / NOTES	
BUILDING HEIGH	T 60'-0"	31'-1"	TYPE VB WITH NFPA 13R SPRINKLER INCREASE (504.3, NOTE D)	
NUMBER OF STO	RIES 3 STORIES	3 STORIES	TYPE VB WITH NFPA 13R SPRINKLER	

INCREASE (504.4, NOTE D)

DESCRIPTION	VALUE/AREA	CODE REFERENCE / NOTES
BASE ALLOWABLE AREA TYPE VB, R-2)	7,000 SF	OSSC TABLE 506.2
OTAL BUILDING PERIMETER	452.5'	§506.3.2
OPEN PERIMETER ≥30'	366.5'	MEASURED PER §506.3.2
% OPEN PERIMETER	80.9%	366.5 ÷ 452.5
FRONTAGE INCREASE FACTOR (IF)	0.75	$[(F/P - 0.25) \times W/30], MAX = 0.75$
AREA INCREASE FROM FRONTAGE	5,250 SF	7,000 × 0.75
ALLOWABLE AREA PER STORY	12,250 SF	7,000 + 5,250
MAXIMUM TOTAL BUILDING AREA (3 STORIES)	36,750 SF	12,250 × 3

SPRINKLER INCREASE NOT

1. BUILDING IS FULLY SPRINKLERED PER NFPA 13R.

CHAPTER 3: USE AND OCCUPANCY CLASSIFICATION

2. HEIGHT AND STORY INCREASES APPLIED PER TABLE 504.3 AND 504.4, FOOTNOTE D.
 3. FRONTAGE INCREASE APPLIED PER §506.3.2 (OPEN SPACE ≥30').

CHAPTER 6	TYPES OF CONSTRUCTION	
CONSTRUCTION TYPE:	VB	
TABLE 601	REQUIRED FIRE RESISTIVE RATING	s
	PRIMARY STRUCTURAL FRAME EXTERIOR BEARING WALLS INTERIOR BEARING WALLS EXTERIOR NON-BEARING WALLS INTERIOR NON-BEARING WALLS FLOOR CONSTRUCTION ROOF CONSTRUCTION	0 HOUR 0 HOUR 0 HOUR SEE "FIRE RESISTANCE RATING" BELOW 0 HOUR - UNLESS OTHERWISE NOTED 0 HOUR 0 HOUR
TABLE 602	FIRE-RESISTANCE RATING FOR EXT	TERIOR NON-BEARING WALLS
	X < 5 FT = 5 FT ≤ X < 10 FT 10 FT ≤ X < 30 FT 30 FT ≤ X	= 1 HR = 1 HR = 0 HR = 0 HR

ACCESSIBILITY		
ACCESSIBLE DWELLING UNITS IN GROUP R-2		
TOTAL DWELLING UNITS:	32 (10 @ LEVEL 1, 11 @ LEVEL 2, 11 @ LEVEL 3)	
TYPE A UNITS REQUIRED:	1 (2% BUT NOT LESS THAN 1; 2% OF 32 = 0.64)	
TYPE B UNITS REQUIRED:	10* (ALL UNITS AT LEVEL 1 / ON ACCESSIBLE ROUTE)	
	* UPPER-STORY UNITS ARE EXEMPT FROM ACCESSIBILITY REQUIREMENTS PER OSSC §1107.7.	
	ACCESSIBLE DWELLING UNITS: TYPE A UNITS REQUIRED:	



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Project Name

SHERWOOD OLD TOWN APARTMENTS

Project Address
15665 SW WILLAMETTE
SHERWOOD, OR 97140

revision:

set issue date: 8/22/25

sheet name:

SITE PLAN & ZONING SUMMARY

\$heet number:

GENERAL NOTES - ELEVATIONS

- A. THESE ELEVATIONS ARE PRELIMINARY AND INTENDED FOR SCHEMATIC DESIGN AND/OR LAND USE REVIEW PURPOSES ONLY. THEY ARE NOT INTENDED FOR CONSTRUCTION OR PERMIT DOCUMENTATION.
- B. BUILDING HEIGHTS, MASSING, AND VERTICAL DIMENSIONS ARE APPROXIMATE AND SUBJECT TO REFINEMENT DURING DESIGN DEVELOPMENT AND COORDINATION WITH STRUCTURAL AND CIVIL DISCIPLINES.
- C. WINDOW AND DOOR SIZES, TYPES, AND CONFIGURATIONS ARE ILLUSTRATIVE. FINAL DESIGN, DETAILING, AND PERFORMANCE CRITERIA WILL BE CONFIRMED DURING CONSTRUCTION DOCUMENTATION.
- D. FACADE ELEMENTS SUCH AS CANOPIES, RAILINGS, LIGHTING, SIGNAGE, AND TRIM ARE CONCEPTUAL AND MAY CHANGE DURING FURTHER DESIGN DEVELOPMENT.
- E. MATERIALS, COLORS, AND FINISHES SHOWN ARE CONCEPTUAL AND SUBJECT TO REFINEMENT. FINAL SELECTIONS MAY CHANGE DURING THE DESIGN AND PERMITTING PROCESS AND SHOULD NOT BE CONSIDERED BINDING CONDITIONS OF APPROVAL.
- F. ALL REPRESENTATIONS OF EXTERIOR DESIGN ARE FOR GENERAL CHARACTER AND MASSING PURPOSES ONLY. THE FINAL ARCHITECTURAL DESIGN WILL BE DEVELOPED BASED ON CODE COMPLIANCE, TECHNICAL COORDINATION, AND JURISDICTIONAL FEEDBACK.



SEE SHEETS A200 AND A201 FOR ADDITIONAL DETAIL

GLAZING AREA CALCULATION REGARDING SZCDC 16.90.020.D.7.d

FACADE AREA: 4,106 SF
WINDOWS AND DOORS (SHOWN HATCHED): 1,172 SF

• CALC: 1,172 SF / 4,106 SF = **28.5**%





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SHERWOOD **OLD TOWN APARTMENTS**

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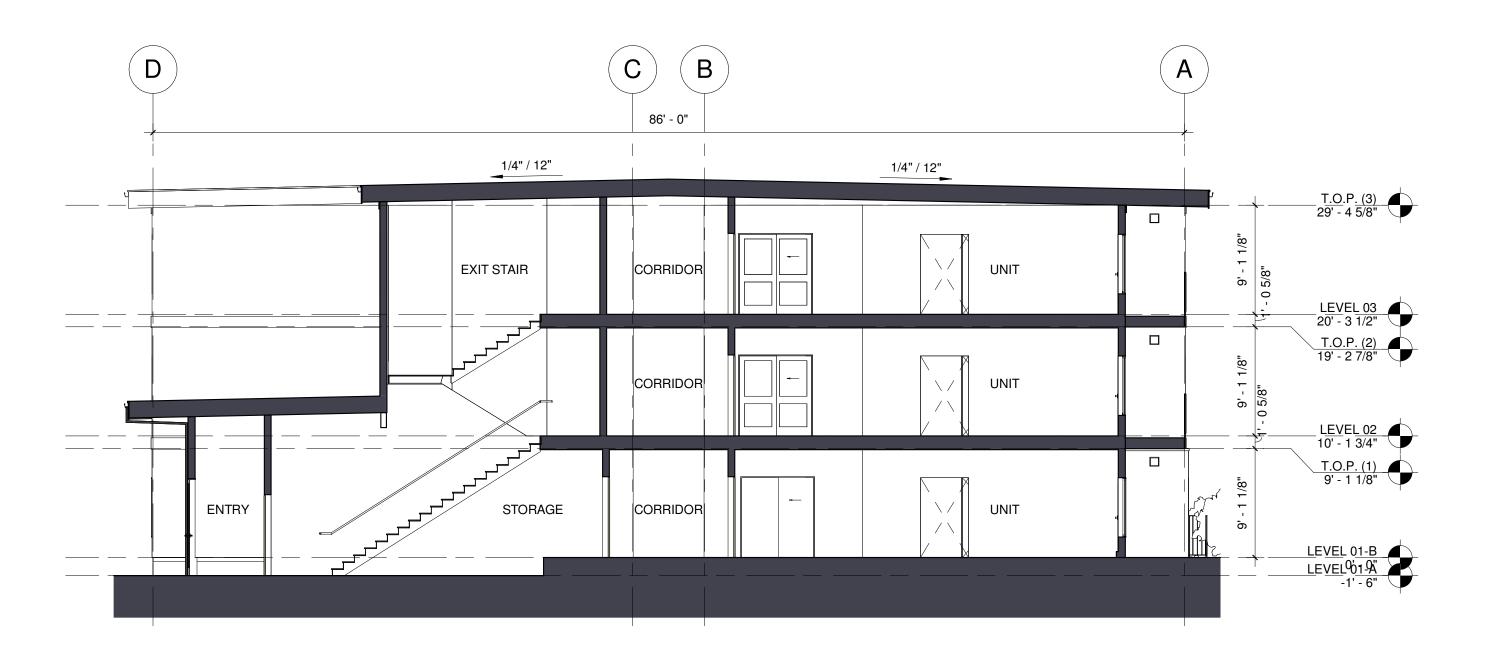
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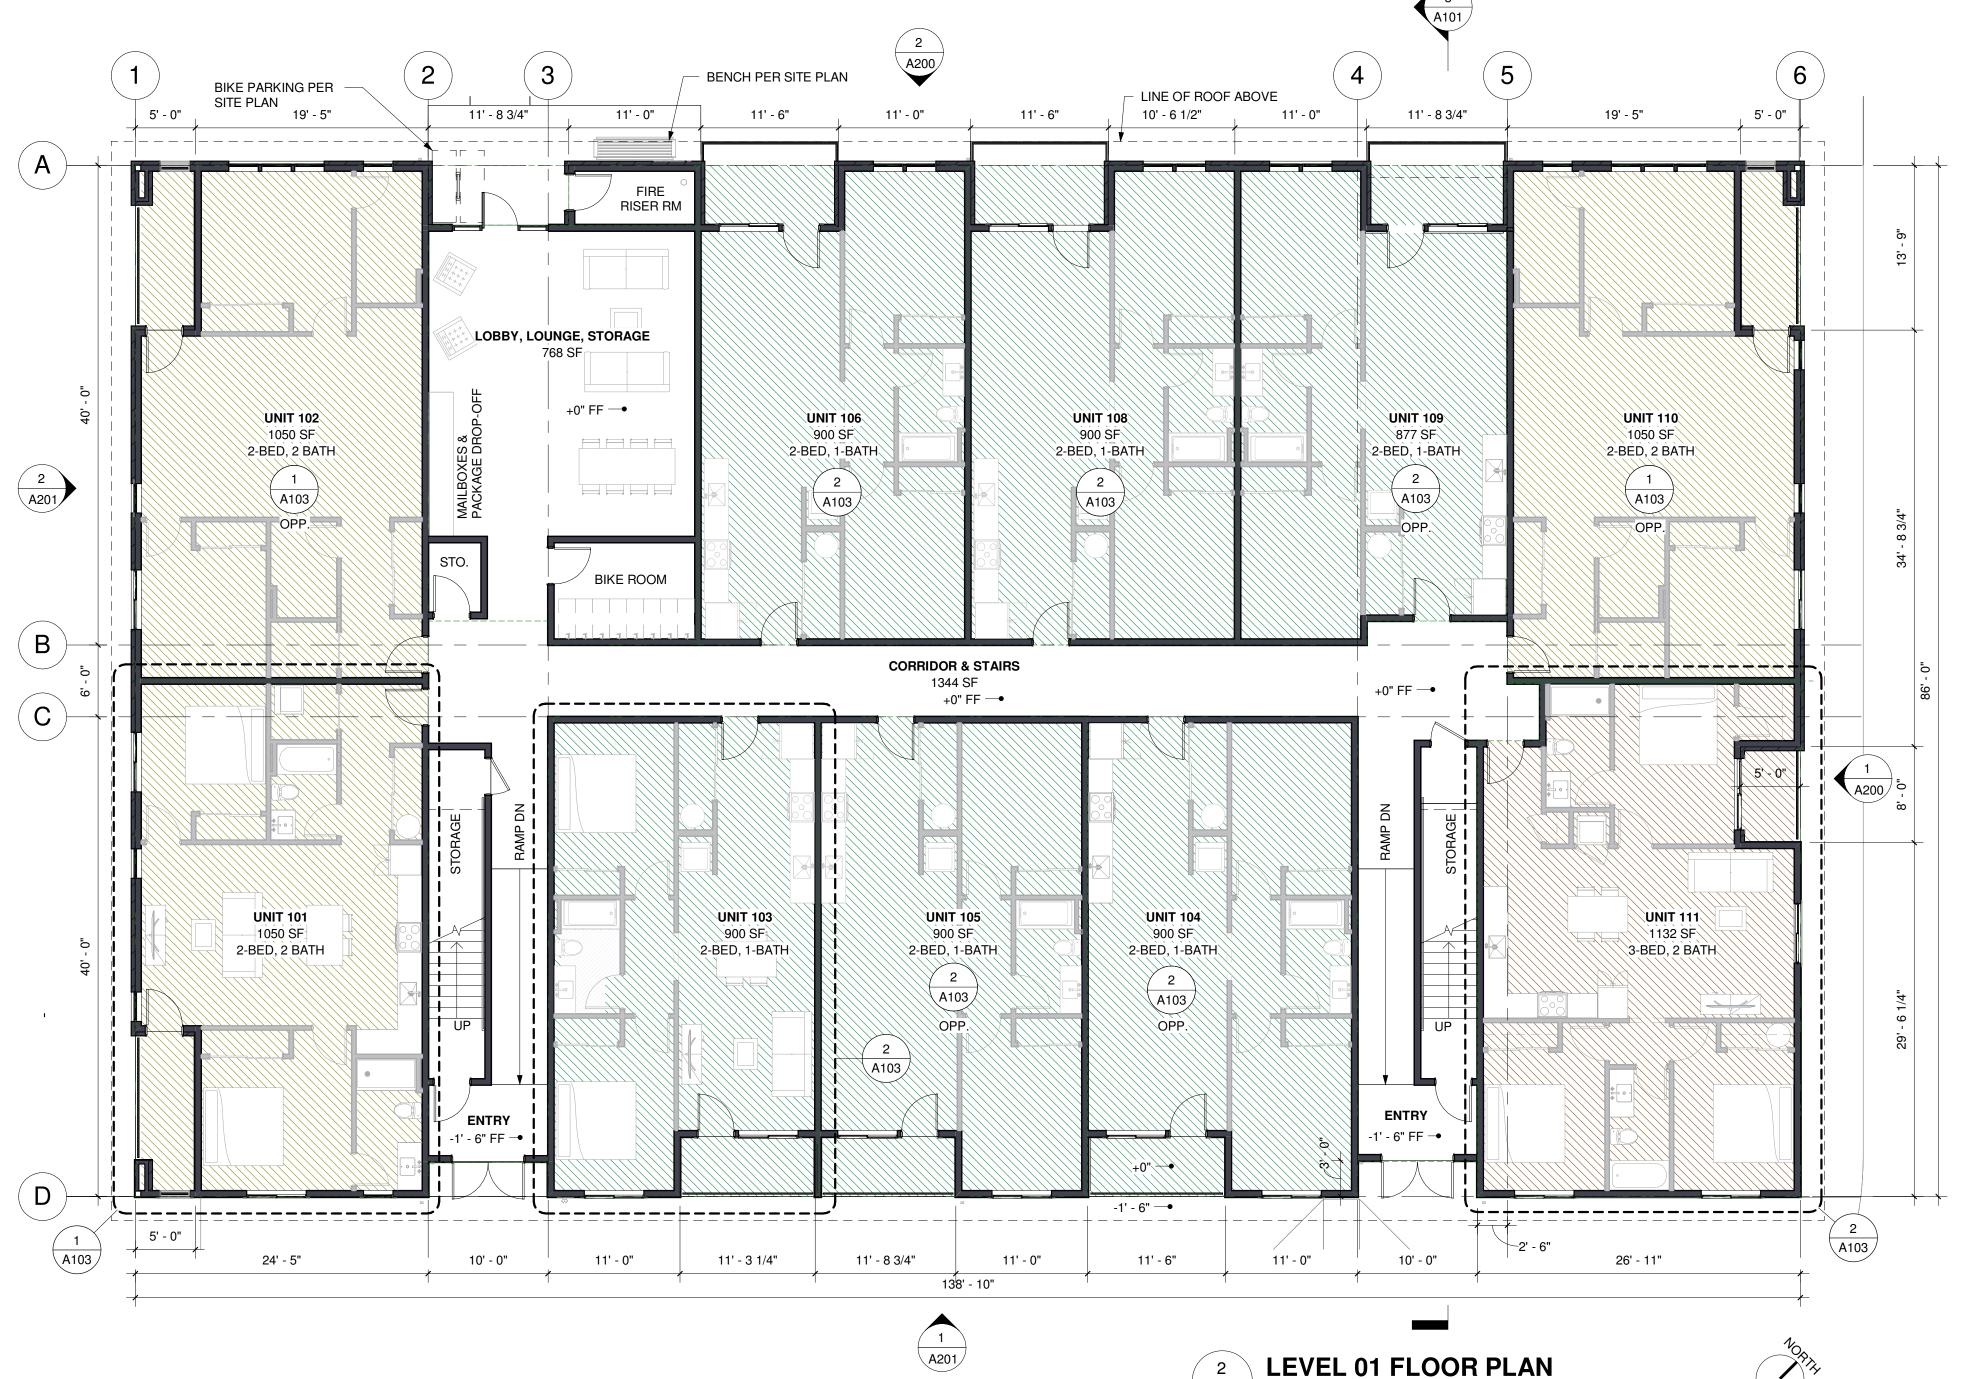
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8/22/25

ZONING **ELEVATION**



3 CROSS SECTION @ GRID 4.5 A101 1/8" = 1'-0"



A101

1/8" = 1'-0"

GENERAL NOTES - FLOOR PLAN

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- F. FINAL SELECTIONS WILL BE COORDINATED WITH THE CLIENT AND DESIGN TEAM IN LATER PHASES.
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 I. FURNITURE AND EQUIPMENT SHOWN IS NOT FINAL.
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AND CLEARANCES.

Attune Architecture LLC 7888 SE Jefferson St. Milwaukie, OR 97267

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Project Name

SHERWOOD OLD TOWN APARTMENTS

Project Address

15665 SW WILLAMETTE SHERWOOD, OR 97140

UNIT TYPE COUNT

UNIT TYPE	AREA	COUN
2-BED, 1-BATH	<varies></varies>	2
2-BED, 2-BATH	1050 SF	
3-BED, 2-BATH	1132 SF	
TOTAL		3

BUILDING AREA SCHEDULE

UNIT 305

UNIT 306

UNIT 307

UNIT 308

UNIT 309

UNIT 310

UNIT 311

SUBTOTAL

BUILDING TOTAL

NAME	UNIT TYPE	AREA
LEVEL 01-B		
CORRIDOR & STAIRS		1344 SF
LOBBY, LOUNGE, STORAGE		768 SF
UNIT 101	2-BED, 2 BATH	1050 SF
UNIT 102	2-BED, 2 BATH	1050 SF
UNIT 103	2-BED, 1-BATH	900 SF
UNIT 104	2-BED, 1-BATH	900 SF
UNIT 105	2-BED, 1-BATH	900 SF
UNIT 106	2-BED, 1-BATH	900 SF
UNIT 108	2-BED, 1-BATH	900 SF
UNIT 109	2-BED, 1-BATH	877 SF
UNIT 110	2-BED, 2 BATH	1050 SF
UNIT 111	3-BED, 2 BATH	1132 SF
SUBTOTAL		11770 SF
LEVEL 02		
CORRIDOR & STAIRS		1003 SF
UNIT 201	2-BED, 2 BATH	1050 SF
UNIT 202	2-BED, 2 BATH	1050 SF
UNIT 203	2-BED, 1-BATH	900 SF
UNIT 204	2-BED, 1-BATH	877 SF
UNIT 205	2-BED, 1-BATH	900 SF
UNIT 206	2-BED, 1-BATH	900 SF
UNIT 207	2-BED, 1-BATH	900 SF
UNIT 208	2-BED, 1-BATH	900 SF
UNIT 209	2-BED, 1-BATH	877 SF
UNIT 210	2-BED, 2 BATH	1050 SF
UNIT 211	3-BED, 2 BATH	1132 SF
SUBTOTAL		11538 SF
LEVEL 03		
CORRIDOR & STAIRS		1016 SF
UNIT 301	2-BED, 2 BATH	1050 SF
UNIT 302	2-BED, 2 BATH	1050 SF
UNIT 303	2-BED, 1-BATH	900 SF
UNIT 304	2-BED, 1-BATH	877 SF

2-BED, 1-BATH

2-BED, 1-BATH

2-BED, 1-BATH

2-BED, 1-BATH

2-BED, 1-BATH

2-BED, 2 BATH

3-BED, 2 BATH

900 SF

900 SF

900 SF

877 SF

1050 SF

1132 SF

11551 SF

34859 SF

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FLOOR PLANS


sheet number:

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A102 1/8" = 1'-0"

UNIT TYPE COUNT

UNIT 306

UNIT 307

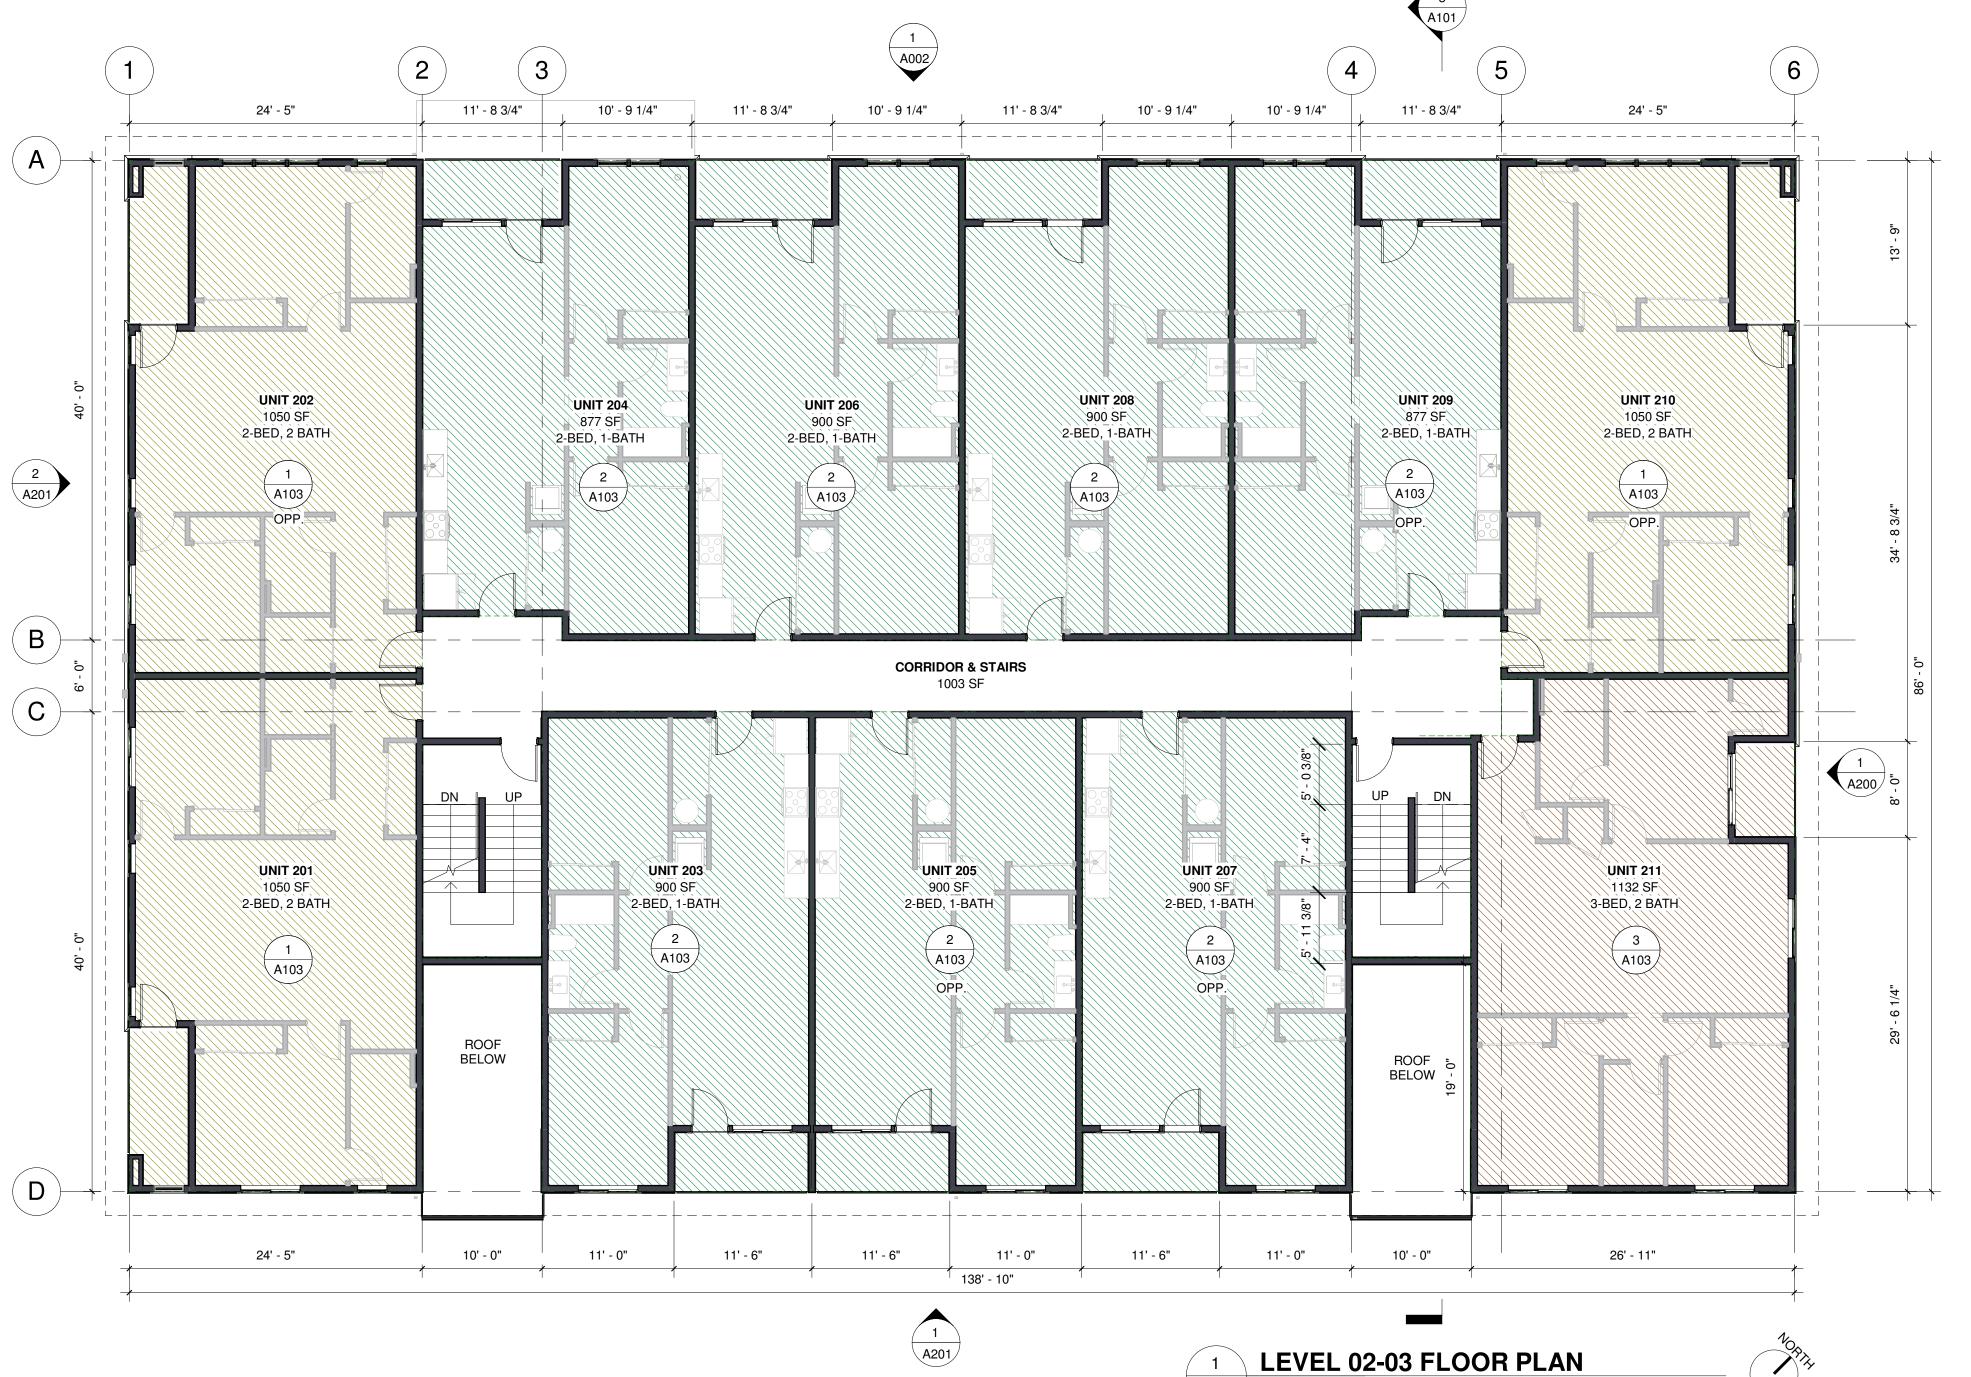UNIT 308

UNIT 309

UNIT 310

UNIT 311 SUBTOTAL

BUILDING TOTAL

UNIT TYPE	AREA	COUN
2-BED, 1-BATH	<varies></varies>	2
2-BED, 2-BATH	1050 SF	
3-BED, 2-BATH	1132 SF	
TOTAL		3

BUILDING AREA SCHEDULE

NAME	UNIT TYPE	AREA
LEVEL 01-B		
CORRIDOR & STAIRS		1344 SF
LOBBY, LOUNGE, STORAGE		768 SF
UNIT 101	2-BED, 2 BATH	1050 SF
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UNIT 105	2-BED, 1-BATH	900 SF
UNIT 106	2-BED, 1-BATH	900 SF
UNIT 108	2-BED, 1-BATH	900 SF
UNIT 109	2-BED, 1-BATH	877 SF
UNIT 110	2-BED, 2 BATH	1050 SF
UNIT 111	3-BED, 2 BATH	1132 SF
SUBTOTAL		11770 SF
LEVEL 02		
CORRIDOR & STAIRS		1003 SF
UNIT 201	2-BED, 2 BATH	1050 SF
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UNIT 204	2-BED, 1-BATH	877 SF
UNIT 205	2-BED, 1-BATH	900 SF
UNIT 206	2-BED, 1-BATH	900 SF
UNIT 207	2-BED, 1-BATH	900 SF
UNIT 208	2-BED, 1-BATH	900 SF
UNIT 209	2-BED, 1-BATH	877 SF
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UNIT 211	3-BED, 2 BATH	1132 SF
SUBTOTAL	,	11538 SF
LEVEL 03		
CORRIDOR & STAIRS		1016 SF
UNIT 301	2-BED, 2 BATH	1050 SF
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UNIT 303	2-BED, 1-BATH	900 SF
UNIT 304	2-BED, 1-BATH	877 SF
UNIT 305	2-BED, 1-BATH	900 SF
LINIT 306	2 BED 1 BATH	000 01



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Project Name

SHERWOOD **OLD TOWN APARTMENTS**

Project Address

15665 SW WILLAMETTE SHERWOOD, OR 97140

set issue date: 8/22/25

sheet name:

900 SF

900 SF

900 SF

877 SF

1050 SF

1132 SF 11551 SF

34859 SF

2-BED, 1-BATH

2-BED, 1-BATH

2-BED, 1-BATH

2-BED, 1-BATH

2-BED, 2 BATH

3-BED, 2 BATH

FLOOR PLANS

GENERAL NOTES - FLOOR PLAN

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SHERWOOD **OLD TOWN APARTMENTS**

Project Address

Attune Architecture LLC


PRELIMINARY - NOT

OR PERMITTING


FOR CONSTRUCTION


7888 SE Jefferson St. Milwaukie, OR 97267

15665 SW WILLAMETTE SHERWOOD, OR 97140

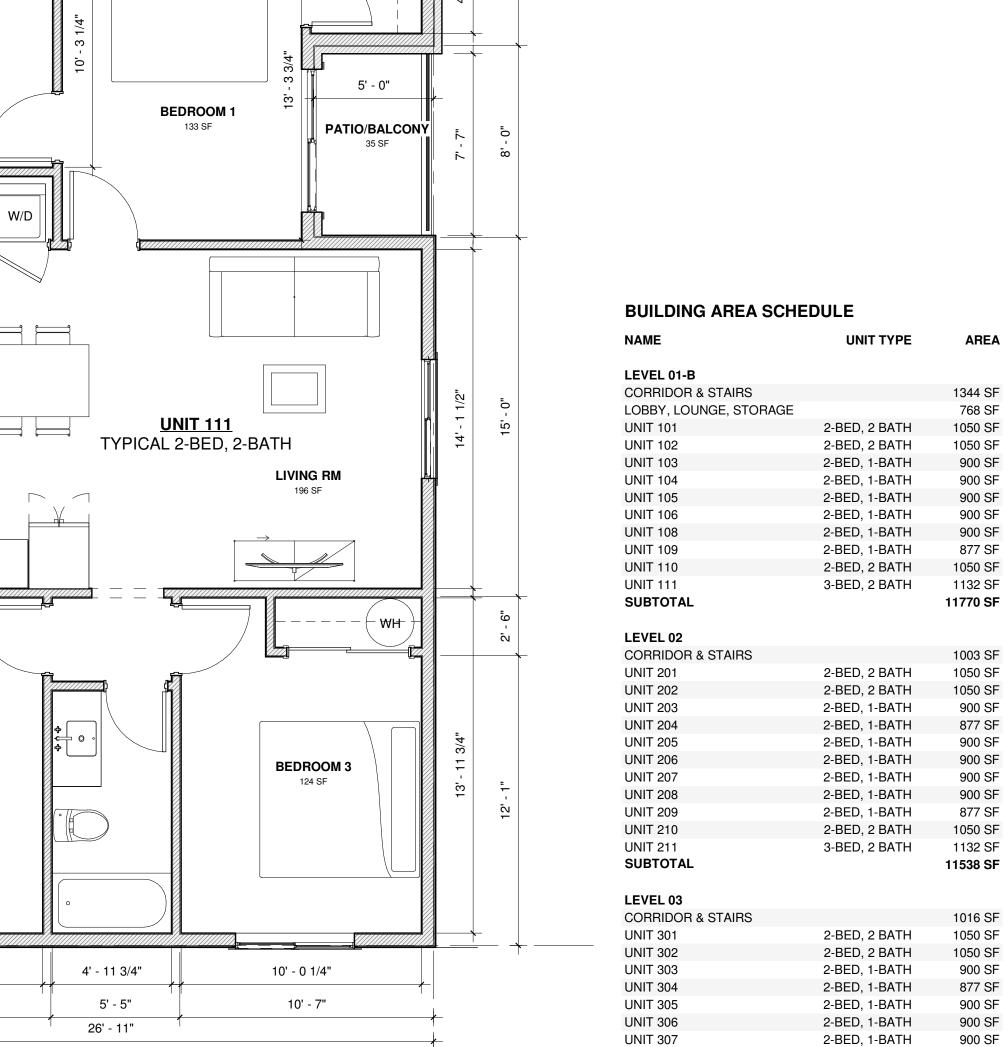

4' - 7 1/4"

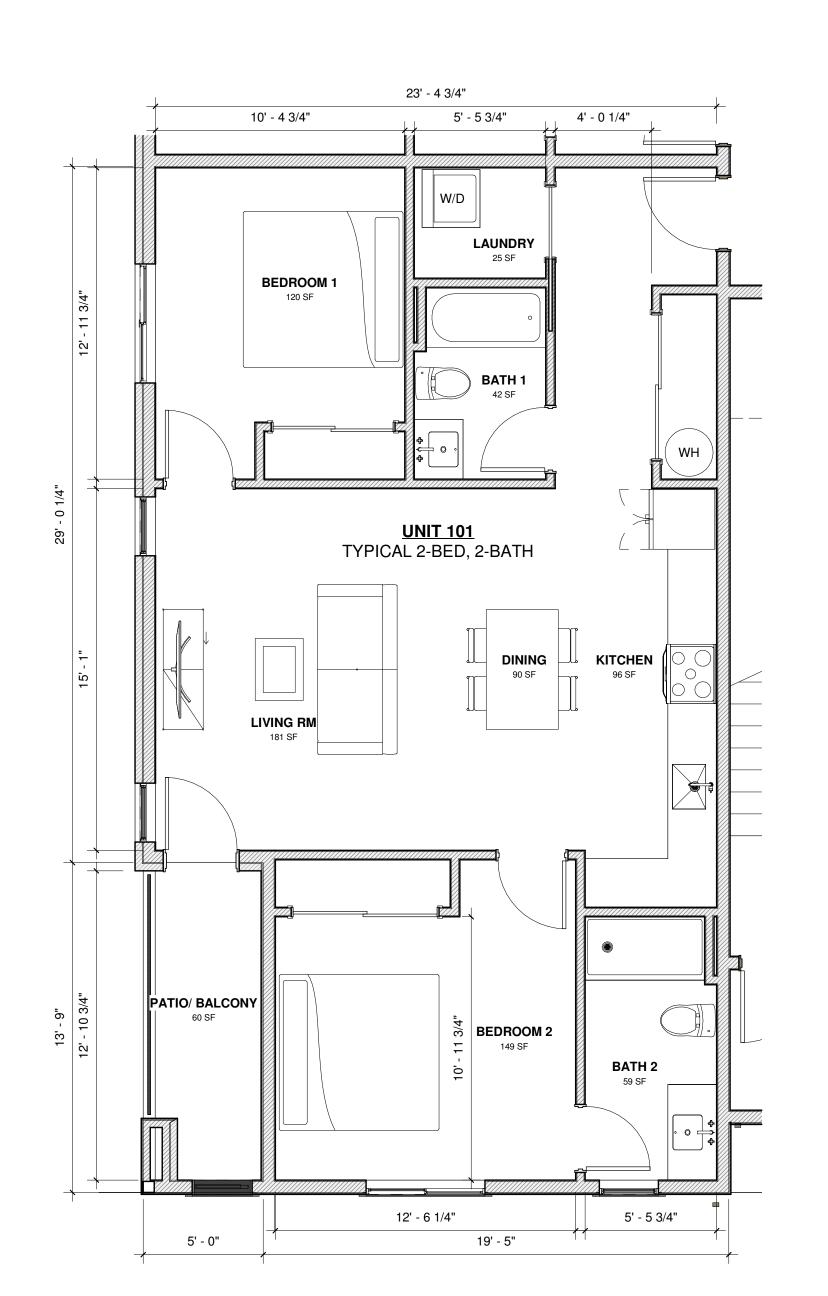

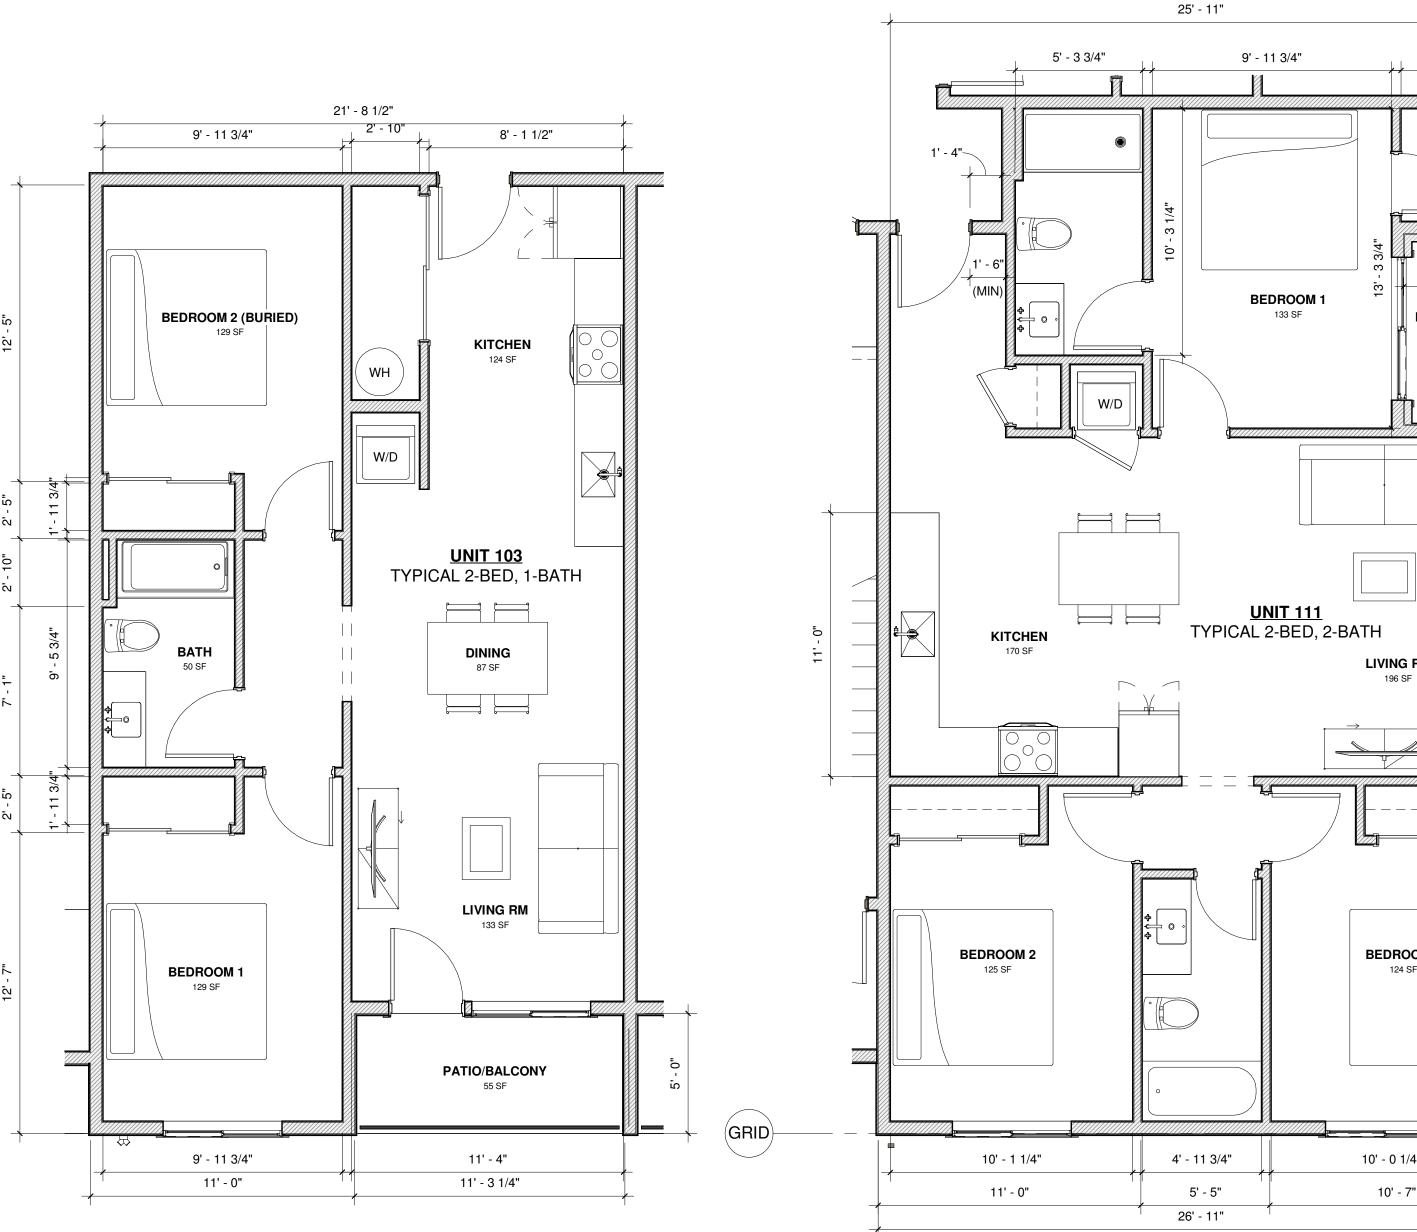









UNIT 308

UNIT 309

UNIT 310

UNIT 311

SUBTOTAL

BUILDING TOTAL

set issue date: 8/22/25

AREA

1344 SF

768 SF

1050 SF

1050 SF

900 SF

900 SF

900 SF

900 SF

900 SF

877 SF

1050 SF

1132 SF

1003 SF

877 SF

900 SF

900 SF

900 SF

900 SF

877 SF

1050 SF

1016 SF

1050 SF

1050 SF

900 SF

877 SF

900 SF

900 SF

900 SF

900 SF

877 SF

1050 SF

1132 SF

11551 SF

34859 SF

2-BED, 1-BATH

2-BED, 1-BATH

2-BED, 2 BATH

3-BED, 2 BATH

sheet name:

UNIT PLANS

MATERIAL LEGEND KEY NOTES GENERAL NOTES - ELEVATIONS A. THESE ELEVATIONS ARE PRELIMINARY AND **ARCHITECTURAL** PT-1: PAINTED TRIM, ETC. (SEE KEY INTENDED FOR SCHEMATIC DESIGN AND/OR LAND (A10) **HVAC SCREEN:** APPROX. 42" HIGH, ALUMINUM SYSTEM TO NOTES) SW 6258 TRICORN BLACK USE REVIEW PURPOSES ONLY. THEY ARE NOT (A01) MAIN LOBBY ENTRY: 3'-0" X 8'-0" GLAZED DOOR WITHIN MATCH GUARDRAIL DESIGN AND PT-1 FINISH. INTENDED FOR CONSTRUCTION OR PERMIT ALUMINUM STOREFRONT SYSTEM, BLACK FINISH DOCUMENTATION. MATCHING WINDOW SYSTEM. B. BUILDING HEIGHTS, MASSING, AND VERTICAL CP-1: HARDIE® PANEL SMOOTH A11 GUARDRAIL: 42" HIGH ALUMINUM SYSTEM WITH 1/2" X 11/2" CEMENT BOARD SIDING, PAINTED SW (A02) **DOWNSPOUTS:** PAINTED METAL, PT-1 TO MATCH WINDOW VERTICAL PICKETS @ 4" O.C., PAINTED PT-1 FINISH, 2851 SAGE GREEN LIGHT COORDINATION WITH STRUCTURAL AND CIVIL TYPICAL AT ALL EXTERIOR GUARDRAILS DISCIPLINES. (A12) ENTRY CANOPY: APPROX. 5'-0" DEEP X 23'-0" WIDE, METAL-C. WINDOW AND DOOR SIZES, TYPES, AND (A03) **SECONDARY ENTRANCE**: 6'-0" X 8'-0" GLAZED DOUBLE CP-2: HARDIE® PANEL SMOOTH FRAMED, PAINTED PT-1, WITH WD-1 CEILING FINISH AND DOORS, FINISH TO MATCH PT-1. CEMENT BOARD SIDING, PAINTED SW INTEGRATED LIGHTING. 6085 SIMPLIFY BEIGE CONFIRMED DURING CONSTRUCTION (A04) WALL OPENING: 2'-6" X 5'-0" SIZED TO ALIGN WITH TYPICAL DOCUMENTATION. (A13) DRYER EXHAUST: TYPICALLY LOCATED WITHIN BALCONIES WINDOW UNITS. EXCEPT AS SHOWN, PAINTED PT-1 TO MATCH ADJACENT **BR-1:** ARCHITECTURAL BRICK, METALWORK. (A05) HORIZONTAL TRIM BAND: NOMINAL 1X12 FIBER-CEMENT HEBRON BRICK OCEAN GRAY BLEND AND MAY CHANGE DURING FURTHER DESIGN TRIM, PAINTED TO MATCH CP-1. DEVELOPMENT. (A14) **BENCH**: EXTERIOR, PRE-MANUFACTURED UNIT, FINISH AND STYLE TO COORDINATE WITH SITE FURNISHINGS (A06) EAVE TRIM: NOMINAL 1X8 FIBER-CEMENT TRIM, PAINTED WD-1: CLEAR CEDAR T&G CLADDING, (SPECIFICATION TBD) PT-1 TO MATCH FASCIA AND WINDOW TRIM INSTALLED VERTICALLY WITH NATURAL PERMITTING PROCESS AND SHOULD NOT BE FINISH (SEALED) CONSIDERED BINDING CONDITIONS OF APPROVAL. (A07) FASCIA BOARD: NOMINAL 1X18 FIBER-CEMENT TRIM, <u>WINDOWS</u> PAINTED PT-1. FOR GENERAL CHARACTER AND MASSING CN-1: EXPOSED CONCRETE (W01) **SINGLE-HUNG WINDOWS:** 2'-6" X 5'-0" SINGLE-HUNG PURPOSES ONLY. THE FINAL ARCHITECTURAL (A08) **GUTTER:** PAINTED METAL, PT-1 FINISH, BOX (FASCIA) FOUNDATION WALL, SMOOTH FINISH, MILGARD TRINSIC V300 SERIES, BLACK FINISH. DESIGN WILL BE DEVELOPED BASED ON CODE PROFILE, INTEGRATED WITH FASCIA BOARD NATURAL COLOR COMPLIANCE, TECHNICAL COORDINATION, AND JURISDICTIONAL FEEDBACK. (W02) **SLIDER WINDOWS:** 5'-0" X 5'-0" SLIDING MILGARD TRINSIC (A09) **WINDOW TRIM:** NOMINAL 1X4 HARDIETRIM BOARDS, V300 SERIES, BLACK FINISH. PAINTED PT-1, TYPICAL AT ALL WINDOWS WITHIN CP-1 AND CP-2 WALL FINISHES. 2' - 0" TYP EAVE $\langle PT-1 \rangle$ AVERAGE HT OF THE 1/4" / 12" 1/4" / 12" HIGHEST GABLE T.O.P. (3) 29' - 4 5/8" **(A06**) (CP-1) (A05) A13 HIGHEST ADJ. SIDEWALK/GROUND W/IN 5' OF EXT. WALL A11 A11 (BR-1) (CN-1) **NE ELEVATION**3/16" = 1'-0" **A200** ---2' - 0" TYP EAVE **(** A13) (80A) AVERAGE HT OF THE HIGHEST GABLE 31' - 1" T.O.P. (3) 29' - 4 5/8" LEVEL 03 20' - 3 1/2" -(A05) T.O.P. (2) 19' - 2 7/8" LEVEL 02 10' - 1 3/4" (A05) (A12) HIGHEST ADJ. SIDEWALK/GROUND W/IN 5' OF EXT. WALL LEVEL 01-A -1' - 6" (CN-1) (A14) BR-1 A02 -(A02) **NW ELEVATION** SEE #/a## FOR GLAZING AREA CALCULATION REGARDING SMC 16.90.020.D.7.d [STREET-FACING ELEVATION]

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EXTERIOR ELEVATIONS

KEY NOTES

ARCHITECTURAL

- (A01) MAIN LOBBY ENTRY: 3'-0" X 8'-0" GLAZED DOOR WITHIN ALUMINUM STOREFRONT SYSTEM, BLACK FINISH MATCHING WINDOW SYSTEM.
- (A02) **DOWNSPOUTS:** PAINTED METAL, PT-1 TO MATCH WINDOW
- (A03) **SECONDARY ENTRANCE**: 6'-0" X 8'-0" GLAZED DOUBLE DOORS, FINISH TO MATCH PT-1.
- (A04) **WALL OPENING:** 2'-6" X 5'-0" SIZED TO ALIGN WITH TYPICAL WINDOW UNITS.
- (A05) HORIZONTAL TRIM BAND: NOMINAL 1X12 FIBER-CEMENT TRIM, PAINTED TO MATCH CP-1.
- (A06) EAVE TRIM: NOMINAL 1X8 FIBER-CEMENT TRIM, PAINTED PT-1 TO MATCH FASCIA AND WINDOW TRIM
- (A07) FASCIA BOARD: NOMINAL 1X18 FIBER-CEMENT TRIM, PAINTED PT-1. (A08) **GUTTER:** PAINTED METAL, PT-1 FINISH, BOX (FASCIA)

PROFILE, INTEGRATED WITH FASCIA BOARD

CP-2 WALL FINISHES.

(A09) **WINDOW TRIM:** NOMINAL 1X4 HARDIETRIM BOARDS, PAINTED PT-1, TYPICAL AT ALL WINDOWS WITHIN CP-1 AND

- (A10) **HVAC SCREEN:** APPROX. 42" HIGH, ALUMINUM SYSTEM TO MATCH GUARDRAIL DESIGN AND PT-1 FINISH.
- A11 GUARDRAIL: 42" HIGH ALUMINUM SYSTEM WITH 1/2" X 11/2" VERTICAL PICKETS @ 4" O.C., PAINTED PT-1 FINISH, TYPICAL AT ALL EXTERIOR GUARDRAILS
- (A12) ENTRY CANOPY: APPROX. 5'-0" DEEP X 23'-0" WIDE, METAL-FRAMED, PAINTED PT-1, WITH WD-1 CEILING FINISH AND INTEGRATED LIGHTING.
- (A13) DRYER EXHAUST: TYPICALLY LOCATED WITHIN BALCONIES EXCEPT AS SHOWN, PAINTED PT-1 TO MATCH ADJACENT METALWORK.
- (A14) **BENCH**: EXTERIOR, PRE-MANUFACTURED UNIT, FINISH AND STYLE TO COORDINATE WITH SITE FURNISHINGS (SPECIFICATION TBD)

<u>WINDOWS</u>

- (W01) **SINGLE-HUNG WINDOWS:** 2'-6" X 5'-0" SINGLE-HUNG MILGARD TRINSIC V300 SERIES, BLACK FINISH.
- (W02) **SLIDER WINDOWS:** 5'-0" X 5'-0" SLIDING MILGARD TRINSIC V300 SERIES, BLACK FINISH.

MATERIAL LEGEND



CP-1: HARDIE® PANEL SMOOTH CEMENT BOARD SIDING, PAINTED SW 2851 SAGE GREEN LIGHT

BR-1: ARCHITECTURAL BRICK,

CN-1: EXPOSED CONCRETE

HEBRON BRICK OCEAN GRAY BLEND

WD-1: CLEAR CEDAR T&G CLADDING,

FOUNDATION WALL, SMOOTH FINISH,

INSTALLED VERTICALLY WITH NATURAL

6085 SIMPLIFY BEIGE

FINISH (SEALED)

NATURAL COLOR

- DIMENSIONS ARE APPROXIMATE AND SUBJECT TO REFINEMENT DURING DESIGN DEVELOPMENT AND COORDINATION WITH STRUCTURAL AND CIVIL DISCIPLINES. CP-2: HARDIE® PANEL SMOOTH
- C. WINDOW AND DOOR SIZES, TYPES, AND CONFIGURATIONS ARE ILLUSTRATIVE. FINAL DESIGN, CEMENT BOARD SIDING, PAINTED SW DETAILING, AND PERFORMANCE CRITERIA WILL BE CONFIRMED DURING CONSTRUCTION

DOCUMENTATION.

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EXTERIOR ELEVATIONS