CLG CEILING CLR CLEAR CONC CONCRETE CONT CONTINUOUS CODE APPLICABLE REGULATIONS GOVERNING CONTRACT SCOPE OF WORK *SEE CODE SUMMARY SHEET DOUGLAS FIR / LARCH DIMENSION **DOWN SPOUT** DETAIL DISH WASHER EXIST(ING)

ELEVATION **EXPANSION JOINT** EQUAL EXP EXPOSED EXT EXTERIOR FLOOR DRAIN FDC FIRE DEPARTMENT CONNECTION FIRE EXTINGUISHER FIRE EXTINGUISHER CABINET FINISHED FLOOR FF EL

FLR

GALV

GB

GFCI

MFR

MTL

NTS

OC OD

OFD

OF/CI

OPH

FINISHED FLOOR ELEVATION **FLOOR** FACE OF GAUGE GALVANIZED GYPSUM BOARD GROUND FAULT CIRCUIT INTERRUPTER HOSE BIB

HOUR INSIDE DIAMETER IMPACT INSULATION CLASS INTERIOR MAXIMUM MANUFACTURER MINIMUM MATERIAL MICROWAVE NOT IN CONTRACT NOT TO SCALE OR APPROVED EQUAL ON CENTER OUTSIDE DIAMETER OVERFLOW DRAIN OWNER FURNISHED, CONTRACTOR

INSTALLED OWNER FURNISHED, OWNER INSTALLED OPPOSITE HAND OPPOSITE PREFINISHED PRESSURE TREATED **ROOF DRAIN** REFRIGERATOR **ROUGH OPENING** RIGHT OF WAY SANITARY SMOKE DETECTOR SQUARE FOOT (FEET) SIMILAR

STAINLESS STEEL STN STAIN SOUND TRANSMISSION CLASS STR STRUCTURAL DRAWINGS TEMPERED TOP OF TYPICAL UNLESS OTHERWISE NOTED VERIFY IN FIELD WATER HEATER

PROJECT SUMMARY

NEW WAREHOUSE AND TWO STORY OFFICE BUILDINHG WITH ASSOCIATED SITEWORK. THE BUILDING WILL BE A PRE-FABRICATED STEEL STRUCTURE.

PROJECT DIRECTORY

OWNER BRIAN BUTTERFIELD GREEN RIDGE SOLAR 19450 SW MOHAVE CT,

TUALATIN, OR 97062

+503-395-1943

PRINCIPAL ARCHITECT MELYNDA RETALLACK INK:BUILT ARCHITECTURE, LLC. 2808 NE MLK BLVD, SUITE G PORTLAND, OR 97212

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GENERAL CONTRACTOR TBD

CIVIL ENGINEER JASON HAVELKA SUMMIT ENGINEERING LLC 2850 SW CEDAR HILLS BLVD, BEAVERTON, OR 97005

DRAWING INDEX

SHEET # SHEET NAME

LU0.00 SITE PLAN REVIEW COVER SHEET OWNER'S EXISTING CONDITIONS PLAN

CIVIL SITE PLAN GRADING PLAN

LU0.50 SITE PLAN & CODE SUMMARY LU0.51 LANDSCAPE PLAN LU0.52 LANDSCAPE DETAILS LU1.01 FLOOR PLANS

UTILITY PLAN

LU1.10 ROOF PLAN LU2.00 EXTERIOR ELEVATIONS LU2.01 EXTERIOR ELEVATIONS LU4.00 SECTIONS

VICINITY MAP




LOCATION MAP



PROJECT GENERAL NOTES

- DRAWINGS ARE DIAGRAMMATIC AND DO NOT NECESSARILY DEPICT ALL MATERIALS IN ALL INSTANCES.
- DO NOT SCALE DRAWINGS; WRITTEN DIMENSIONS SHALL HAVE PRECEDENCE OVER SCALED DIMENSIONS. DRAWINGS REPRESENT THE FINISHED STRUCTURE, THEY DO NOT INDICATE METHOD OF CONSTRUCTION. CONTRACTOR SHALL ASSUME RESPONSIBILITY FOR DETERMINING APPROPRIATE METHOD AND SEQUENCE OF CONSTRUCTION.
- CONTRACTOR SHALL ASSURE THE SAFETY OF WORKERS AND SITE THROUGHOUT THE DURATION OF CONSTRUCTION VERIFY ALL EXISTING CONDITIONS PRIOR TO CONSTRUCTION AND PURCHASE OF MATERIALS. ANY DISCREPANCIES BETWEEN
- FIELD MEASUREMENTS AND DRAWINGS SHALL BE IMMEDIATELY BROUGHT TO THE ATTENTION OF THE ARCHITECT. 6. ALL WORK SHALL CONFORM TO THE MINIMUM STANDARDS SET BY THE LATEST EDITION OF THE OREGON STRUCTURAL SPECIALTY CODE AND ALL OTHER APPLICABLE CODES.
- 7. DETAILS NOTED AS "TYPICAL" OR "TYP" APPLY IN ALL CASES UNLESS SPECIFICALLY REFERENCED. DETAILS THAT ARE SPECIFICALLY REFERENCED SHALL TAKE PRECEDENCE OVER GENERAL NOTES, "TYPICAL" NOTES, GENERAL DETAILS, OR DETAILS NOTED AS "TYPICAL" OR "TYP".
- LOCATE EXISTING UTILITIES WHETHER INDICATED OR NOT AND PROTECT FROM DAMAGE. CONTRACTOR SHALL BEAR REPAIR OR REPLACEMENT EXPENSES OF UTILITIES OR OTHER PROPERTY DAMAGED BY OPERATIONS IN CONJUNCTION WITH THE
- 9. PROVIDE ACCESS PANELS AS REQUIRED. LOCATION, FINISH, AND TYPE SHALL BE APPROVED BY ARCHITECT PRIOR TO OBTAINING AND INSTALLING. PROVIDE ACCESS PANELS WITH THE SAME RATING AS THE ASSEMBLY IN WHICH THEY ARE INSTALLED. ACCESS PANELS IN SHAFT WALLS, RATED FLOOR/CEILINGS OR RATED ROOF/CEILINGS SHALL BE SMOKE SEALED. 10. ALL RATED ASSEMBLIES SHALL BE CONSTRUCTED TO PREVENT THE MOEVEMENT OF HOT FLAME OR GASES PER OSSC
- SECTION 709.6. ALL PENETRATIONS THROUGH RATED ASSEMBLIES SHALL BE FIRESTOPPED. 11. ALL SAFETY GLAZING SHALL BE PERMANENTLY LABELED WITH THE MANUFACTURER'S NAME AND TEST APPROVAL
- INFORMATION. 12. PROVIDE ALL CODE REQUIRED SIGNAGE.



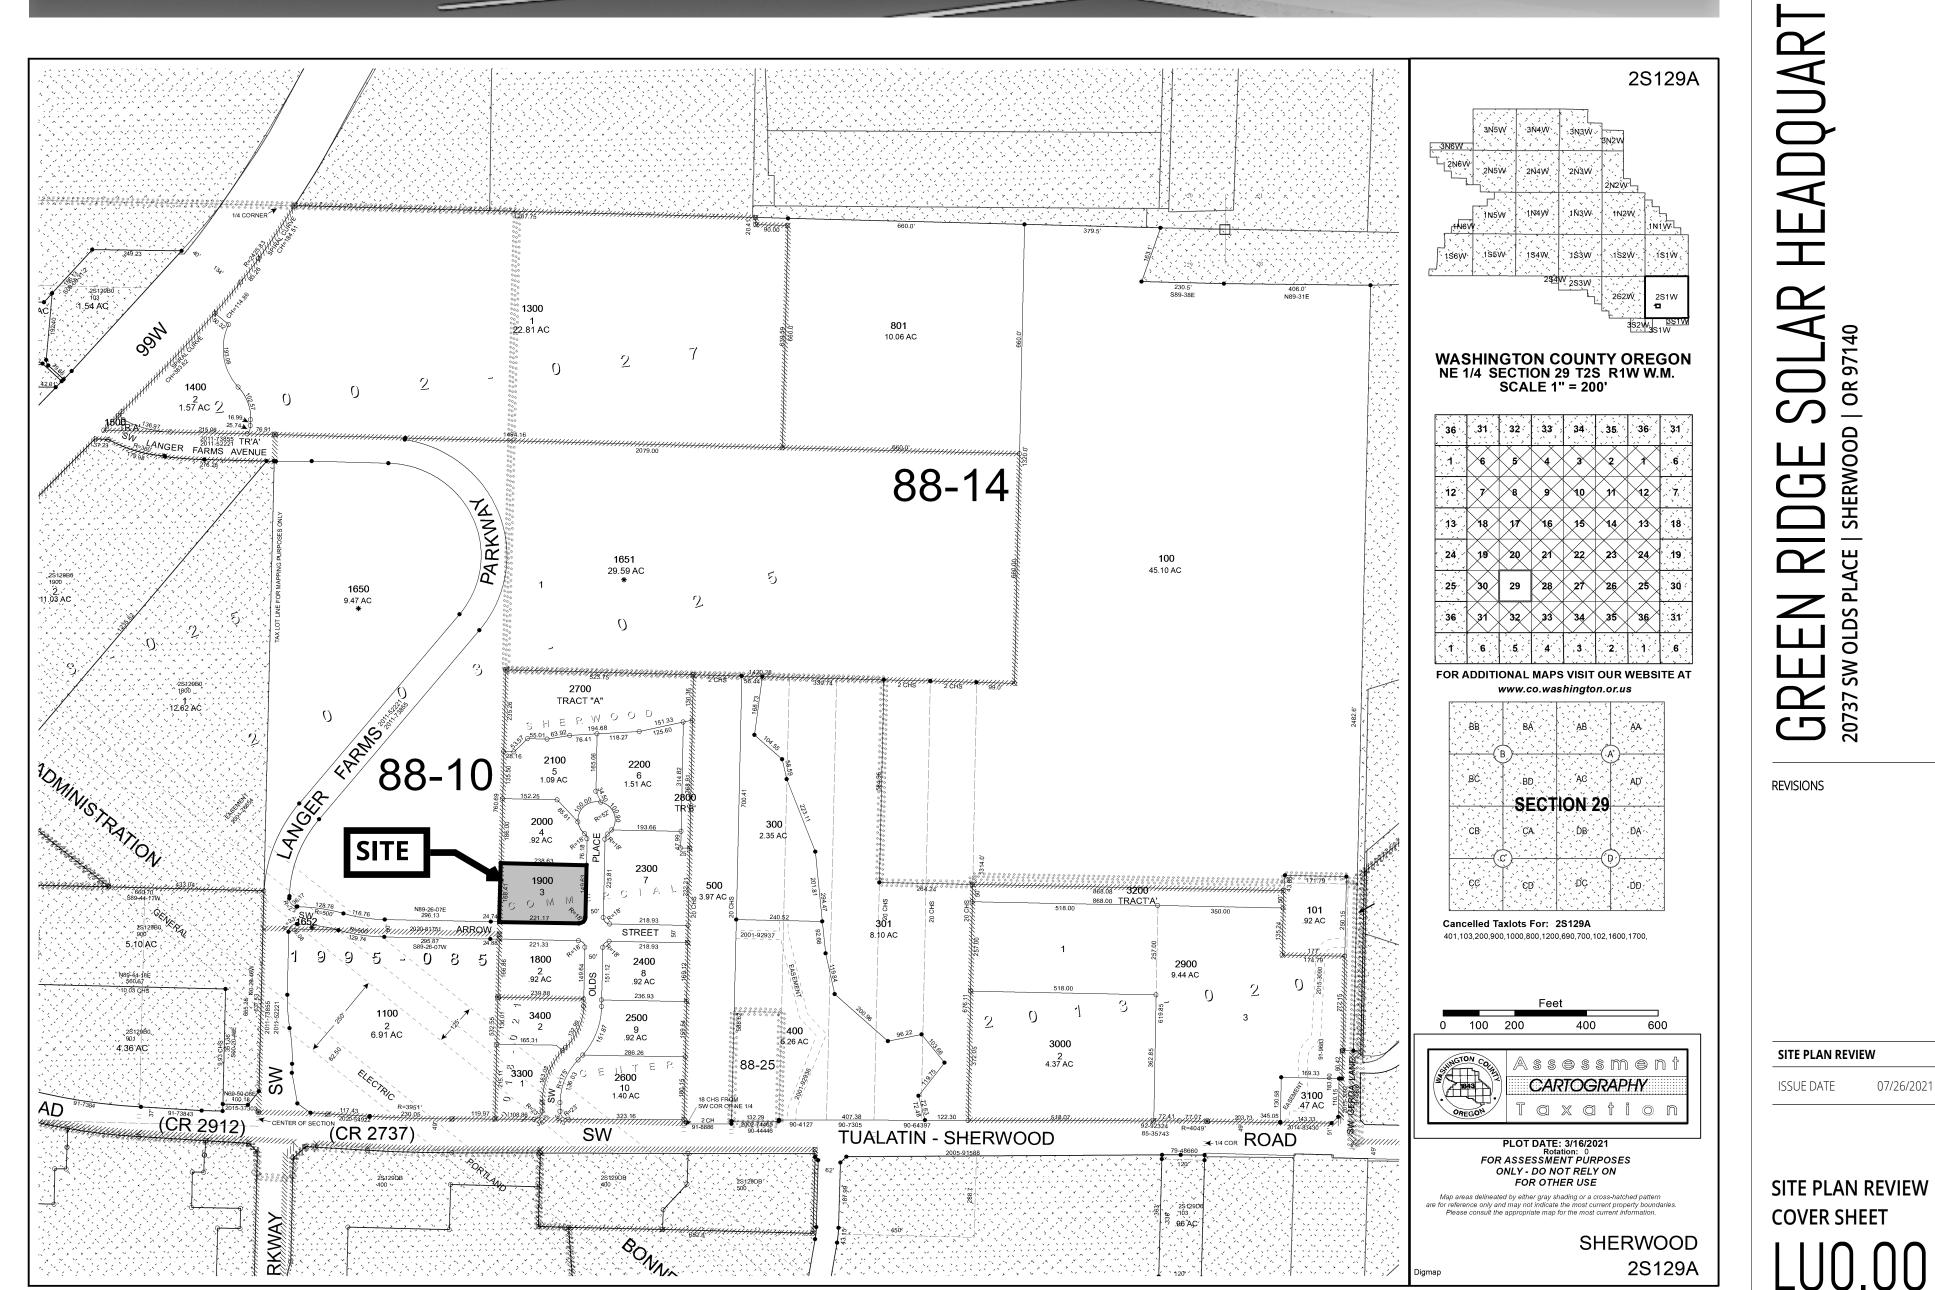

ARCHITECTURE, LLC

2808 NE MLK, STE G PORTLAND, OR 97212 503.454.6793 inkbuiltdesign.com


> PRELIMINARY NOT FOR

> CONSTRUCTION

ADQUARTERS ₩ 8 I SHERW REVISIONS

SITE PLAN REVIEW

SITE PLAN REVIEW **COVER SHEET**

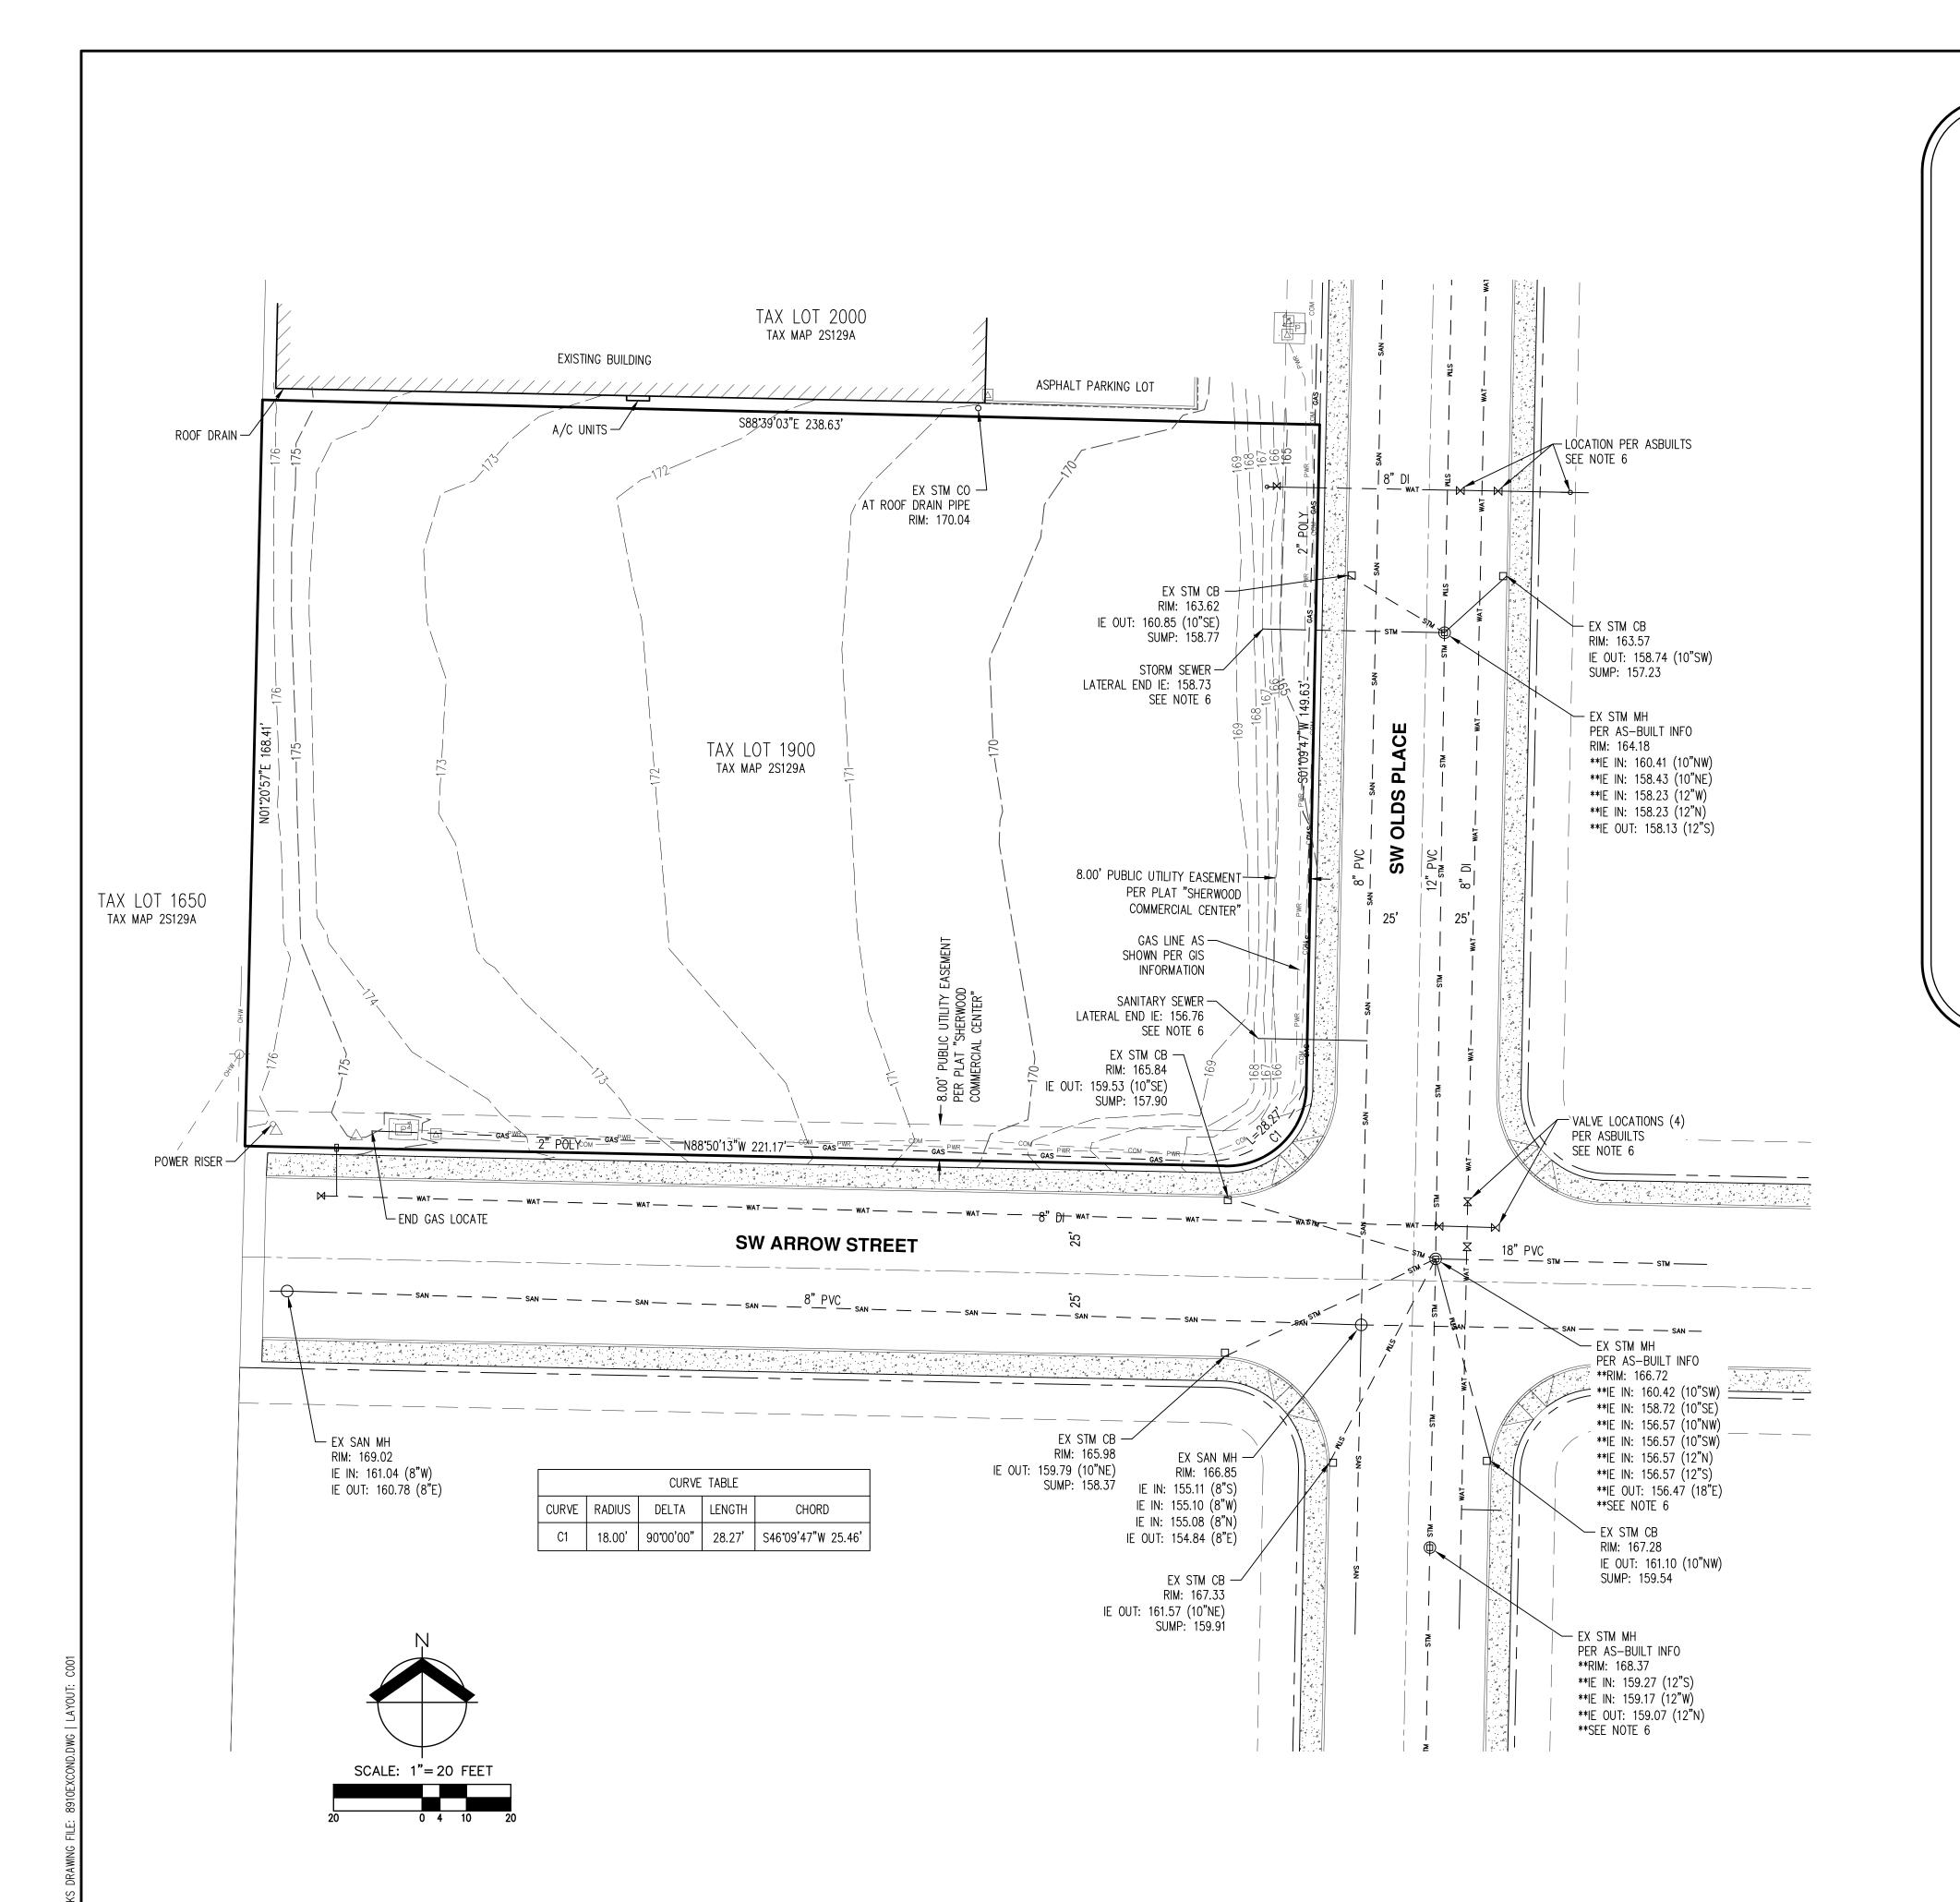

LEGEND

<u>EX</u>	<u>ISTING</u>		EXISTING
DECIDUOUS TREE	\bigcirc	STORM DRAIN CLEAN OUT	0
	M	STORM DRAIN CATCH BASIN	
CONIFEROUS TREE	7	STORM DRAIN AREA DRAIN	
FIRE HYDRANT	Д	STORM DRAIN MANHOLE	
WATER BLOWOFF	Ŷ	GAS METER	0
WATER METER		GAS VALVE	Ø
WATER VALVE	×	GUY WIRE ANCHOR	\leftarrow
DOUBLE CHECK VALVE	\bowtie	UTILITY POLE	-0-
AIR RELEASE VALVE	ූ ර	POWER VAULT	Р
SANITARY SEWER CLEAN OUT	0	POWER JUNCTION BOX	
SANITARY SEWER MANHOLE	0	POWER PEDESTAL	
SIGN		COMMUNICATIONS VAULT	С
STREET LIGHT	\$	COMMUNICATIONS JUNCTION BOX	\triangle
MAII BOX	[MB]	COMMUNICATIONS RISER	\bigcirc

	<u>EXISTING</u>	
RIGHT-OF-WAY LINE		
BOUNDARY LINE		
PROPERTY LINE		
CENTERLINE		
DITCH		> -
CURB		
EDGE OF PAVEMENT		
EASEMENT		
FENCE LINE		
GRAVEL EDGE		
POWER LINE	— — PWR — — —	—— PWR —
OVERHEAD WIRE	— — OHW — — —	—— ОНW —
COMMUNICATIONS LINE	com	— сом —
FIBER OPTIC LINE	— — — CFO — — —	— сго —
GAS LINE	— — — GAS — — —	—— GAS —
STORM DRAIN LINE	stm	— sтм —
SANITARY SEWER LINE	— — — SAN — — —	SAN
WATER LINE	wat	— wat —
_		

- 1. UTILITIES SHOWN ARE BASED ON FIELD TIES, RECORD AS-BUILT INFORMATION AND UNDERGROUND UTILITY LOCATE MARKINGS AS PROVIDED PER UTILITY LOCATE TICKET NUMBER 21170467. THE SURVEYOR MAKES NO GUARANTEE THAT THE UNDERGROUND LOCATES REPRESENT THE ONLY UTILITIES IN THE AREA. CONTRACTORS ARE RESPONSIBLE FOR VERIFYING ALL EXISTING CONDITIONS PRIOR TO BEGINNING CONSTRUCTION.
- 2. FIELD WORK WAS CONDUCTED JUNE 7, 2021. EXTENTS OF TOPOGRAPHIC SURVEY INCLUDES ON-SITE FEATURES TO BACK OF SIDEWALK, PLUS UTILITY STRUCTURES UNLESS OTHERWISE NOTED. ALL OTHER LINEWORK, INCLUDING SIDEWALK, CURB, AND RAMPS, ARE PER RECORDS DRAWINGS.
- 3. VERTICAL DATUM: ELEVATIONS ARE BASED ON WASHINGTON COUNTY BENCHMARK 103, A 2" DIAMETER BRASS CAP IN A INTERSECTION OF SW TUALATIN-SHERWOOD ROAD AND THE SOUTHERN PACIFIC RAILROAD CROSSING. THE ELEVATION OF THE BENCHMARK IS 171.38 FEET (NGVD 29).
- 4. THIS IS NOT A PROPERTY BOUNDARY SURVEY. BOUNDARIES AS SHOWN ARE PER RECORDED PLAT OF SHERWOOD COMMERCIAL CENTER AND FOUND MONUMENTS. A TITLE REPORT WAS NOT RECEIVED FOR THIS SURVEY, ONLY EASEMENTS FROM RECORDED PLAT ARE SHOWN. PROPERTY MAY BE SUBJECT TO ADDITIONAL EASEMENTS.
- 5. CONTOUR INTERVAL IS 1 FOOT.
- 6. ASBUILT INFORMATION PER SHERWOOD COMMERCIAL CENTER ASBUILT PLANS BY AKS ENGINEERING AND FORESTRY, DATED 07,

FXISTING

	<u>LXI31II10</u>
GHT-OF-WAY LINE	
OUNDARY LINE	
ROPERTY LINE	
ENTERLINE	
TCH	·-
URB	
OGE OF PAVEMENT	
ASEMENT	
ENCE LINE	
RAVEL EDGE	
OWER LINE	— — PWR — — PWR —
VERHEAD WIRE	— — онw — — онw —
OMMUNICATIONS LINE	com com
BER OPTIC LINE	— — CFO — — CFO —
AS LINE	GAS GAS
TORM DRAIN LINE	stm stm _
ANITARY SEWER LINE	SAN SAN
ATER LINE	WAT WAT

MONUMENT BOX, LOCATED NEAR THE SOUTHEAST CORNER OF THE

DESIGNED BY: CHECKED BY:

OREGON

900 7 DS

70

SW

DATE: 06/18/2021


REGISTERED PROFESSIONAL LAND SURVEYOR

OREGON
MARCH 14, 2017
BENJAMIN R HUFF 84738PLS RENEWS: 6/30/23

JOB NUMBER

SHEET

C001

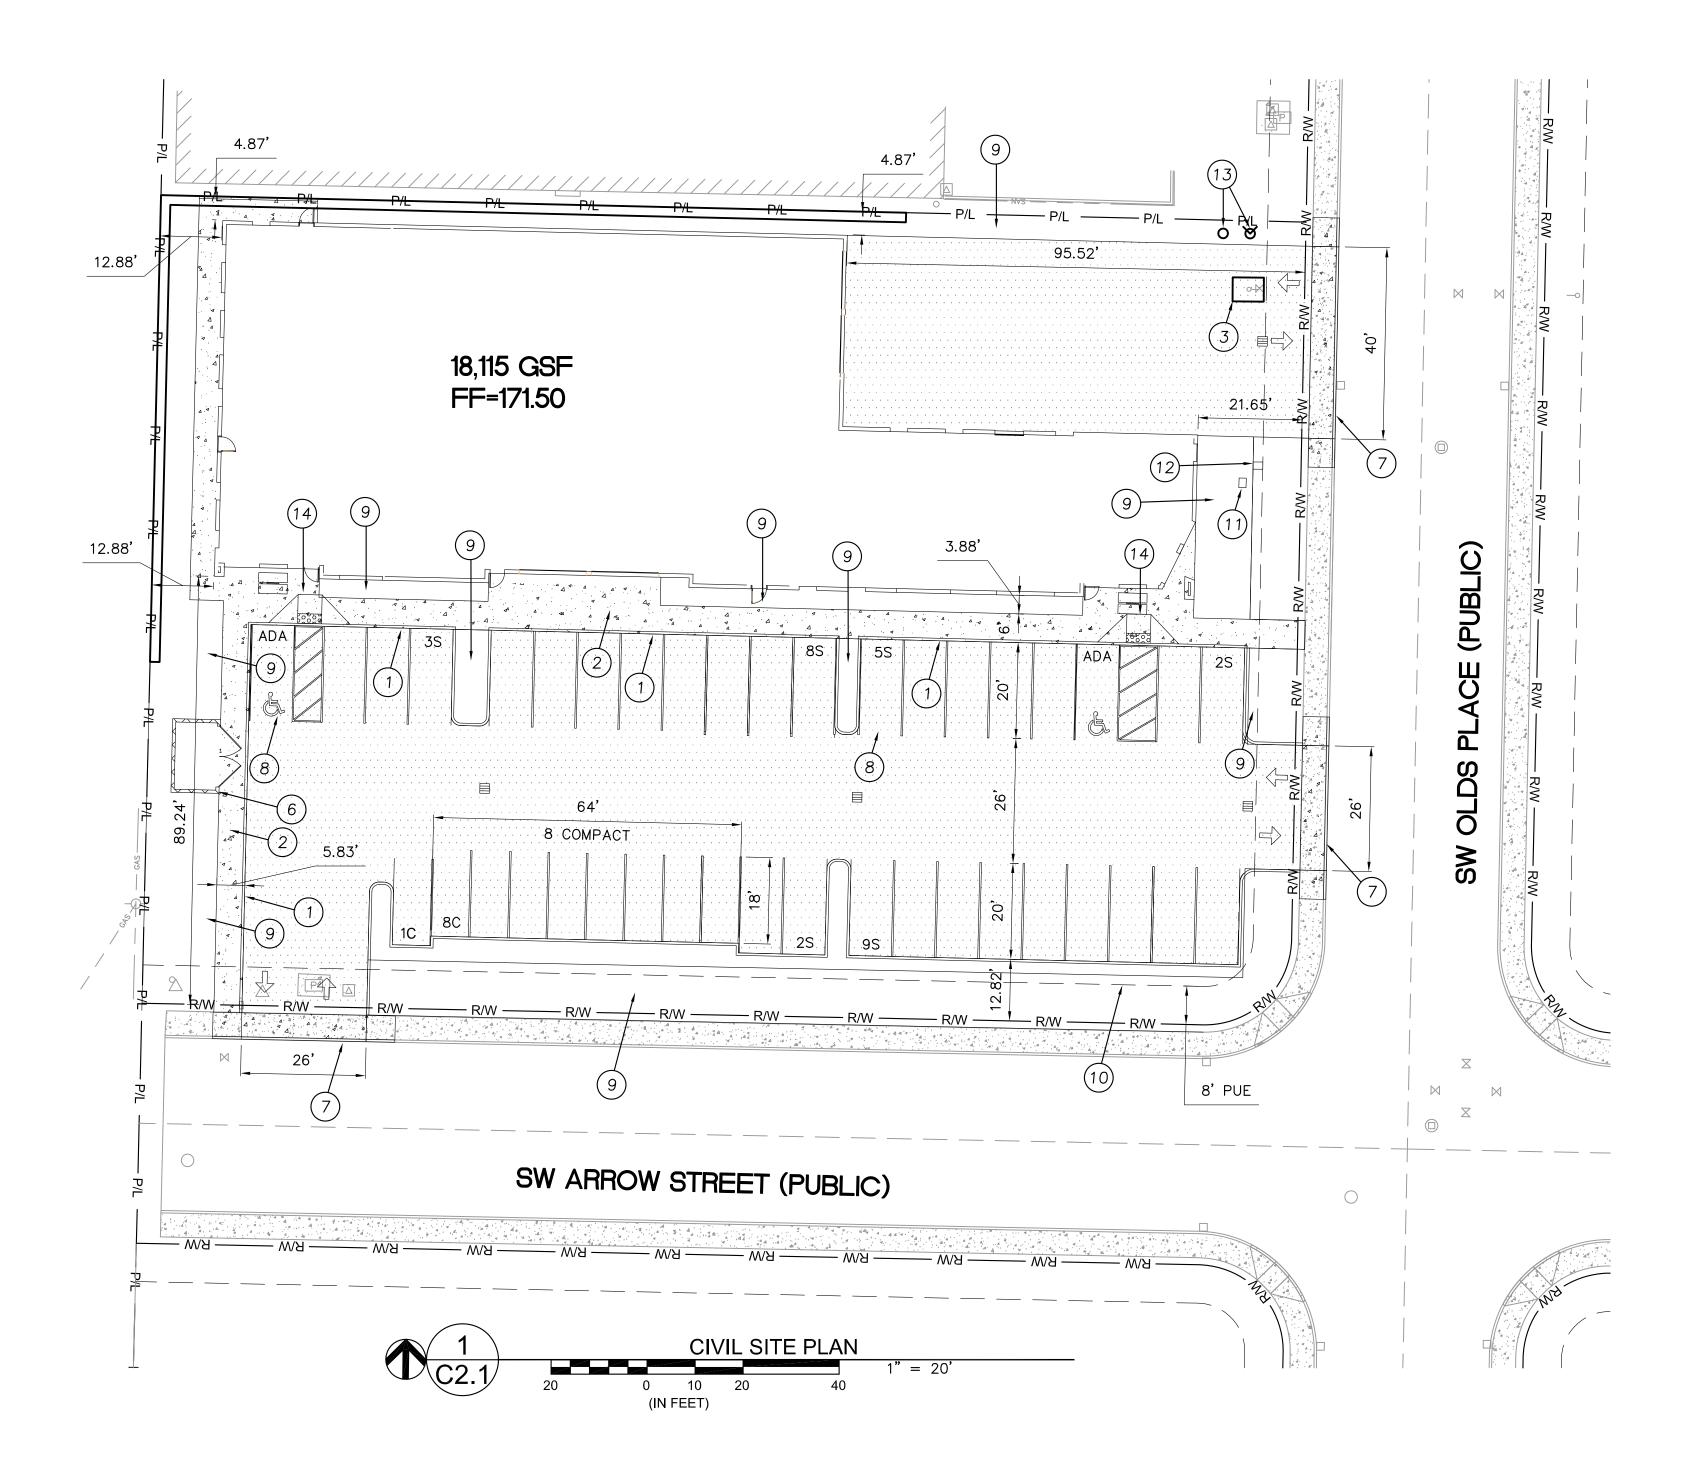

LEGEND

PROPOSED: ASPHALT PAVING DRIVEWAY, CONCRETE PADS AND SIDEWALK CATCH BASIN WATER METER WATER VAULT FDC 6" VERTICAL CURB RETAINING WALL, SEE C2.2 EXISTING: EXISTING EDGE OF PAVEMENT STORM SEWER MANHOLE STORM SEWER LINE CATCH BASIN WATER METER WATER LINE WATER VALVE SANITARY SEWER MANHOLE SANITARY SEWER LINE --- --- SAN ---POWER VAULT POWER JUNCTION BOX COMMUNICATIONS JUNCTION BOX GAS LINE UNDERGROUND COMMUNICATIONS LINE

RIGHT OF WAY

PROPERTY LINE

SITE DATA

SHEDATA		
SITE AREA	40,070 SF	
LANDSCAPE AREA	6,844 SF (17.1%)	
ASPHALT PARKING	13,765 SF	
ASPHALT AT TRUCK COURT	3,813 SF	
BUILDING FOOT PRINT	11,971 SF	
VEHICLE PARKING SPACES		
STANDARD	29 SPACES	
ADA	2 SPACES	
COMPACT	9 SPACES	
TOTAL PROVIDED	40 SPACES	
TOTAL REQUIRED	40 SPACES	
BICYCLE SPACES PROVIDED	4 SPACES	
BICYCLE SPACES REQUIRED	3 SPACES	

GENERAL NOTES

- 1. ALL WORK SHALL CONFORM TO THE REQUIREMENTS OF THE CITY OF SHERWOOD, THE CURRENT EDITION OF THE OREGON SPECIALTY PLUMBING CODE, AND THE INTERNATIONAL BUILDING CODE. ALL WORK IN THE PUBLIC R.O.W. REQUIRES A PUBLIC WORKS PERMIT.
- 2. EXCAVATION: EXCAVATE FOR SLABS, PAVING AND OTHER IMPROVEMENTS TO SIZES AND LEVELS SHOWN OR REQUIRED. ALLOW FOR FORM CLEARANCE AND FOR PROPER COMPACTION OF REQUIRED BACKFILLING MATERIAL. EXCAVATORS MUST COMPLY WITH ORS 757.541 THROUGH 757.571; EXCAVATORS SHALL NOTIFY ALL UTILITY COMPANIES FOR LINE LOCATIONS 72 HOURS (MINIMUM) PRIOR TO START OF WORK. DAMAGE TO UTILITIES SHALL BE CORRECTED AT THE CONTRACTOR'S EXPENSE.
- 3. EFFECTIVE EROSION CONTROL IS REQUIRED. EROSION CONTROL DEVICES MUST BE INSTALLED AND MAINTAINED MEETING WES STANDARDS. THE GOVERNING JURISDICTION SHALL, AT ANY TIME, ORDER CORRECTIVE ACTION AND STOPPAGE OF WORK TO ACCOMPLISH EFFECTIVE EROSION CONTROL.
- 4. EFFECTIVE DRAINAGE CONTROL IS REQUIRED. DRAINAGE SHALL BE CONTROLLED WITHIN THE WORK SITE AND SHALL BE SO ROUTED THAT ADJACENT PRIVATE PROPERTY, PUBLIC PROPERTY, AND THE RECEIVING SYSTEM ARE NOT ADVERSELY IMPACTED. THE GOVERNING JURISDICTION MAY, AT ANY TIME, ORDER CORRECTIVE ACTION AND STOPPAGE OF WORK TO ACCOMPLISH EFFECTIVE DRAINAGE CONTROL. REFER TO WES STANDARDS AND EROSION CONTROL PLAN.
- 5. CONTRACTOR SHALL ADJUST ALL STRUCTURES IMPACTED BY CONSTRUCTION IMPROVEMENTS TO NEW FINISHED GRADES, AND COORDINATE CONSTRUCTION AROUND EXISTING UTILITIES WITH UTILITY
- 6. CONTRACTOR SHALL PROTECT ALL EXISTING STRUCTURES NOT SHOWN FOR REMOVAL. DAMAGE TO EXISTING STRUCTURES SHALL BE REPAIRED BY THE CONTRACTOR WITH CONTRACTOR'S OWN RESOURCES.
- 7. THE BUILDING OUTLINE SHOWN ON THIS PLAN IS SHOWN FOR REFERENCE ONLY AND SHOULD NOT BE USED FOR CONSTRUCTION, WHETHER MEASURING, STAKING OR OTHERWISE. REFER TO ARCHITECTURAL DRAWINGS FOR ALL MEASUREMENTS, DIMENSIONS, OUTLINE AND FEATURES.
- 8. PAVING, FOUNDATIONS, SITE PREPARATION, CLEARING, GRADING, GRUBBING, SUBGRADE PREPARATION, ETC. BY OTHERS.
- 6. THE SURVEY INFORMATION SHOWN AS A BACKGROUND SCREEN ON THIS SHEET IS BASED ON A SURVEY DONE BY AKS ENGINEERING AND FORESTRY DATED 06/18/2021, AND IS SHOWN FOR REFERENCE ONLY. SUMMIT ENGINEERING HAS NOT VERIFIED ANY INFORMATION SHOWN ON THE PLANS AND MAKES NO GUARANTEES AS TO THE ACCURACY OF THE INFORMATION SHOWN. CONTRACTOR TO VERIFY ALL EXISTING CONDITIONS WITH THEIR OWN RESOURCES PRIOR TO THE START OF ANY CONSTRUCTION OR ORDERING MATERIALS. NOTIFY ENGINEER OF ANY DISCREPANCIES WITH THE SITE WITH RESPECT TO ANY ELEMENT SHOWN ON THESE PLANS.

CONSTRUCTION NOTES

- 1. 6" VERTICAL CURB. 2. CONCRETE SIDEWALK.
- 3. BACKFLOW PREVENTION IN VAULT PER UTILITY PLAN.
- 4. FIRE TRUCK/ENGINE TURN RADII.
- 5. BIKE PARKING PER ARCH. 6. TRASH ENCLOSURE PER ARCH.
- 7. REMOVE EXISTING CURB AND SIDEWALK. INSTALL CITY STANDARD CONCRETE DRIVEWAY PER RD-42.
- 8. ADA PARKING SPACE.
- 9. LANDSCAPE AREA, SEE LANDSCAPING PLANS.
- 10. EXISTING PUBLIC UTILITY EASEMENT.
- 11. IRRIGATION POINT OF CONNECTION, SEE UTILITY PLAN. 12. WATER METER, SEE UTILITY PLAN.
- 13. FDC AND PIV, SEE UTILITY PLAN.
- 14. ADA CURB RAMP.



Inkbuilt Architecture

Project

Green Ridge Solar 20737 SW Olds Place Sherwood, OR

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REVISION SCHEDULE: REVISION DELTA ISSUE DATE

SHEET TITLE:

CIVIL SITE PLAN


DRAWN BY: **JMH** APPROVED BY: JMH

SHEET:

C2.1

JOB NO.:

20-026

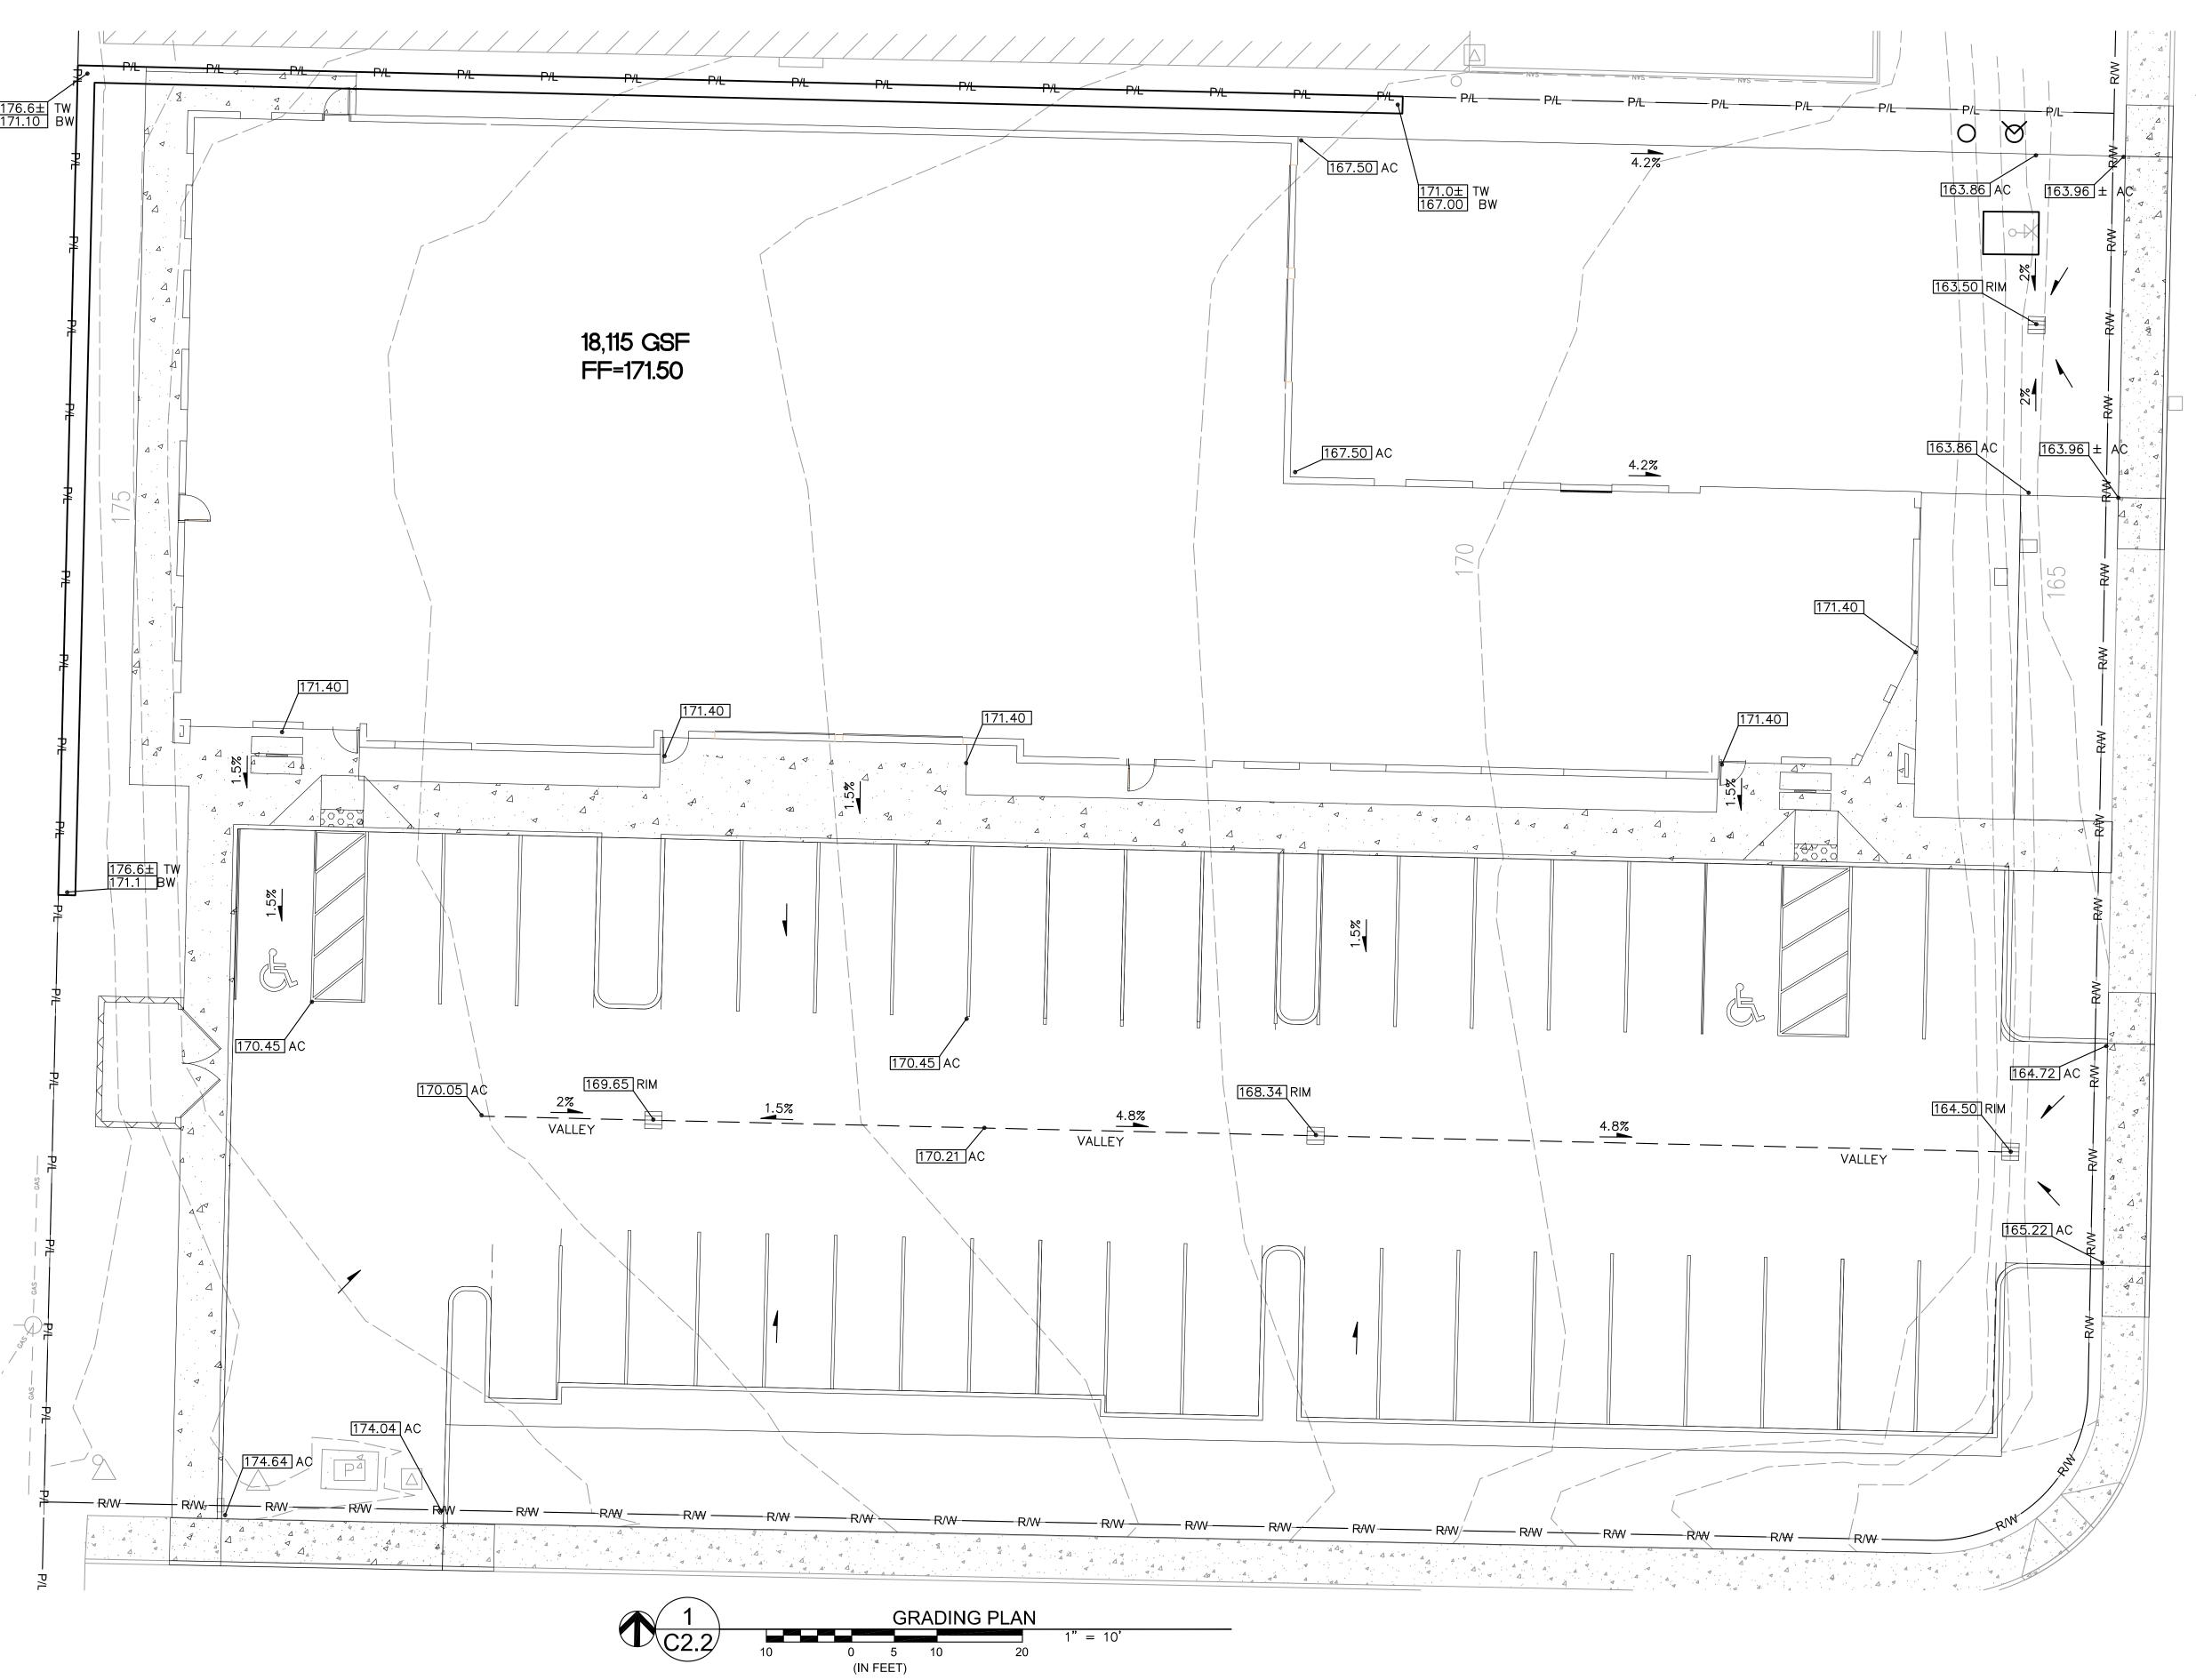

GRADING NOTES

- ROUGH GRADING: BRING ALL FINISHED GRADES TO APPROXIMATE LEVELS INDICATED. WHERE GRADES ARE NOT OTHERWISE INDICATED, FINISHED GRADES ARE TO BE THE SAME AS ADJACENT SIDEWALKS, CURBS, OR THE OBVIOUS GRADE OF ADJACENT STRUCTURE. GRADE TO UNIFORM LEVELS OR SLOPES BETWEEN POINTS WHERE GRADES ARE GIVEN; OTHERWISE, GRADING SHALL ADHERE TO THE CONTOUR OR SPOT GRADE SHOWN, OR AN INTERPOLATION BETWEEN A GIVEN SPOT GRADE OR CONTOUR. ROUND OFF SURFACES, AVOID ABRUPT CHANGES IN LEVELS. ROUGH GRADE TO ALLOW FOR DEPTH OF CONCRETE SLABS, WALKS AND THEIR BASE COURSES. GRADE FOR PAVED DRIVES AND PAVED PARKING AREAS AS INDICATED AND SPECIFIED HEREIN. AND PROVIDE FOR SURFACE DRAINAGE AS SHOWN, ALLOWING FOR THICKNESS OF SURFACING MATERIAL
- 2. EXCAVATION: EXCAVATE FOR SLABS, PAVING AND OTHER IMPROVEMENTS TO SIZES AND LEVELS SHOWN OR REQUIRED. ALLOW FOR FORM CLEARANCE AND FOR PROPER COMPACTION OF REQUIRED BACKFILLING MATERIAL. EXCAVATORS MUST COMPLY WITH ORS 757.541 THROUGH 757.571; EXCAVATORS SHALL NOTIFY ALL UTILITY COMPANIES FOR LINE LOCATIONS 72 HOURS (MINIMUM) PRIOR TO START OF WORK. DAMAGE TO UTILITIES SHALL BE CORRECTED AT THE CONTRACTOR'S EXPENSE.
- 3. EFFECTIVE EROSION CONTROL IS REQUIRED. EROSION CONTROL DEVICES MUST BE INSTALLED AND MAINTAINED MEETING WES STANDARDS. THE GOVERNING JURISDICTION SHALL, AT ANY TIME, ORDER CORRECTIVE ACTION AND STOPPAGE OF WORK TO ACCOMPLISH EFFECTIVE EROSION CONTROL.
- 4. EFFECTIVE DRAINAGE CONTROL IS REQUIRED. DRAINAGE SHALL BE CONTROLLED WITHIN THE WORK SITE AND SHALL BE SO ROUTED THAT ADJACENT PRIVATE PROPERTY, PUBLIC PROPERTY, AND THE RECEIVING SYSTEM ARE NOT ADVERSELY IMPACTED. THE GOVERNING JURISDICTION MY, AT ANY TIME, ORDER CORRECTIVE ACTION AND STOPPAGE OF WORK TO ACCOMPLISH EFFECTIVE DRAINAGE CONTROL. REFER TO WES STANDARDS AND EROSION CONTROL PLAN.
 5. SITE TOPSOIL SHALL BE STOCKPILED DURING
- CONSTRUCTION AND USED FOR LANDSCAPING TO THE EXTENT PRACTICABLE.

 6. THE SURVEY INFORMATION SHOWN AS A BACKGROUND SCREEN ON THIS SHEET IS BASED ON A SURVEY DONE BY AKS ENGINEERING AND FORESTRY DATED 06/18/2021, AND IS SHOWN FOR REFERENCE ONLY. SUMMIT ENGINEERING HAS NOT VERIFIED ANY INFORMATION SHOWN ON THE PLANS AND MAKES NO GUARANTEES AS TO THE ACCURACY OF THE INFORMATION SHOWN. CONTRACTOR TO VERIFY ALL EXISTING CONDITIONS WITH THEIR OWN RESOURCES PRIOR TO THE START OF ANY CONSTRUCTION OR ORDERING MATERIALS. NOTIFY ENGINEER OF ANY
- ELEMENT SHOWN ON THESE PLANS.

 7. CONTRACTOR SHALL COORDINATE GRADES AT ALL BUILDING ENTRANCES WITH ARCHITECTURAL PLANS PRIOR TO CONSTRUCTION.

DISCREPANCIES WITH THE SITE WITH RESPECT TO ANY

- 8. CONTRACTOR TO ENSURE 1.5% MAX SLOPE AT ALL ADA—ACCESSIBLE PARKING SPACES.
- 9. CONTRACTOR TO ENSURE 5% MAX SLOPE (EXCLUDING RAMPS) AND 1.5% MAX CROSS—SLOPE AT PEDESTRIAN SIDEWALK CONNECTIONS BETWEEN PUBLIC R.O.W. AND BUILDING ENTRANCES.
- 10. CONTRACTOR TO ENSURE ALL STRUCTURES IMPACTED BY CONSTRUCTION IMPROVEMENTS ARE ADJUSTED TO NEW FINISHED GRADES.
- 11. CONTRACTOR TO ENSURE THE FIRST FIVE (5) FEET OF FINISHED GROUND SHALL SLOPE AWAY FROM EACH FACE OF EACH BUILDING AT A MINIMUM OF 2%. NOTIFY ENGINEER OF ANY DISCREPANCIES SHOWN ON PLAN DURING CONSTRUCTION.
- 12. REFER TO GENERAL NOTES ON C2.1.

LEGEND

232.81 TC	TOP OF CURB
232.81 AC	ASPHALT ELEVATION
232.81 TW	TOP OF WALL ELEVATION
232.81 BW	BOTTOM GRADE AT FACE OF RETAINING WALL (NOT BOTTOM OF WALL OR WALL FOOTING)
232.81 RIM	CATCH BASIN RIM ELEVATION
[232.81] FG	EXISTING GRADE

[232.81] EG	EXIZIIN
229	PROPOS
230	PROPOS
— — 229 — —	EXISTIN
230	EXISTIN
	RIDGE (

PROPOSED 1—FT CONTOUR
PROPOSED 5—FT CONTOUR
EXISTING 1—FT CONTOUR
EXISTING 5—FT CONTOUR
RIDGE OR VALLEY LINE

RETAINING WALL

SHEET TITLE:

GRADING

PLAN

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REVISION SCHEDULE:
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Inkbuilt Architecture

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Sherwood, OR

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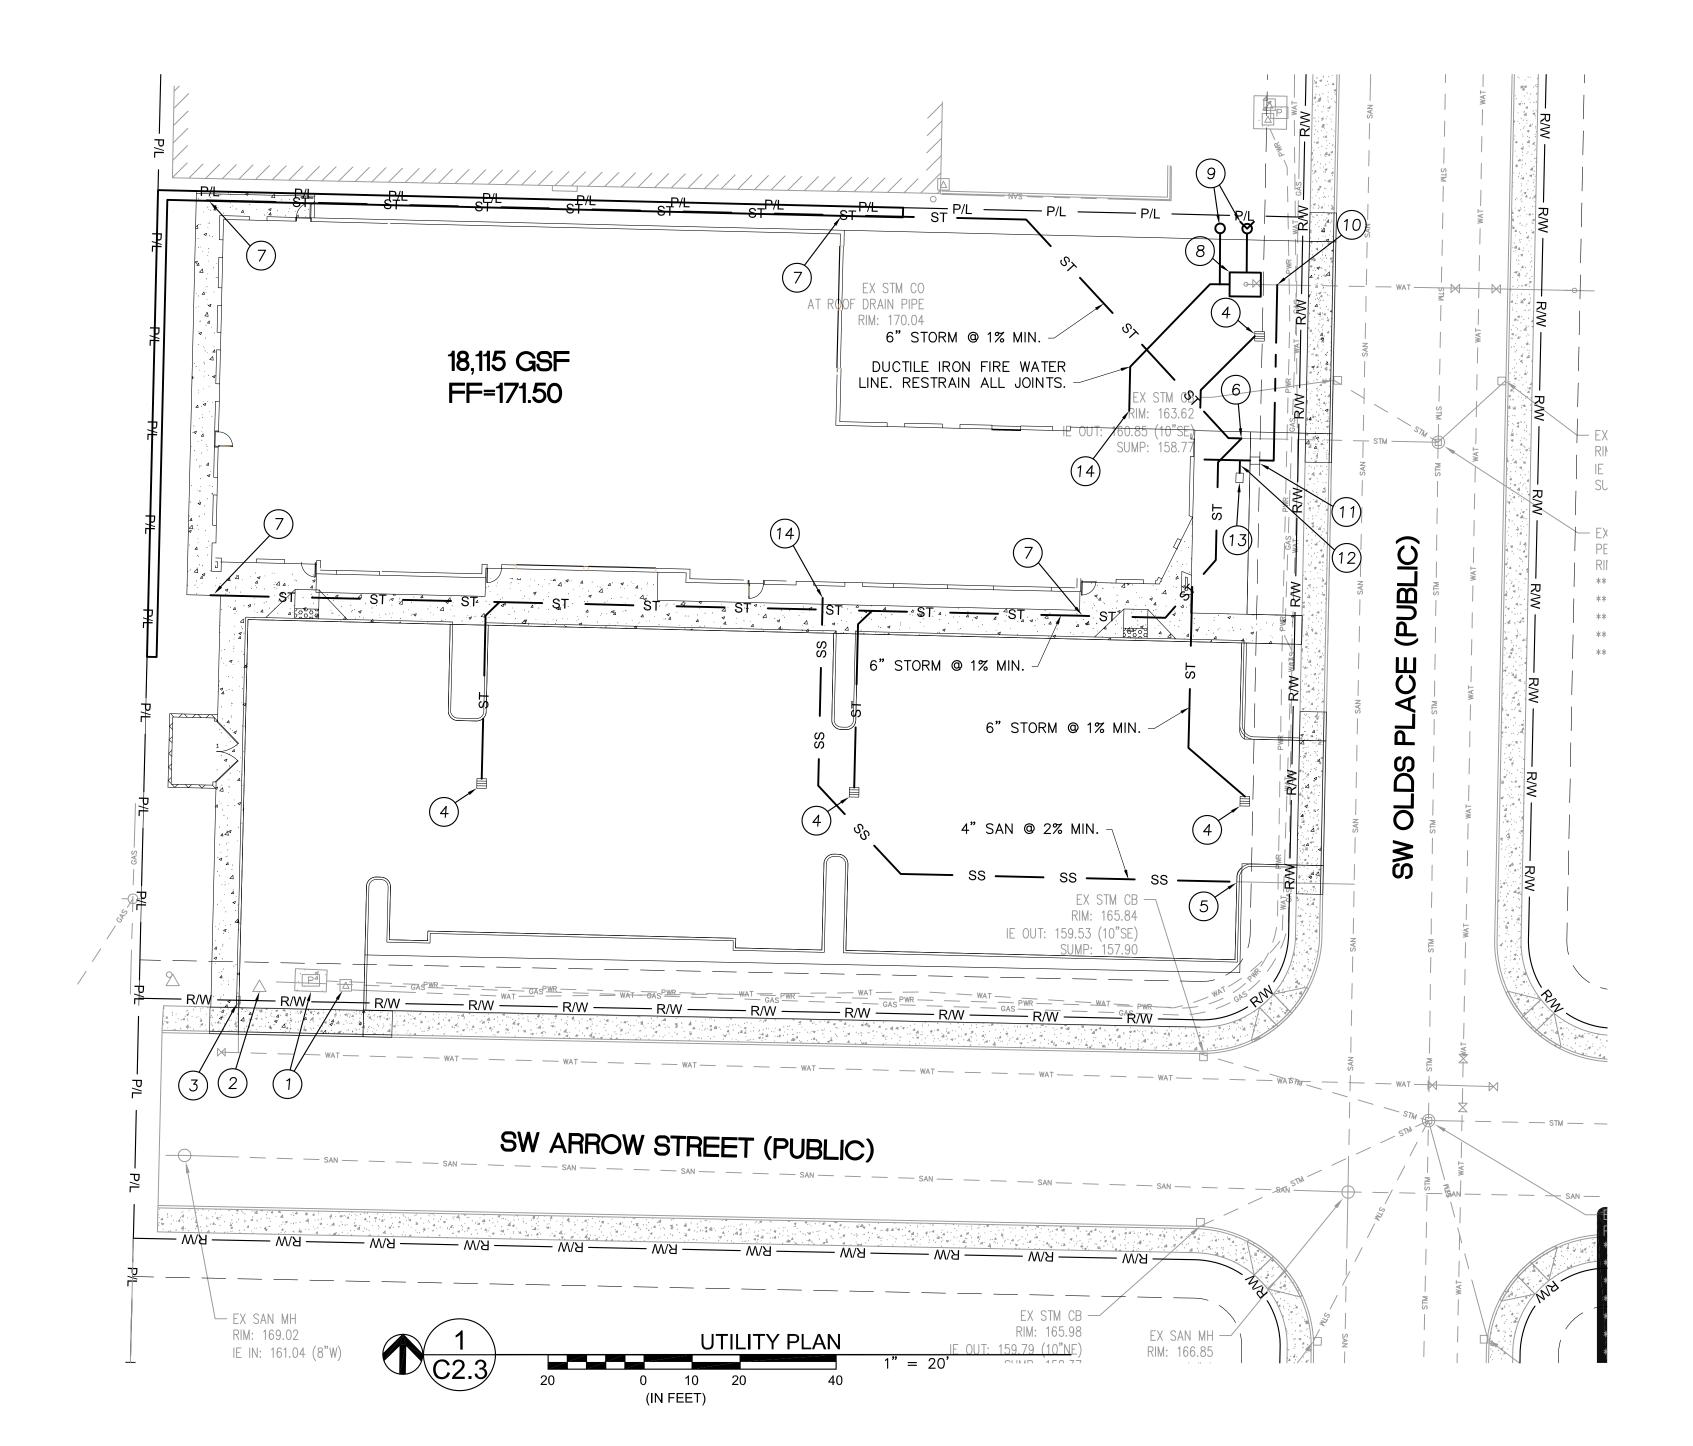
DRAWN BY: **JMH** APPROVED BY: **JMH**

SHEET:

JOB NO.:

DR SUBMITTAL - JULY 2021 20-026

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LEGEND

ASPHALT PAVING DRIVEWAY, CONCRETE PADS AND SIDEWALK CATCH BASIN WATER METER WATER VAULT FDC 6" VERTICAL CURB

EXISTING:

<u>_XISTING.</u>	
—— EOP—	EXISTING EDGE OF PAVEMENT
	STORM SEWER MANHOLE
— — STM —	STORM SEWER LINE
	CATCH BASIN
	WATER METER
— — — WAT —	WATER LINE
\bowtie	WATER VALVE
\bigcirc	SANITARY SEWER MANHOLE
— — — SAN —	SANITARY SEWER LINE
— — PWR —	UNDERGROUND POWER
P	POWER VAULT
Δ	POWER JUNCTION BOX
\triangle	COMMUNICATIONS JUNCTION BOX
GAS	GAS LINE
COM	UNDERGROUND COMMUNICATIONS LINE
R/W	RIGHT OF WAY
——— P/L ———	PROPERTY LINE

UTILITY NOTES

- ALL WORK SHALL CONFORM TO THE REQUIREMENTS OF THE CITY OF SHERWOOD, THE CURRENT EDITION OF THE UNIFORM PLUMBING CODE, AND THE INTERNATIONAL BUILDING CODE. ALL WORK IN THE PUBLIC R.O.W. REQUIRES A PUBLIC WORKS PERMIT.
- 2. THE WORKING DRAWINGS ARE GENERALLY DIAGRAMMATIC. THEY DO NOT SHOW EVERY OFFSET, BEND, OR ELBOW REQUIRED FOR INSTALLATION IN THE SPACE PROVIDED. THEY DO NOT SHOW EVERY DIMENSION, COMPONENT, PIECE, SECTION, JOINT OR FITTING REQUIRED TO COMPLETE THE PROJECT. ALL LOCATIONS FOR WORK SHALL BE CHECKED AND COORDINATED WITH EXISTING CONDITIONS IN THE FIELD BEFORE BEGINNING CONSTRUCTION. EXISTING UNDERGROUND UTILITIES LAYING WITHIN THE LIMITS OF EXCAVATION SHALL BE VERIFIED AS TO CONDITION, SIZE AND LOCATION BY UNCOVERING, PROVIDING SUCH IS PERMITTED BY LOCAL PUBLIC AUTHORITIES WITH JURISDICTION, BEFORE BEGINNING CONSTRUCTION. CONTRACTOR TO VERIFY EXISTING CONDITIONS WITH HIS/HER OWN RESOURCES PRIOR TO ORDERING MATERIALS, AND SHALL NOTIFY ENGINEER IF THERE ARE ANY DISCREPANCIES.
- 3. PROVIDE CLEANOUTS AS REQUIRED IN THE CURRENT UNIFORM PLUMBING CODE CHAPTER 7, SECTION 707 AND 719, AND CHAPTER 11, SECTION 1103.04. NOTE: NOT ALL REQUIRED CLEANOUTS ARE SHOWN ON THE PLANS.
- 4. ALL STORM PIPING IS SIZED FOR A MANNING'S N VALUE = 0.013. ALL STORM PIPING IS DESIGNED USING CONCENTRIC PIPE TO PIPE AND WYE FITTINGS, UNLESS OTHERWISE NOTED.
- 5. PER SECTION 313.2 OF THE OREGON SPECIALTY PLUMBING CODE, UTILITIES SHOWN UNDER OR WITHIN 5' OF ANY BUILDING OR STRUCTURE (INCLUDING ANY FOUNDATION DRAINAGE PIPING), OR LESS THAN 1' BELOW THE GROUND SURFACE, ARE TO BE CONSTRUCTED OF MATERIALS OTHER THAN THOSE APPROVED TO BE USED UNDER OR WITHIN A BUILDING. TABLE 7-1 AND SECTION 1101.3 LISTS
- APPROVED PIPE MATERIAL FOR SANITARY AND STORM DRAINAGE, RESPECTIVELY.

 6. VERIFY LOCATION, SIZE AND DEPTH OF EXISTING UTILITIES BY POTHOLING PRIOR TO CONSTRUCTION. NOTIFY ENGINEER OF ANY DISCREPANCIES.
- 7. CONTRACTOR TO MAINTAIN A MINIMUM OF 3' OF COVER OVER ALL WATER LINES.
 8. CONTRACTOR TO MAINTAIN A MINIMUM OF 18" OF COVER OVER ALL STORM LINES IN LANDSCAPED AREAS AND 24" OF COVER IN PAVED AREAS. STORM LINES MAY HAVE LESS THAN 24" OF COVER BUT NOT LESS THAN 12" OF COVER IN PAVED AREAS WHEN DUCTILE IRON PIPE IS USED. NOTIFY ENGINEER OF ANY DISCREPANCIES.
- 9. CONTRACTOR IS RESPONSIBLE FOR COMPATIBILITY BETWEEN PIPE MATERIALS, FITTINGS AND APPURTENANCES.
- 10. FOOTING DRAINS ARE REQUIRED AT ALL FOUNDATIONS AND BACK OF RETAINING WALLS PER PLUMBING CODE.
- 11. WHERE CONNECTING TO AN EXISTING PIPE, AND PRIOR TO ORDERING MATERIALS, THE CONTRACTOR SHALL EXPOSE THE END OF THE EXISTING PIPE AND VERIFY THE LOCATION, SIZE, AND ELEVATION WITH HIS/HER OWN RESOURCES, AND NOTIFY ENGINEER OF ANY DISCREPANCIES.
- 12. THE CONTRACTOR IS RESPONSIBLE FOR ENSURING THAT ALL HYDRANTS, FIRE SUPPRESSION AND FIRE SPRINKLER SYSTEMS SHALL ALSO COMPLY WITH THE LOCAL FIRE DISTRICT REQUIREMENTS.
- 13. CONTRACTOR IS RESPONSIBLE TO OBTAINING THE DESIGN, PERMITTING, AND FURNISHING OF ALL REQUIRED ELEMENTS, FOR COMPLETE INSTALLATION OF ELECTRICAL SERVICE TO VAULTS FOR SUMP PUMPS, INCLUDING SUMP PUMP AND PIPING.
- 14. ALL 4" WATER LINE AND ABOVE SHALL BE C900 OR APPROVED EQUAL. ALL WATER LINE LESS THAN 4" SHALL FOLLOW THE CURRENT EDITION OF THE OREGON SPECIALTY PLUMBING CODE AND CARRY A MINIMUM 200 PSI TEST PRESSURE OR AS REQUIRED BY THE AUTHORITY HAVING JURISDICTION.
- 15. LOCATION AND SIZE OF UTILITY VAULTS SHOWN IS APPROXIMATE ONLY.
 CONTRACTOR SHALL COORDINATE LOCATION, SIZE AND PLACEMENT OF ALL
 VAULTS WITH AUTHORITY HAVING JURISDICTION PRIOR TO ORDERING MATERIALS.
 NOTIFY ENGINEER OF ANY DISCREPANCIES.
- 16. SET VAULT LIDS 3 INCHES HIGHER THAN SURROUNDING GROUND IN LANDSCAPED AREAS OR FLUSH WITH PAVED AREAS, OR PER LOCAL JURISDICTION STANDARDS.
- NOTIFY ENGINEER OF ANY DISCREPANCIES PRIOR TO INSTALLATION.

 17. CONTRACTOR IS RESPONSIBLE FOR INSTALLING UTILITY LINES OUT OF THE ZONE OF INFLUENCE OF ALL BUILDING AND OTHER FOOTINGS PER 8/C8.1.

CONSTRUCTION NOTES

PROPOSED ON SITE.



- 1. RELOCATE POWER VAULT AND PEDESTAL OUT OF DRIVEWAY. CONTRACTOR TO COORDINATE RELOCATION WITH UTILITY.
- 2. RELOCATE COMMUNICATION PEDESTAL OUT OF DRIVEWAY. CONTRACTOR TO COORDINATE RELOCATION WITH UTILITY.
- 3. RELOCATE WATER METER OUT OF DRIVEWAY. CONTRACTOR TO COORDINATE RELOCATION WITH UTILITY.
- 4. INSTALL CATCH BASIN W/ 6" STORM LINE OUTLET.
- CONNECT SANITARY SEWER TO EXISTING SANITARY STUB. IE=156.76 VERIFY.
 CONNECT STORM SEWER TO EXISTING STORM STUB. IE=158.73 VERIFY.
 REGIONAL WATER QUALITY IS PROVIDED. NO STORMWATER MANAGEMENT IS
- 7. CONTRACTOR TO VERIFY LOCATION OF DOWNSPOUTS AND INSTALL WYE AS NECESSARY FOR CONNECTION TO STORM LINE. VERIFY WITH ARCH PLANS FOR LOCATIONS.
- 8. VAULT FOR BACKFLOW PREVENTION FOR FIRE WATER LINE. CONNECT BACKFLOW PREVENTION TO EXISTING WATER LINE STUB.
- 9. FDC AND PIV WITH DUCTILE IRON WATER LINE TO VAULT. RESTRAIN ALL JOINTS. INSTALL SIGNAGE PER FIRE DEPT. STANDARDS.
- 10. INSTALL TEE AND 2" WATER LINE TO DOMESTIC WATER METER.
- 11. INSTALL WATER METER IN VALVE BOX.
- 12. INSTALL TEE AND 1" WATER LINE FOR IRRIGATION.
- 13. INSTALL BACKFLOW PREVENTION IN VALVE BOX FOR IRRIGATION LINE.
- 14. CONNECT PIPE INSIDE BUILDING PER PLUMBING PLAN.

Inkbuilt Architecture

Green Ridge Solar

Sherwood, OR

20737 SW Olds Place

Project

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REVISION SCHEDULE:
REVISION DELTA ISSUE DATE

SHEET TITLE:

UTILITY
PLAN

DRAWN BY: **JMH**APPROVED BY: **JMH**

SHEET:

C2.3

JOB NO.:

DR SUBMITTAL - JULY 2021 20-026

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MIN. SETBACK

& LANDSCAPE **BUFER EXTENTS**

4' TALL —

RETAINING WALL

CONCRETE SIDEWALK

BUTTERFIELD

TESTING

CANQPY ABOVE

ENTRY PLAZA

TRASH

EXISTING BUILDING

FLOOR-MOUNTED

— 9' x 20' ADA STALL W/ 6'

8' x 18' COMPACT STALL SIZE, —

CMU TRASH ENCLOSURE W/_

METAL GATE. SEE A2.00 FOR

ACÇESŚ AISLE

TYP OF 9

ELEVATIONS.

BIKE RACK, 2 SPACES

INDUSTRIAL

WAREHOUSE

FIRE DEPT AERIAL ACCESS

1,50', HOSE LENGTHEROM

FIRE DEPT. AERIAL ACCESS

FIRE LANE - NO PARKING

10' MIN. LANDSCAPE CORRIDOR ALONG SW ARROW

SW ARROW ST

25' AND 45' FIRE LAND TURNING RADIUS

MIN. SETBACK ---

PUE EASEMENT

EXTENTS



A. SEE PLANTING PLANS FOR PLANTING INFORMATION.

SEE CIVIL FOR ON-SITE GRADING AND UTILITY INFORMATION. INSTALL REQUIRED SIGNAGE INCLUDING BUT NOT LIMITED TO BUILDING ADDRESS, FIRE DEPARTMENT CONNECTION,

FIRE RISER ACCESS, ETC. SEE SHEET A5.01. D. SLOPE FINISHED GRADE AT 2% MINIMUM AWAY FROM STRUCTURE FOR A DISTANCE OF 10'.

SLOPE IMPERVIOUS PEDESTRIAN WALKWAYS AND STAIRS TO DRAIN OR PERVIOUS PLANTER AT 1.5%.

PROVIDE CONTINUOUS FOOTING DRAINS, ROUTE TO FACILITY PER CIVIL.

ROUTE ALL DRAINS/DOWNSPOUTS TO FACILITIES, SEE CIVIL. PROVIDE WHEEL STOPS AT ALL PARKING SPACES. 4" HIGH BY 3' LONG, LOCATED 3' FROM THE END OF THE PARKING

SPACE. I. ALL EXTERIOR LIGHTING IS BUILDING MOUNTED. SEE ELEVATIONS FOR LOCATIONS.

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BUILDING AREA SCHEDULE AREA

1-GROUND	OFFICE 1	2,786 SF
1-GROUND	OFFICE 2	2,575 SF
1-GROUND	WAREHOUSE	6,603 SF
		11,964 SF

2-SECOND	OFFICE 1	2,786
2-SECOND	OFFICE 2	2,614
		5,401
GRAND TOTAL		17,365

ZONING REQUIREMENTS

PARKING REQUIREMENTS, SMC 16.94.020.A 6,603 GSF INDUSTRIAL * 1.6/1,000 = 11 CAR SPACES = 1 BIKE SPACE 10,762 GSF OFFICE * 2.7/1,000 = 29 CAR SPACES = 2 BIKE SPACES 40 PARKING SPACES REQ'D

40 PARKING SPACES PROVIDED, 9 ARE COMPACT (25% COMPACT MA

BIKE PARKING 3 BIKE PARKING SPACES REQ'D 4 BIKE PARKING SPACES PROVIDED

SEE A0.51 PLANTING PLAN FOR LANDSCAPING INFO.


DQUARTER AR 64 RIDGE (GREEN 20737 SW OLDS PL/

SITE PLAN REVIEW

ISSUE DATE 07/26/2021

REVISIONS

SITE PLAN & CODE **SUMMARY**

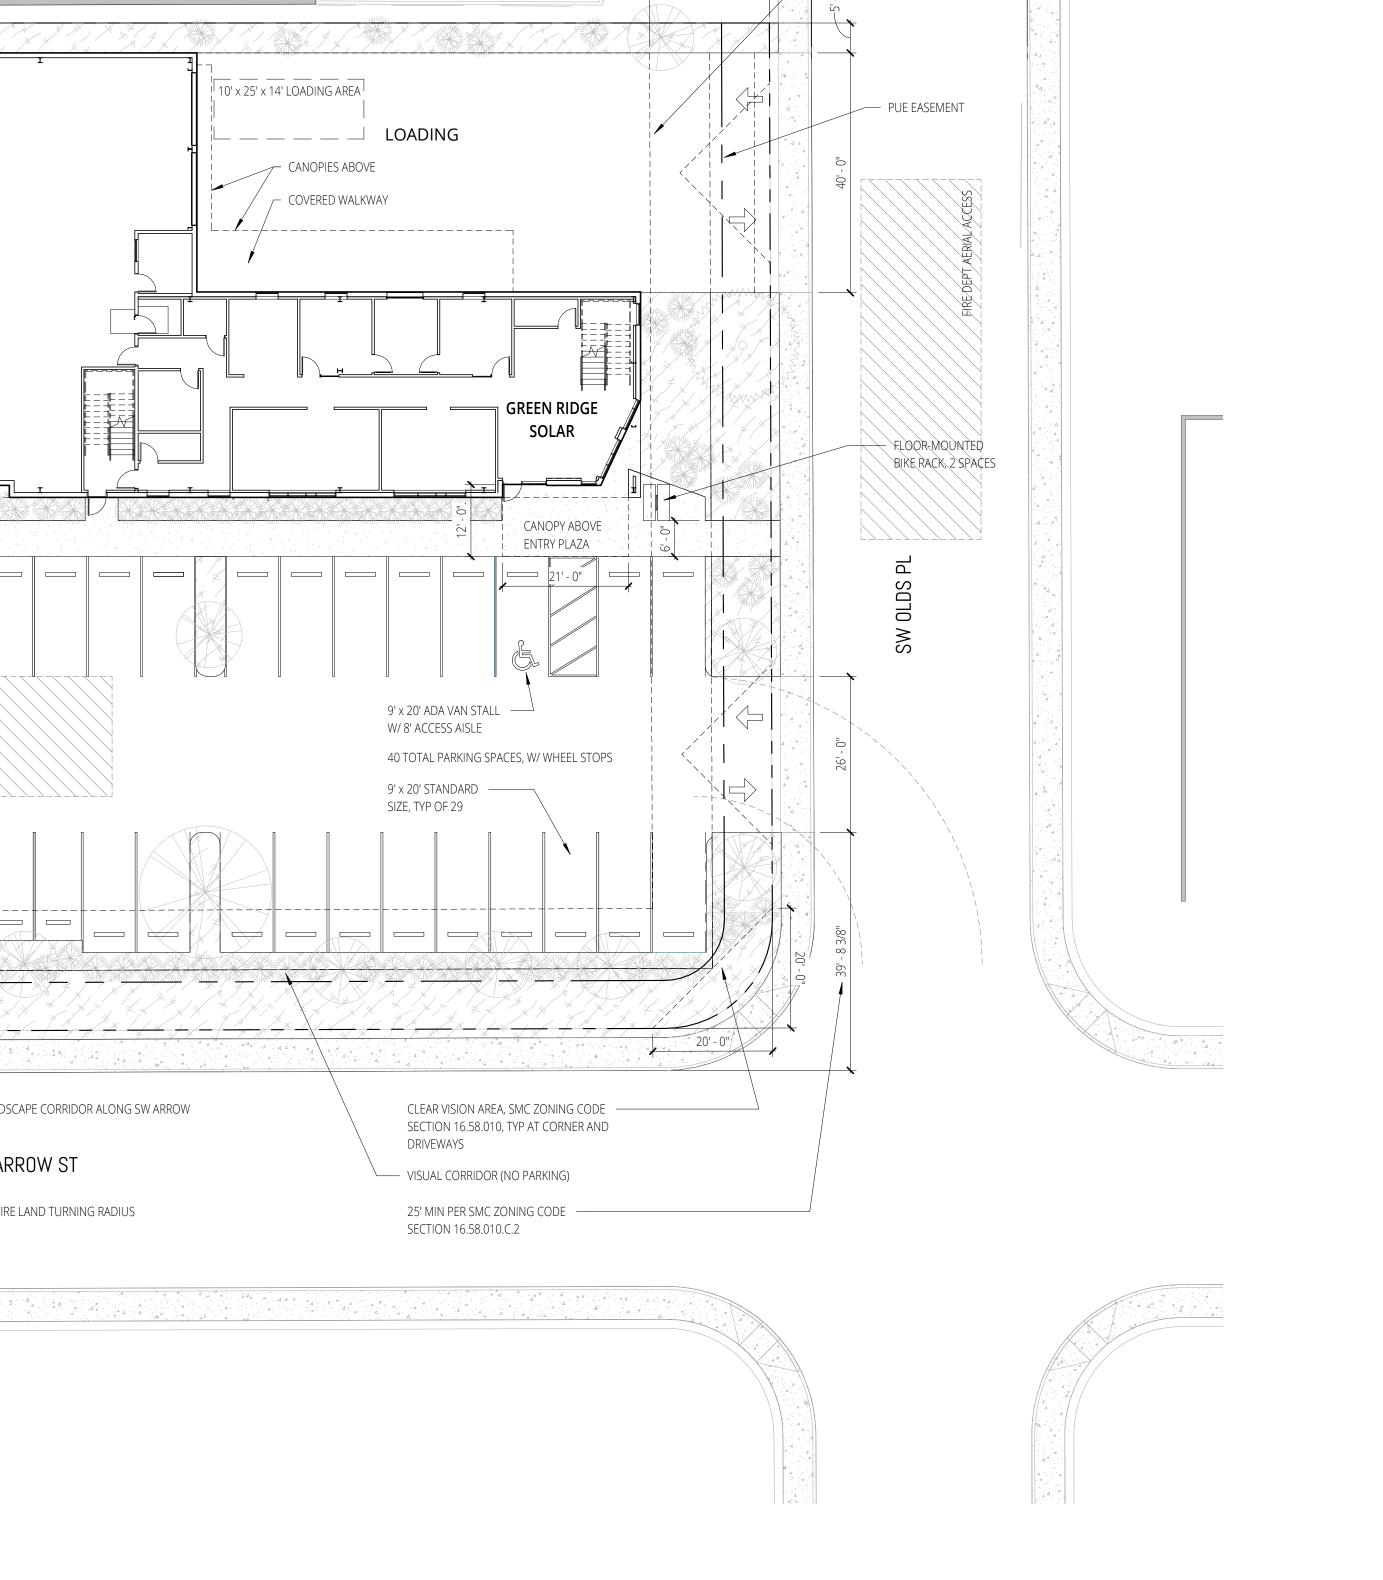

36' - 0"

FIRE DEPT AERIAL ACCESS ROAD

MIN. SETBACK

EXTENTS

20' - 0"

EXISTING PARKING LOT

10' x 25' x 14' LOADING AREA

- CANOPIES ABOVE

245' - 8"

5' MIN. LANDSCAPE -

BUFER EXTENTS

EXISTING BUILDING

/— SPANISH LAVENDER (Lavendula Stoechas) AT 2' O.C. —

EDGE, AT 1' O.C.

LARGE DECIDUOUS TREE,

— GROUNDCOVER - SEDGE (Carex

morrowi) AT 1.5' O.C.

TYP OF 2

WITH BLUE FESCUE (Festuca Glauca) ALONG SIDEWALK

SHRUBS AT PERIMETER - WESTERN SPIRAEA HARDHACK (Spiraea douglasii), TYP. —

GROUNDCOVER - CREEPING OREGON GRAPE (Mahonia repens) AT2' OC.C

SHRUBS AT PERIMETER - WESTERN SPIRAEA HARDHACK (Spiraea douglasii), TYP.

210' - 1 1/2"

– GROUND COVER - SPREADING COYOTE BUSH (Baccharis – magillanicus) AT 4' O.C. IN LANDSCAPE ISLANDS AND

SW ARROW ST

SURROUNDING PARKING AREA

64' - 2"

EXISTING PARKING LOT

- MEDIUM DECIDUOUS TREE,

SHRUB, TYP OF 82 SURROUNDING

(Symphoricarpos albus) AT 3' O.C.

- GROUNDCOVER - SEDGE (Carex

morrowi) AT 1.5' O.C.

PARKING AREA - SNOWBERRY

5' - 0"

TYP, UNO

EXISTING LANDSCAPING

CLEAR VISION TRIANGLE

— PUE EASEMENT EXTENTS

PERIMETER LANDSCAPE BUFFER PLANTING, TYP

- SHRUBS - CAUCASIAN DAPHNE (Daphne caucasica), TYP.

GROUNDCOVER - SEDGE (Carex morrowi) AT

— SHRUBS - CAUCASIAN DAPHNE (Daphne caucasica), TYP.

GROUNDCOVER - SEDGE (Carex morrowi) AT

- SMALL DECIDUOUS TREE, TYP OF 9

- GROUNDCOVER - SEDGE (Carex morrowi) AT

- 10' MIN. LANDSCAPE BUFFER EXTENTS

SMALL EVERGREEN TREE

1.5' O.C.

1.5' O.C.

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A 04

SHERW

REVISIONS

SEE CIVIL FOR ON-SITE GRADING AND UTILITY INFORMATION.

PROVIDE PERMANENT DRIP IRRIGATION SYSTEM WITH

PREPARE AND AMEND THE TOPSOIL AND SUBSOIL AS

RECOMMENDED FOR EACH TYPE OF PLANT SELECTED. PLANT MATERIALS MUST BE INSTALLED TO CURRENT NURSERY INDUSTRY STANDARDS. PLANT MATERIALS MUST BE PROPERLY SUPPORTED TO ENSURE SURVIVAL. SUPPORT DEVICES SUCH AS GUY WIRES OR STAKES MUST NOT INTERFERE WITH VEHICULAR OR PEDESTRIAN MOVEMENT.

ZONING REQUIREMENTS

PERIMETER LANDSCAPE BUFFER ZONE, SMC 16.92.030.A 10' AT STREETS. REDUCED TO 5' AT INTERIOR LOT LINES. SHOWN WITH

PARKING AREA LANDSCAPING, SMC 16.92.030.B

1,800 SF REQ'D (40 PARKING SPACES * 45 SF PER SPACE) 2,816 SF PROVIDED.

SMALL < 40 MEDIUM 40 < 90 LARGE > 90

10 SMALL TREES @ 1 PER 2 PARKING SPACES = 20 PARKING SPACES 4 MEDIUM TREES@ 1 PER 3 PARKING SPACES = 12 PARKING SPACES 2 LARGE TREES @ 1 PER 4 PARKING SPACES = 8 PARKING SPACES

2 SHRUBS REQ'D PER PARKING SPACE = 80 SHRUBS REQ'D

PLANT SELECTIONS

A. SMALL DECIDUOUS TREE = Alternate PAPERBARK MAPLE (Acer Griseum) and JAPANESE MAPLE (Acer Palmatum - not

B. SMALL EVERGREEN TREE = COLORADO BLUE SPRUCE (Picea

C. MEDIUM DECIDUOUS TREE = SARGENT CHERRY (Prunus

D. LARGE DECIDUOUS TREE = OREGON WHITE OAK (Quercus

PLANTING.

2. SHRUBS

PARKING AREA LANDSCAPE: A. SPANISH LAVENDER (Lavendula Stoechas) B. SNOWBERRY (Symphoricarpos albus

C. CAUCASIAN DAPHNE (Daphne caucasica), D. WESTERN SPIRAEA HARDHACK (Spiraea douglasii)

YEARS OF PLANTING.

PARKING AREA LANDSCAPE: B. BLUE FESCUE (Festuca Glauca)

PERIMETER LANDSCAPE: C. SEDGE (Carex morrowi)

A. SEE ARCHITECTURAL SITE PLAN FOR ADDITIONAL SITE INFORMATION.

AUTOMATIC CONTROLLER.

DASHED LINES ON PLANTING PLAN.

REQUIRED LANDSCAPING QUANTITIES:

TREE CANOPY FACTOR:

TREE COMBINATIONS:

20 + 12 + 8 = 40 = 40 PROVIDED PARKING SPACES

> 5% OF REQUIRED TREES MUST BE EVERGREEN 1 OF 16 TREES PROVIDED ARE EVERGREEN

82 SHRUBS PROVIDED

NOTE: ALL TREES TO BE 6' MINIMUM HEIGHT, 2" MINIMUM CALIPER SIZE, AND FULLY BRANCHED AT THE TIME OF

PERIMETER LANDSCAPE:

NOTE: ALL SHRUBS TO BE ONE GALLON CONTAINER SIZE OR LARGER AT THE TIME OF PLANTING, AND SHALL BE OF SUFFICIENT SIZE TO BE AT FULL GROWTH WITHIN THREE

3. GROUND COVER PLANTS

A. SPREADING COYOTE BUSH (Baccharis magillanicus)

D. CREEPING OREGON GRAPE (Mahonia repens)

NOTE: ALL LANDSCAPE AREA THAT IS NOT PLANTED WITH TREES AND SHRUBS SHALL BE PLANTED IN GROUND COVER PLANTS. GROUND COVER PLANTS OTHER THAN GRASSES MUST BE AT LEAST THE FOUR-INCH POT SIZE AND SPACED AT DISTANCES APPROPRIATE FOR THE PLANT SPECIES. GROUND COVER PLANTS SHALL BE OF SUFFICIENT SIZE, QUANTITY, AND SPACING TO BE AT FULL GROWTH WITHIN THREE YEARS OF PLANTING.

SITE PLAN REVIEW

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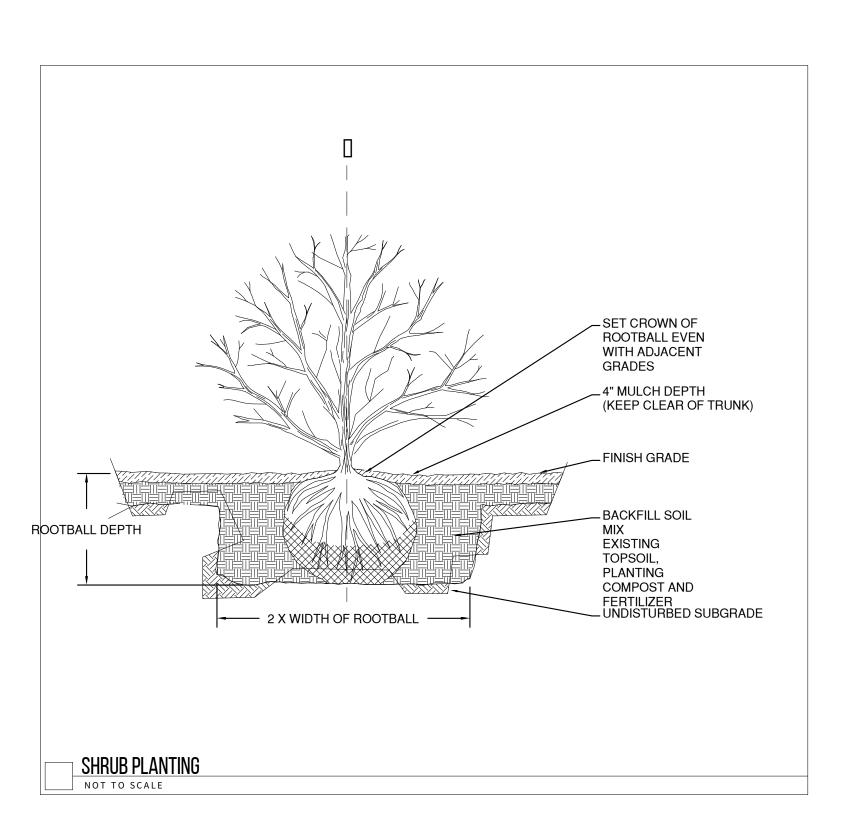
LANDSCAPE PLAN


1. EXCAVATE 2 $\frac{1}{2}$ TIMES THE SIZE OF

WITHOUT CAUSING DAMAGE TO ROOT

2. CAREFULLY REMOVE AS MUCH OF BURLAP AND BASKET AS POSSIBLE

ROOT BALL OR TREE WALL DIMENSIONS.



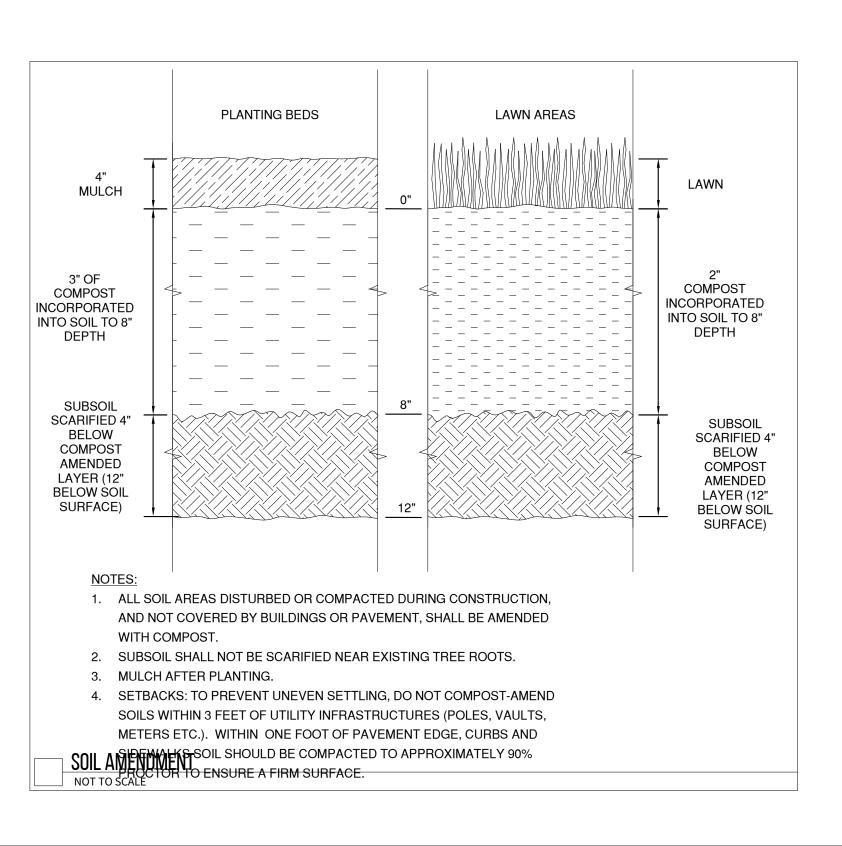

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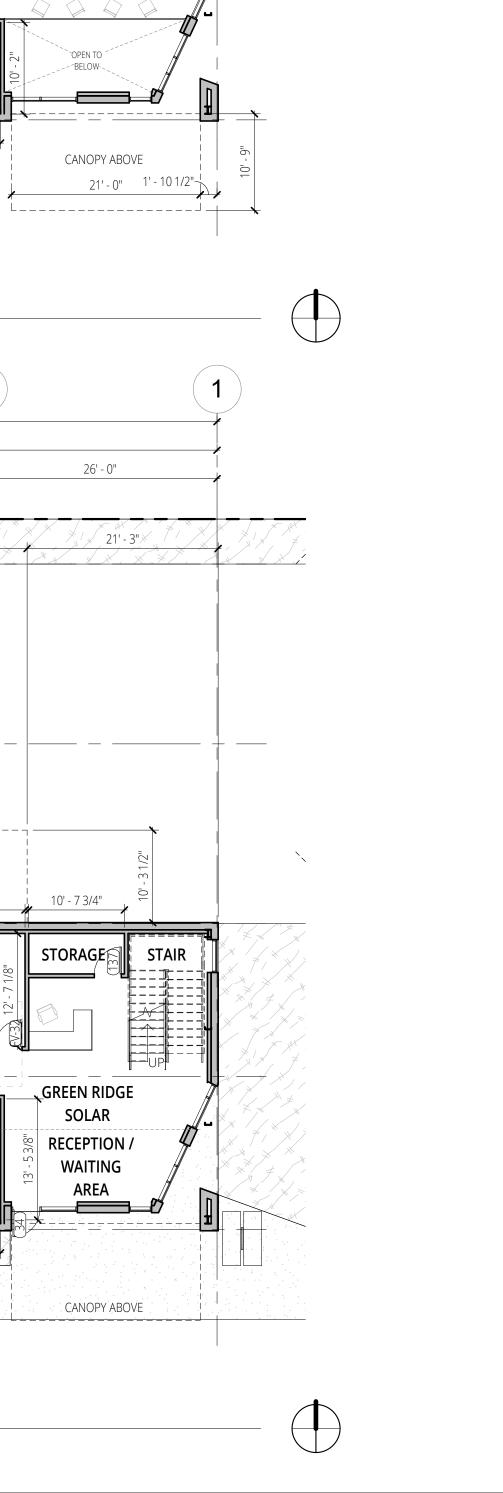
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LANDSCAPE

LU0.52



204' - 0"

26' - 0"

STAIR

26' - 0"

PROCUREMEN

MANAGER

STORAGE

204' - 0"

26' - 0"

INDU\$TRIAL WAREHOUSE

75' - 4 1/8".

24' - 0"

CANOPIES ABOVE

26' - 3 7/8"

SALES OPEN

OFFICE

CALL CENTER

OPEN OFFICE

30' - 4 1/2"

24' - 0"

┌── CANOPIES ABOVE

— COVERED WALKWAY

PM OFFICE

SPACE

BREAK ROOM

LOUNGE

52' - 10 1/2"

<u>8' - 0"</u>

RM

ASST. SALES

10' - 0"

74' - 0"

24' - 0"

LOADING

OWNER

LOUNGE

MARKETING

OFFICE SPACE

GREEN RIDGE

SOLAR

MANAGER | MANAGER

10' - 0"

CONF RM

26' - 0"

74' - 0"

26' - 0"

24' - 0"

130' - 0"

26' - 0"

130' - 0"

26' - 0"

INDUSTRIAL

WAREHOUSE

DOUBLE HEIGHT SPACE

OPEN TO BELOW

26' - 0"

13' - 4 1/4"

OFFICE

OFFICE

BUTTERFIELD

TESTING

CANOPY ABOVE

25' - 1 5/8"

26' - 0"

SERVICES

SERVICES

TESTING SERVICES

COLLECTORS

ROOM

MANAGER

OFFICE

1' - 10 1/2"

2 SECOND FLOOR PLAN
3/32" = 1'-0"

Α

В

(**D**)

 $\left[\mathsf{E}\right]$

B

 $\left[\mathbf{C} \right]$

D

E

1 GROUND FLOOR PLAN
3/32" = 1'-0"

26' - 0"

CONF RM

WORKOUT RM

(63) **RR W/**

SHOWER

BREAK ROOM

/ LOUNGE

STAIR

26' - 0"

STORAGE

RR

BUTTERFIELD TESTING

TESTING

CANOPY ABOVE



- A. SEE ASSEMBLIES SHEET A0.70 OR 0.71 FOR WALL DIMENSION POINT LOCATIONS.
- DOOR HINGE JAMBS TO BE LOCATED 2 1/2" FROM FACE OF FINISH OF THE NEAREST PERPENDICULAR ADJACENT WALL,
- C. PROVIDE BLOCKING PER MFR RECOMMENDATIONS, AS SHOWN ON A5.01 FOR ALL WALL MOUNTED ACCESSORIES
- AND EQUIPMENT, AND AS OTHERWISE INDICATED. D. SEE A3.XX INTERIOR COMPOSITE SHEETS FOR ENLARGED PLANS/RCPS, INTERIOR ELEVATIONS, AND ADDITIONAL
- INFORMATION. INTERIOR WALLS TO BE INSULATED WHERE PLUMBING OCCURS AND AT ALL OTHER LOCATIONS REQUIRED PER
- ASSEMBLY OR NOTE. F. PROVIDE IDENTIFICATION SIGNS AT 1-HR FIRE PARTITIONS (MATE WALLS) AND STAIR ENCLOSURE WALLS ABOVE ACCESSIBLE CORRIDOR CEILING WITH 3" LETTERING PER OSSC 703.7.

FLOOR PLAN LEGEND

TYPICAL WALLS

INTERIOR | NON-BEARING TYPE A | TYPICAL | FURRING

EXTERIOR WALLS EXTERIOR FRAME | BEARING

TYPE E STRUCTURAL WALLS

> INTERIOR FRAME | BEARING TYPE B

CONCRETE WALLS EXTERIOR | CONCRETE | BEARING TYPE G

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FLOOR PLANS

ROOF PLAN NOTES

A. SLOPE ALL TAPERED INSULATION TO DRAIN AT 1/4" PER FOOT MINIMUM. MAINTAIN 3" MINIMUM THICKNESS AT LOV' POINTS / DRAINS. B. CONSOLIDATE PLUMBING VENT PENETRATIONS,

COORDINATE LOCATIONS RELATIVE TO OTHER ELEMENTS, AND TERMINATE PER ROOFING MANUFACTURER DETAILS. C. TRANSITION, TERMINATE, AND SEAL ALL JOINTS, OPENINTS, AND PENETRATIONS IN ROOFING MATERIALS PER

MANUFACTURER'S INSTRUCTIONS TO MAINTAIN FULL WARRANTY COVERAGE. D. ALL ROOF DRAIN PIPING / DOWNSPOUTS TO ROUTE TO

STORMWATER FACILITIES, SEE PLUMBING. E. SOLAR PANEL SYSTEM IS DELEGATED DESIGN UNDER SEPARATE PERMIT. COORDINATE ATTACHMENT PENETRATIONS AND TERMINATE ROOFING PER

MANUFACTURER DETAILS. F. ROOF MAINTENANCE ANCHOR/DAVIT LOCATIONS SHOWN REFLECT GENERAL GUIDANCE FOR PROJECT SCOPE. CONTRACTOR TO COORDINATE FINAL LOCATIONS PER MANUFACTURER AND APPLICABLE CODES FOR SAFE ROOF MAINTENANCE ACCESS.

ROOF PLAN LEGEND

SOLAR PANEL
SEPARATE PERMIT,
COORDINATE ATTACHMENTS

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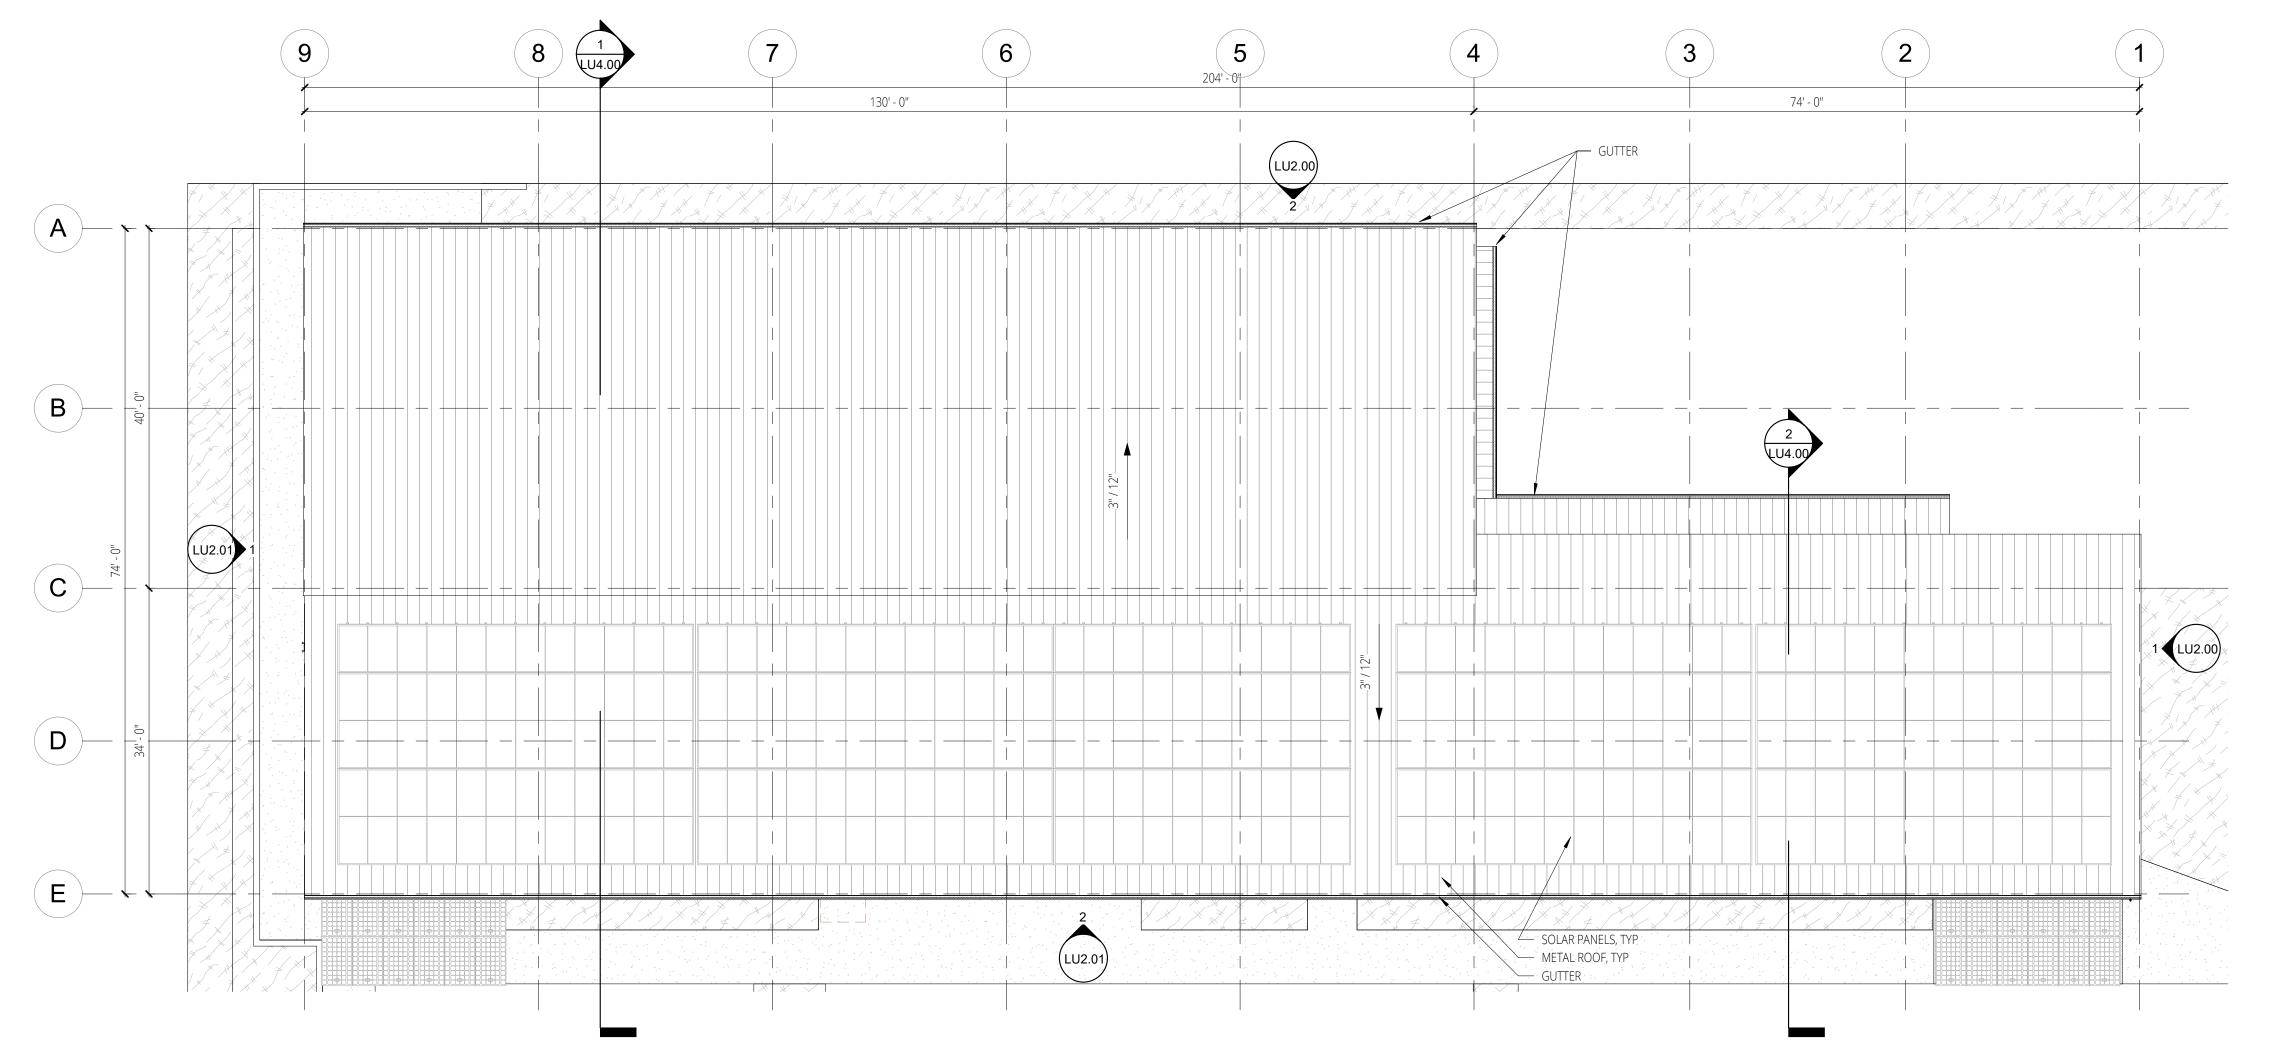
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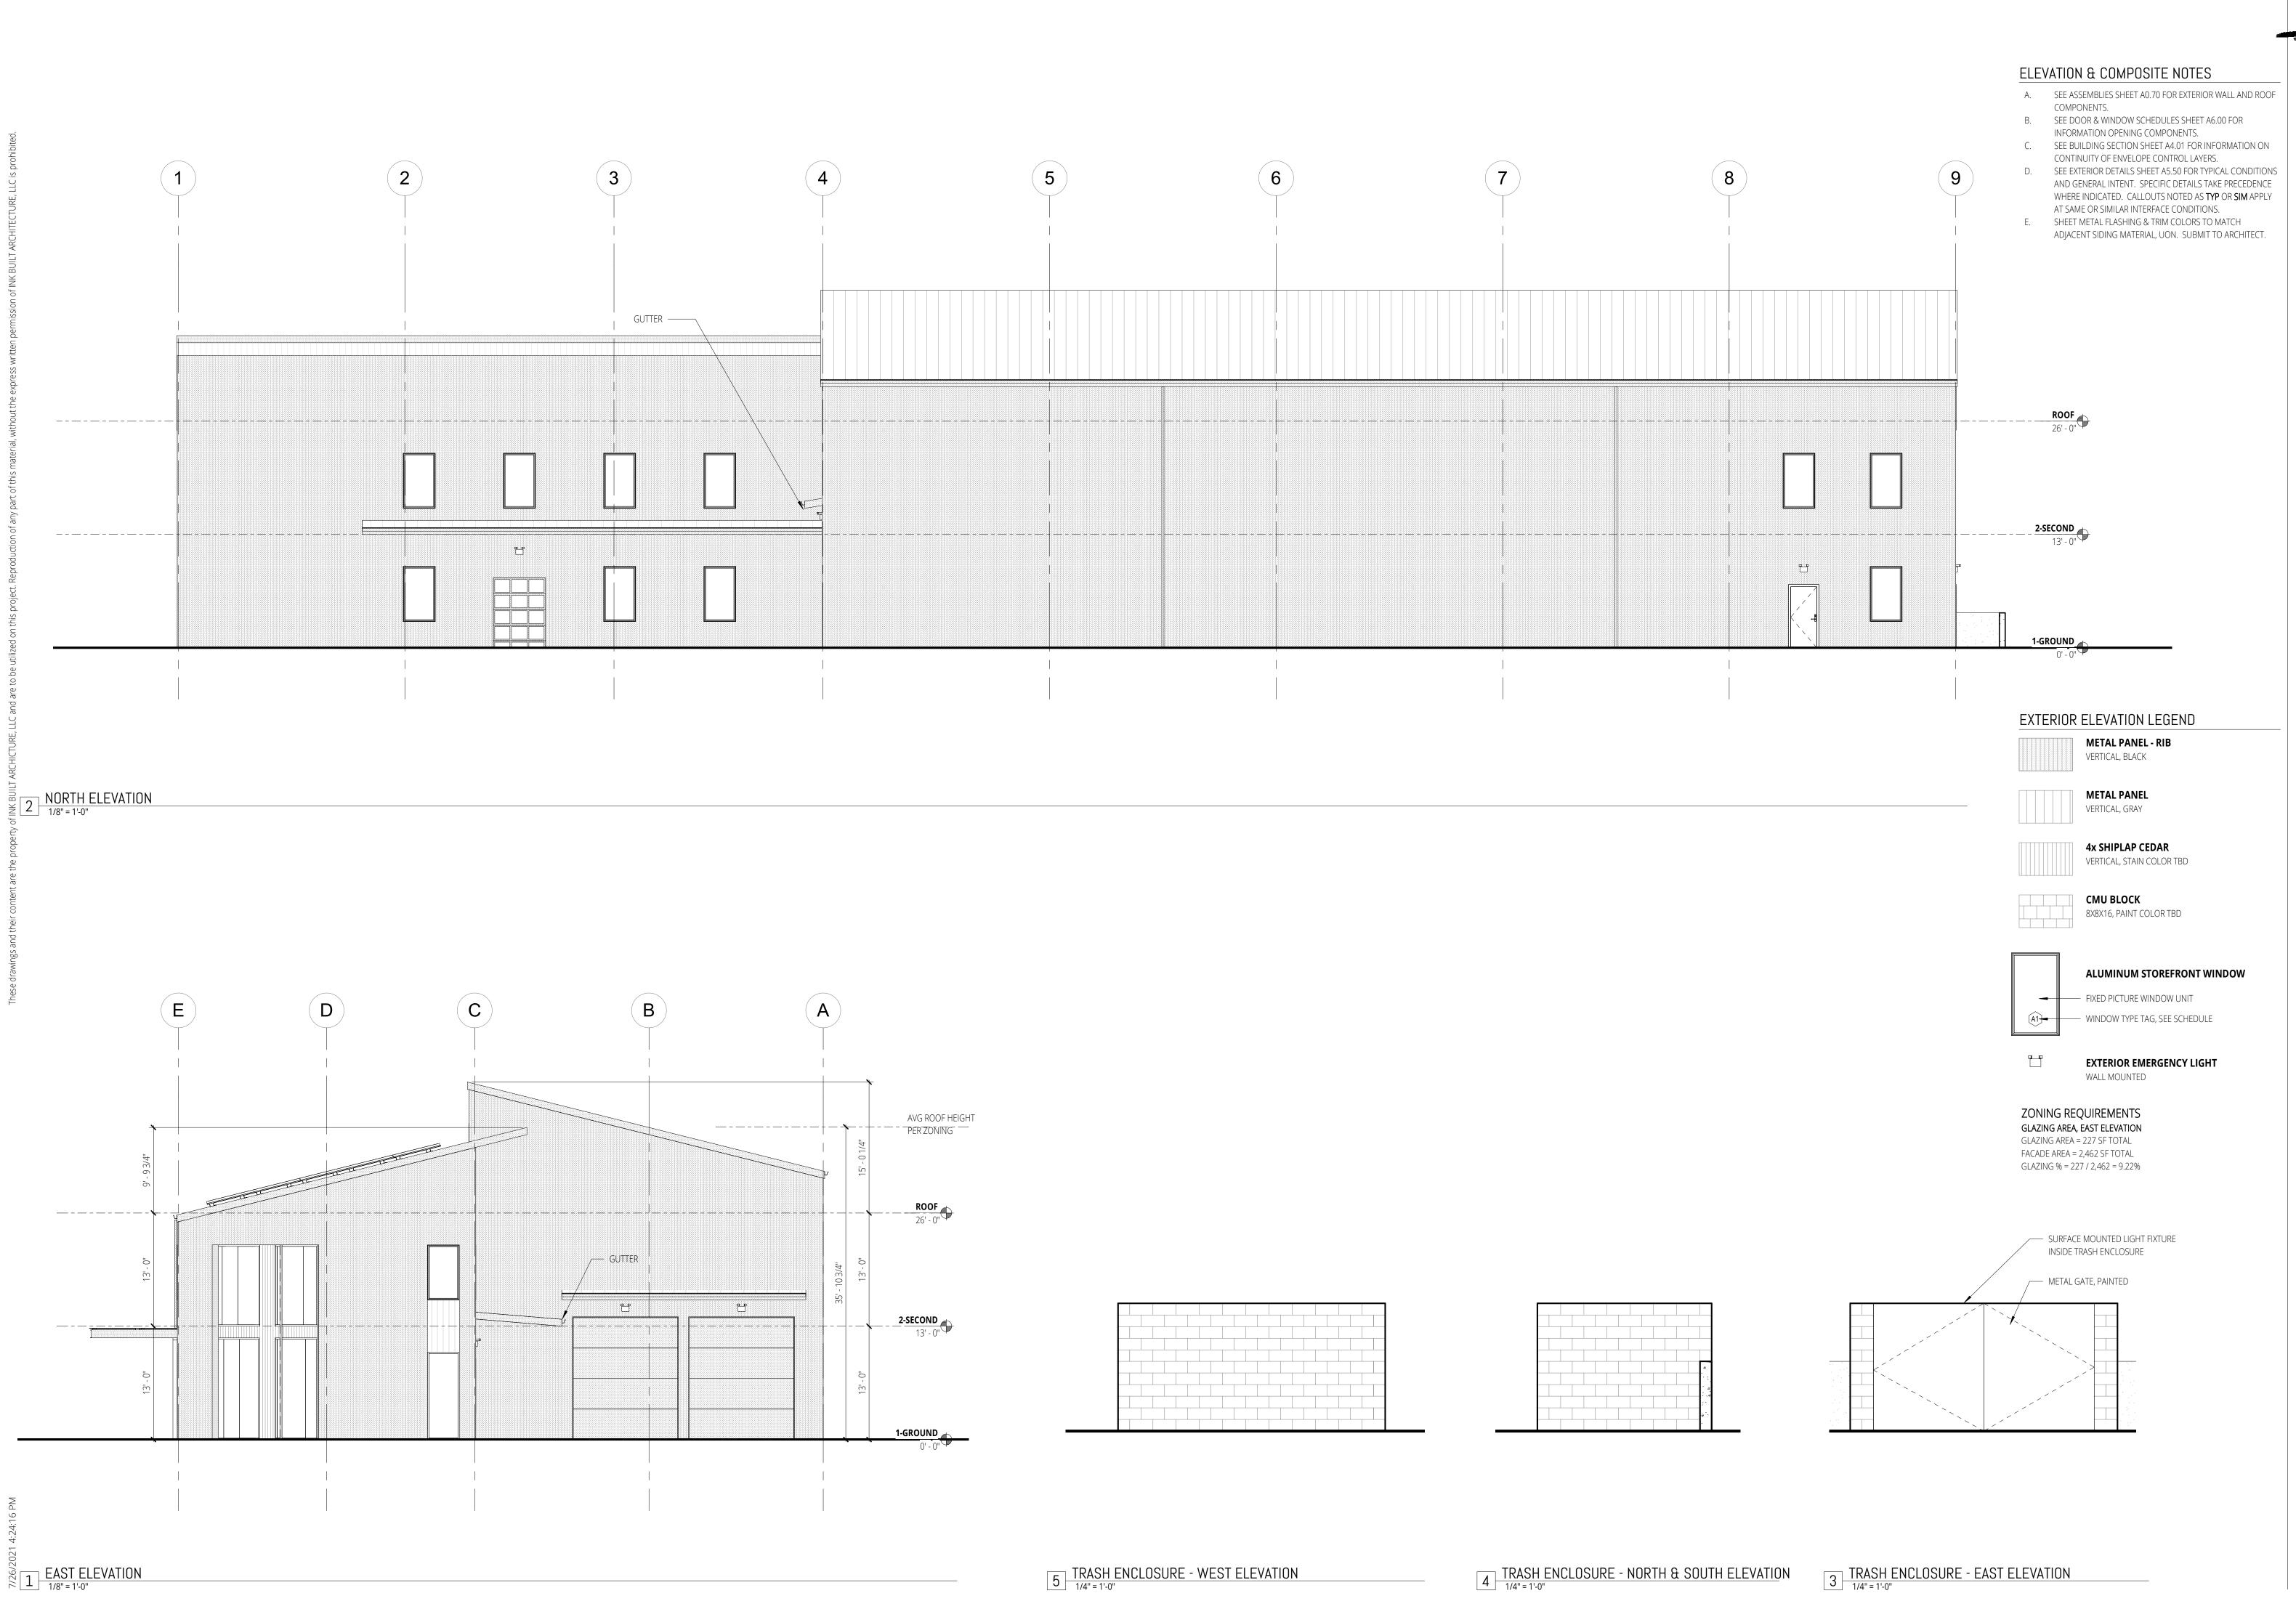
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ROOF PLAN





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EXTERIOR

ELEVATIONS

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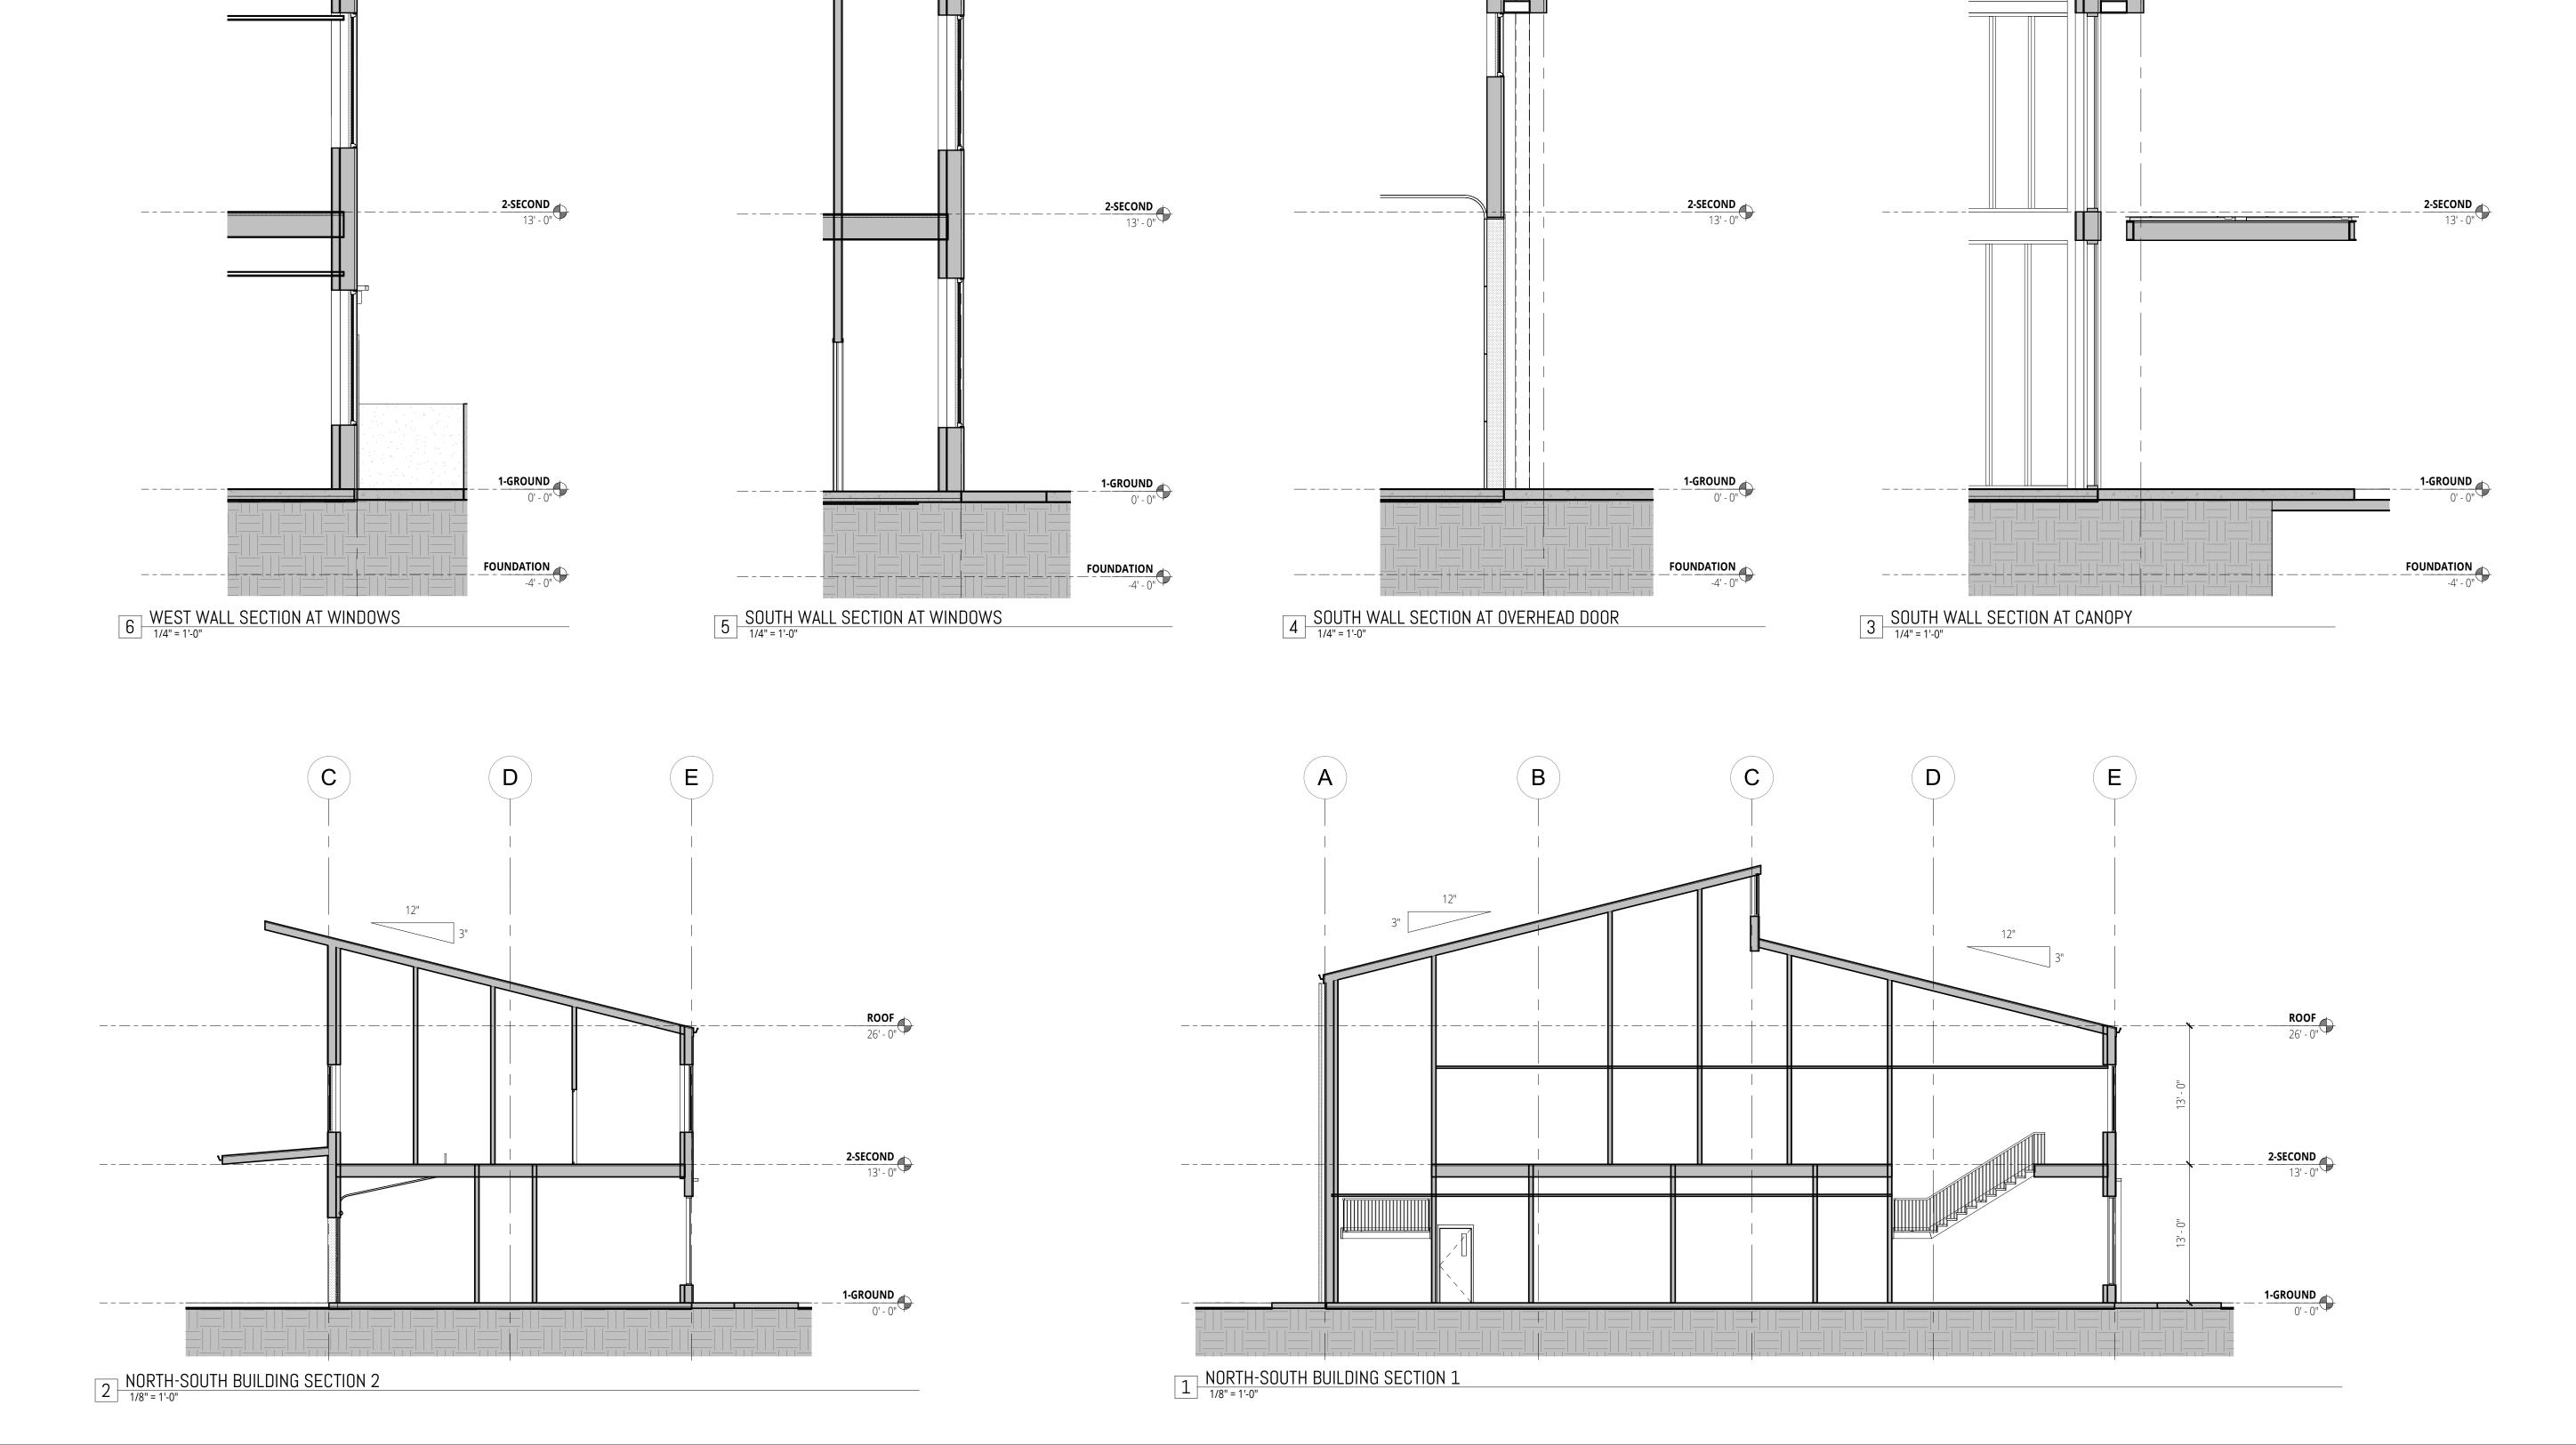
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ROOF 26' - 0"

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