

CEDAR CREEK APARTMENTS

16864 SW EDY ROAD SHERWOOD, OR 97140

LAND USE REVIEW SET 06.18.2021

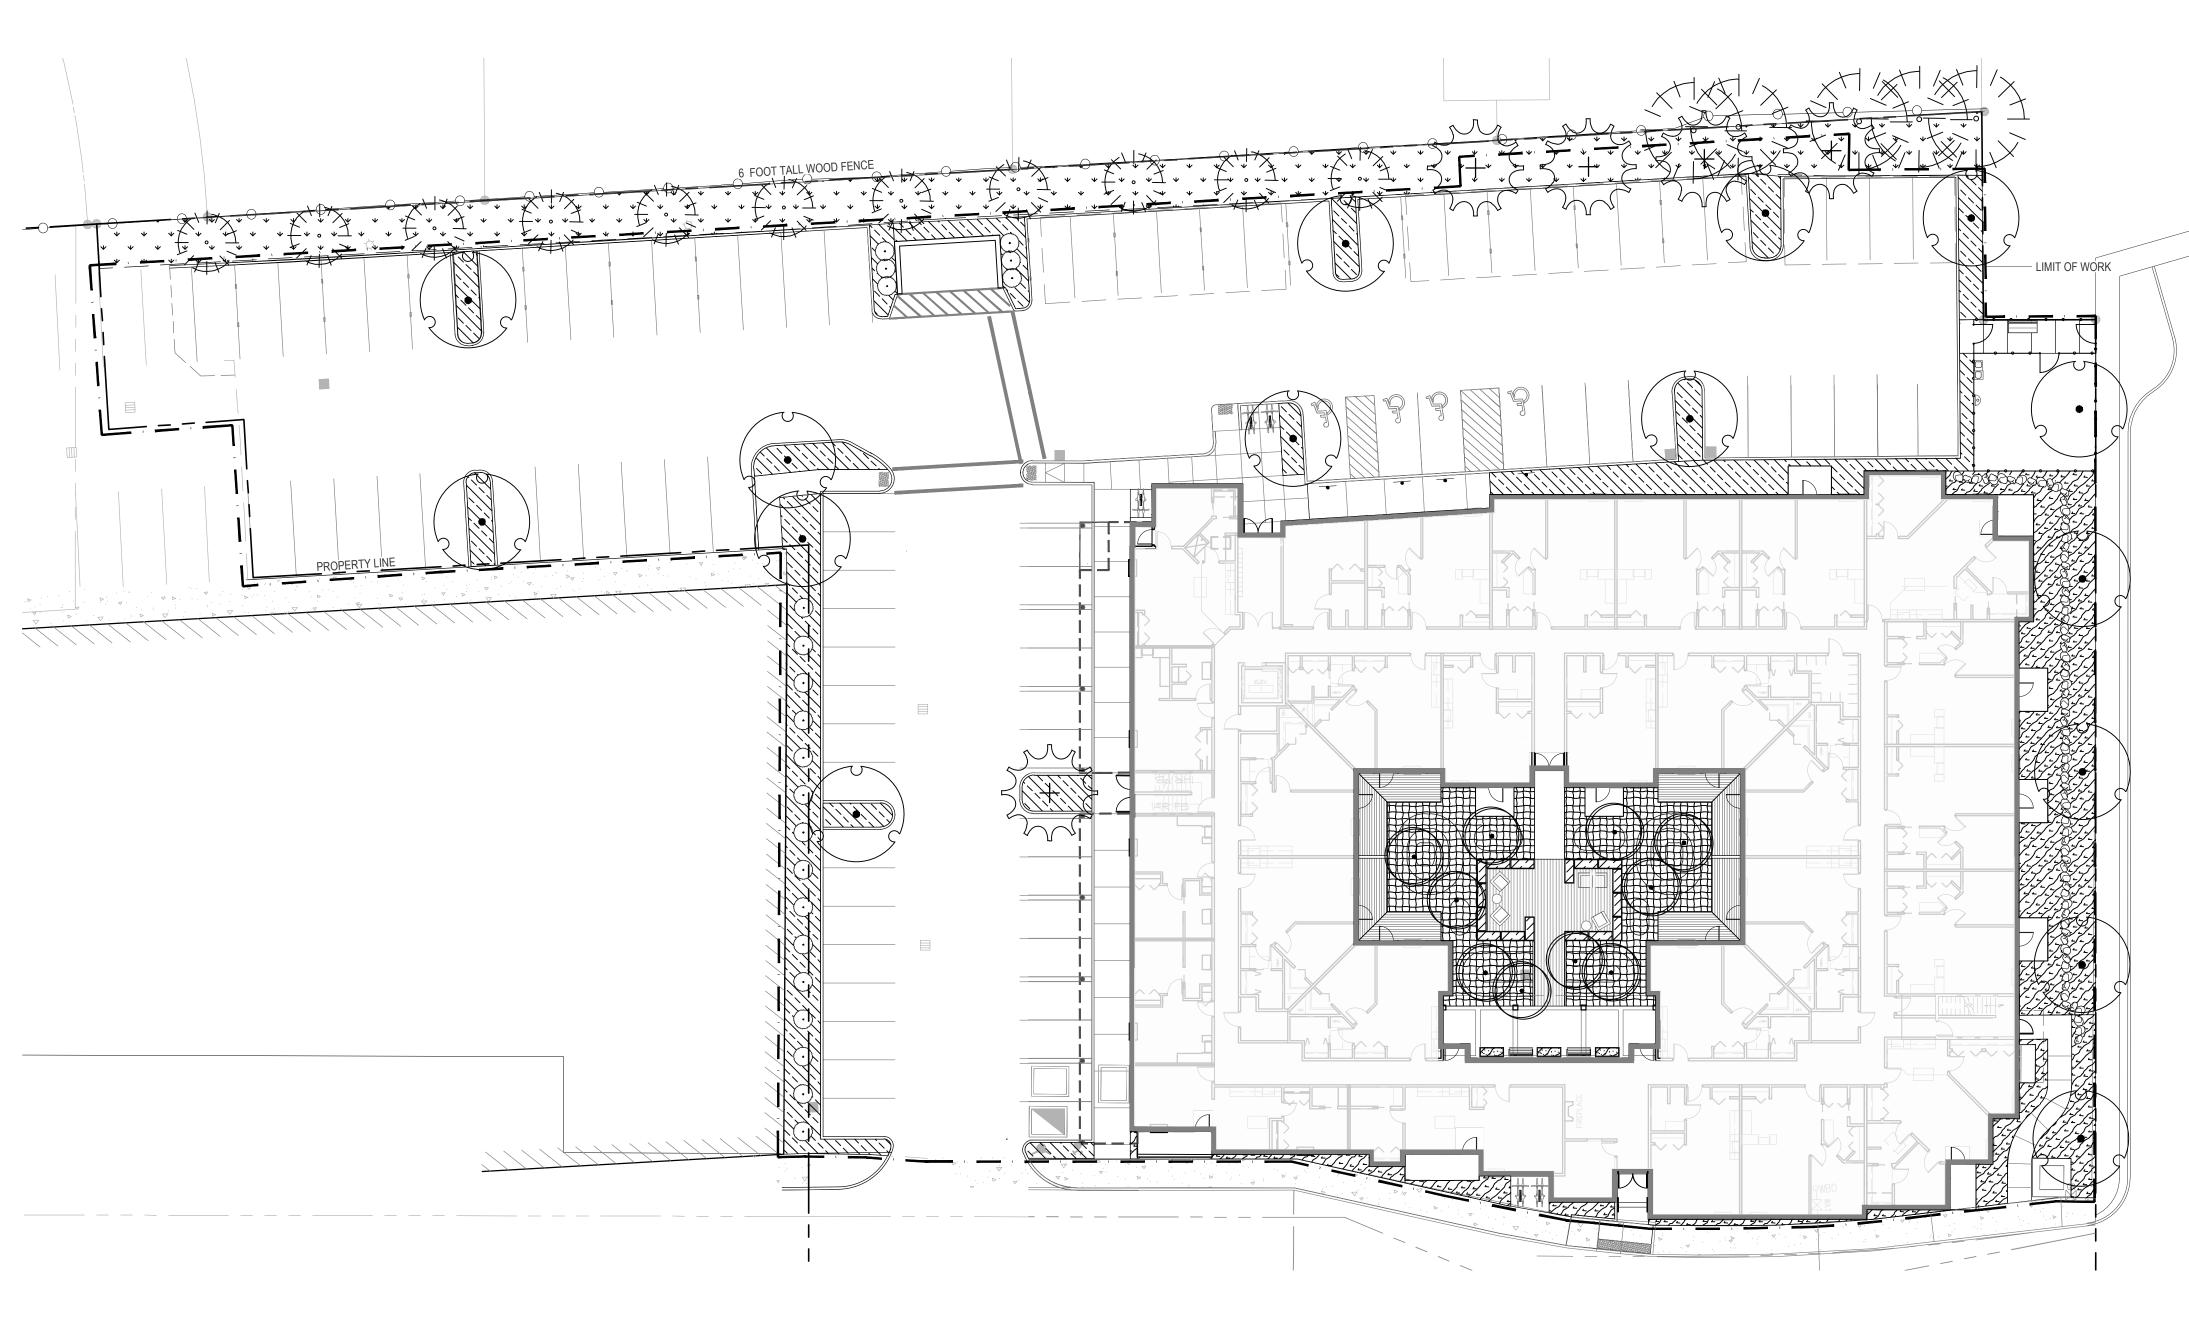

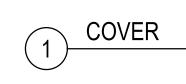

SCALE: 1" = 20'



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CEDAR CREEK APTS.

16864 SW EDY ROAD SHERWOOD, OR 97140

LANDSCAPE SHEET INDEX

Sheet Number	Sheet Title
L0.00	COVER
L1.00	EXISTING TREE AND VEGETATION PROTECTION PLAN
L2.00	MATERIALS PLANS - GROUND LEVEL
L2.01	MATERIALS AND PLANTING PLAN - LEVEL 3
L3.00	PLANTING PLAN - GROUND LEVEL

DRAWING LOG

6/18/2021 LAND USE REVIEW SET

КЕҮ МАР


DRAWING PHASE

DESIGN DEVELOPMENT SHEET TITLE COVER

SHEET NO.

L0.00 JUNE 18, 2021



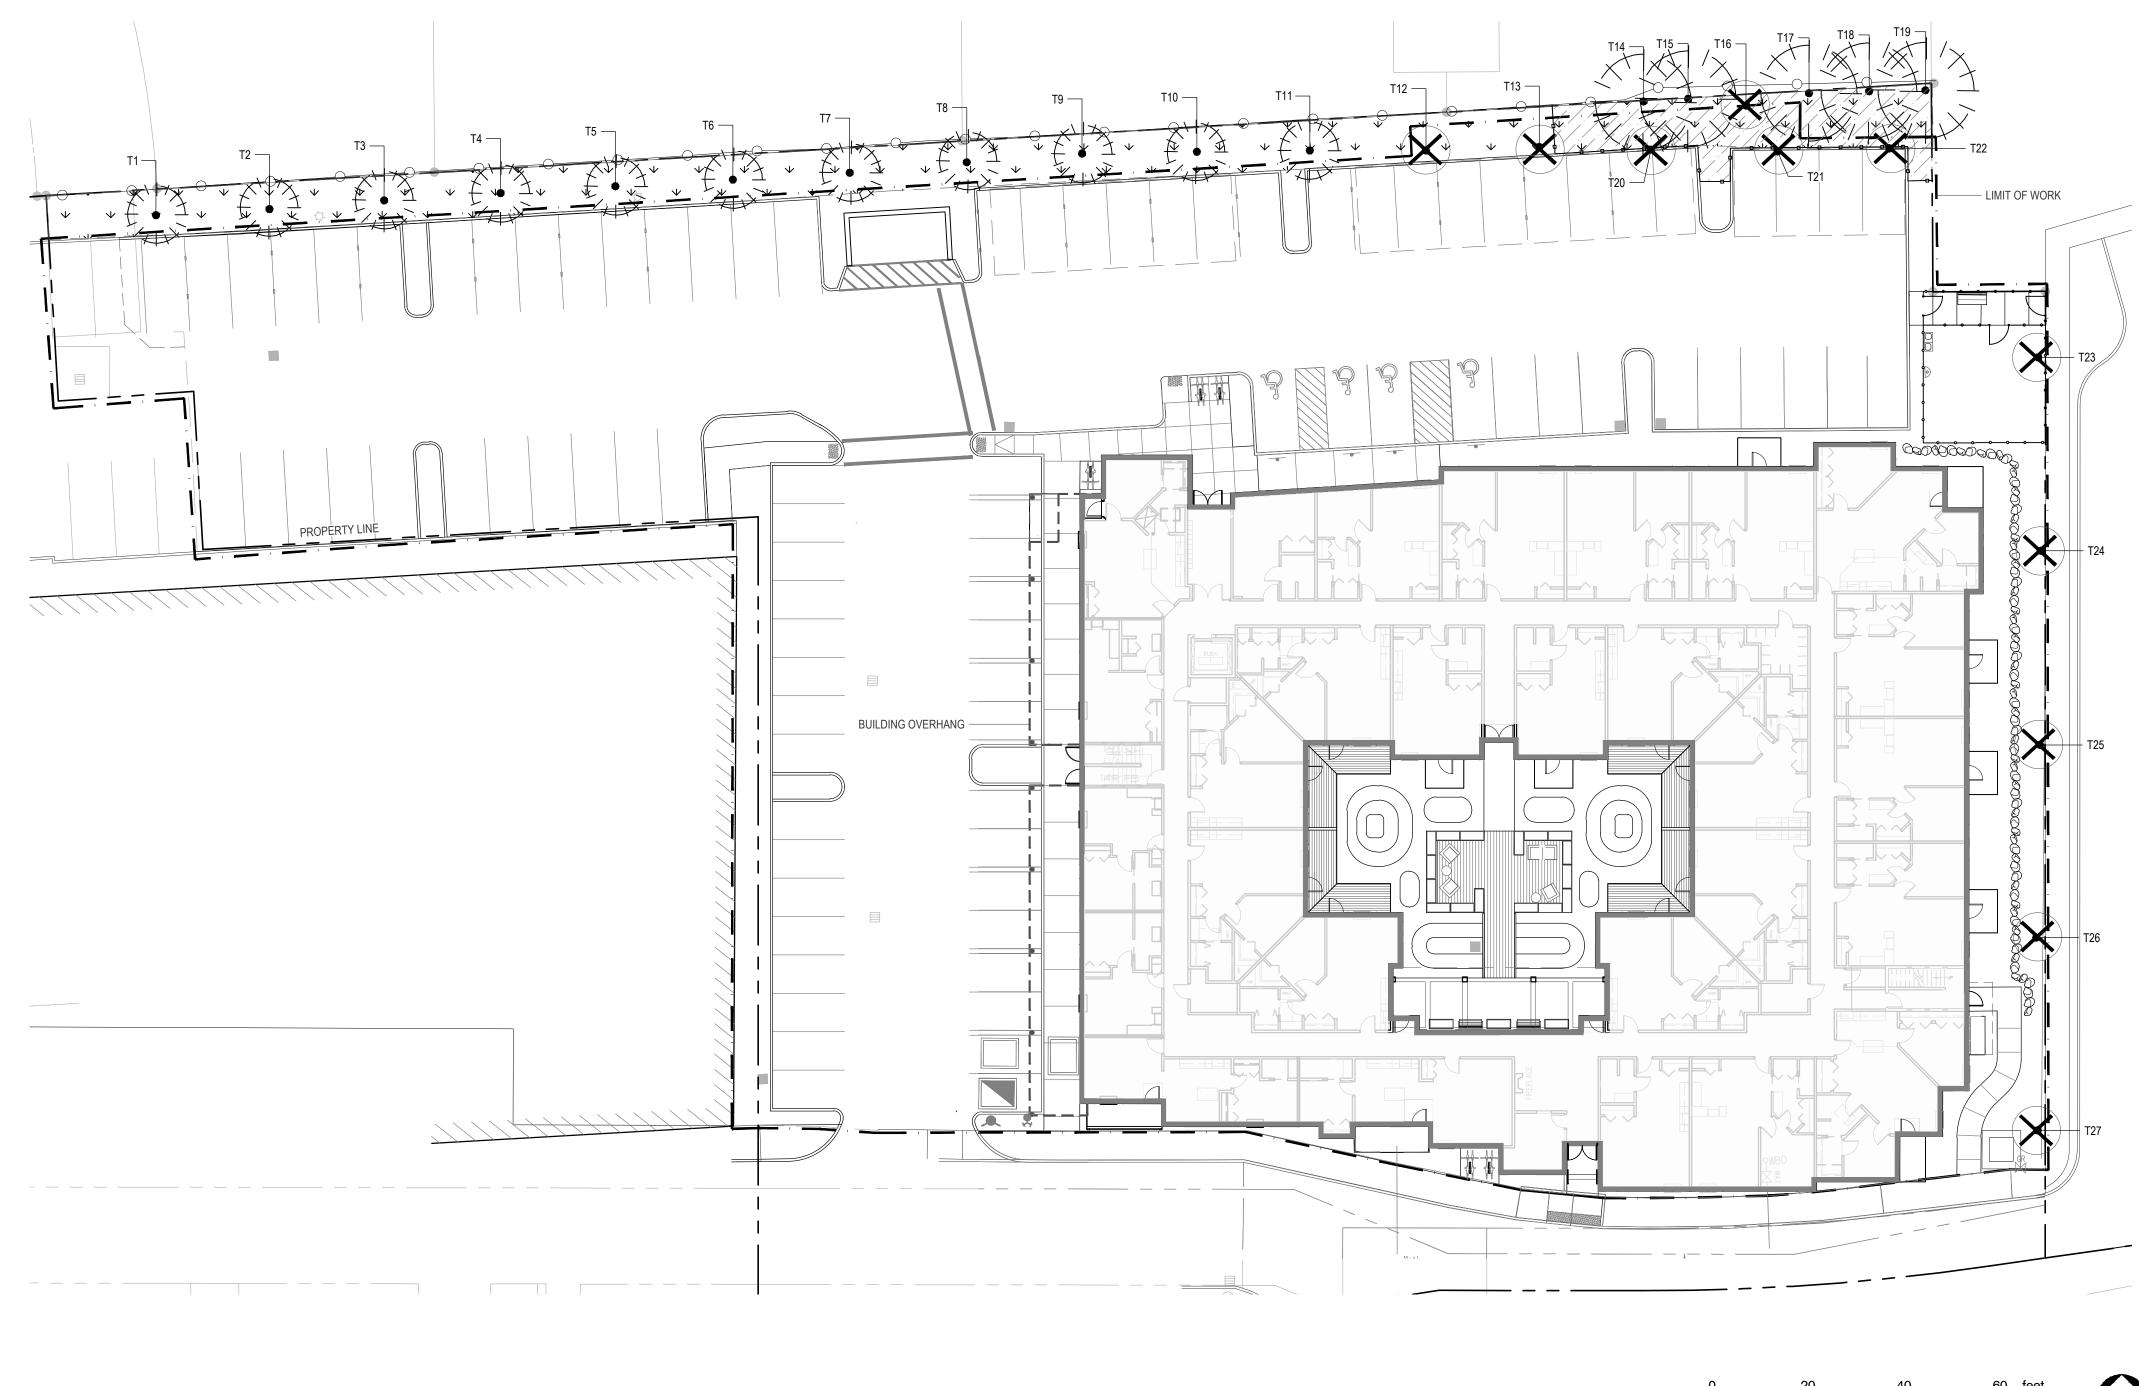

EXISTING TREE & VEGETATION PROTECTION PLAN

		TREE PRESERVATION LEGEN	-					
	EXISTING TREES TO BE PROTECTED/REMOVED							
TREE NUMBER	TYPE	SPECIES	<u>DBH (IN.)</u>	PROTECT	REMOVE			
T1	EV/CONIFER	Incense Cedar (Calocedus decurrens)	3	Х				
T2	EV/CONIFER	Incense Cedar (Calocedus decurrens)	3	Х				
Т3	EV/CONIFER	Incense Cedar (Calocedus decurrens)	3	Х				
T4	EV/CONIFER	Incense Cedar (Calocedus decurrens)	3	Х				
T5	EV/CONIFER	Incense Cedar (Calocedus decurrens)	3	Х				
T6	EV/CONIFER	Incense Cedar (Calocedus decurrens)	3	Х				
T7	EV/CONIFER	Incense Cedar (Calocedus decurrens)	3	Х				
Т8	EV/CONIFER	Incense Cedar (Calocedus decurrens)	3	Х				
Т9	EV/CONIFER	Incense Cedar (Calocedus decurrens)	3	Х				
T10	EV/CONIFER	Incense Cedar (Calocedus decurrens)	3	Х				
T11	EV/CONIFER	Incense Cedar (Calocedus decurrens)	3	Х				
T12	EV/CONIFER	Incense Cedar (Calocedus decurrens)	3		Х			
T13	EV/CONIFER	Incense Cedar (Calocedus decurrens)	3		Х			
T14	EV/CONIFER	Douglas Fir (Pseudotsuga menziesii)	9	Х				
T15	EV/CONIFER	Douglas Fir (Pseudotsuga menziesii)	17	Х				
T16	EV/CONIFER	Douglas Fir (Pseudotsuga menziesii)	38		X*			
T17	EV/CONIFER	Douglas Fir (Pseudotsuga menziesii)	19	Х				
T18	EV/CONIFER	Douglas Fir (Pseudotsuga menziesii)	20	Х				
T19	EV/CONIFER	Douglas Fir (Pseudotsuga menziesii)	23	Х				
T20	EV/CONIFER	Incense Cedar (Calocedus decurrens)	3		Х			
T21	EV/CONIFER	Incense Cedar (Calocedus decurrens)	3		Х			
T22	EV/CONIFER	Incense Cedar (Calocedus decurrens)	3		Х			
T23	DECIDUOUS	Marshall's Ash (Fraxinus pennsylvanica 'Marshall')	3		х			
T24	DECIDUOUS	Marshall's Ash (Fraxinus pennsylvanica 'Marshall')	3		х			
T25	DECIDUOUS	Marshall's Ash (Fraxinus pennsylvanica 'Marshall')	3		х			
T26	DECIDUOUS	Marshall's Ash (Fraxinus pennsylvanica 'Marshall')	3		х			
T27	DECIDUOUS	Marshall's Ash (Fraxinus pennsylvanica 'Marshall')	3		х			

* NOTE: TREE PREVIOUSLY APPROVED FOR REMOVAL UNDER SP 16-10.

0 20 40 60 feet SCALE: 1" = 20'



TREE AND VEGETATION LEGEND



TREE TO BE REMOVED



BE



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PROJECT

CEDAR CREEK APTS.

16864 SW EDY ROAD SHERWOOD, OR 97140

SITE VEGETATION NOTES

SEE CIVIL FOR SOIL PROTECTION AND LIMIT OF GRADING. A. ALL LANDSCAPE AREAS TO BE REPAIRED AS NEEDED DUE TO CONSTRUCTION ACTIVITIES.

- INCLUDING BUT NOT LIMITED TO:
 SOIL COMPACTION FROM EQUIPMENT TRAFFIC OR MATERIAL STORAGE
- REPAIR NECESSARY TO FEATHER IN NEW FINISHED GRADE WITH EXISTING GRADE. GRADE CHANGES OVER 3" WITHIN THE CRITICAL ROOT ZONE OF PROTECTED TREES REQUIRE THE ADVICE OF THE PROJECT ARBORIST.
- LIMIT OF WORK BOUNDARY AND/OR ROOT PROTECTION FENCING REMOVAL OR INSTALLATION
 GRUBBING AND REMOVAL OF PLANTS
- INSTALLATION OR RE-VAMP WORK REQUIRED TO COMPLETE SITE WIDE IRRIGATION SYSTEM EXPANSION
 TEMPORARY IRRIGATION TO BE PROVIDED AT ALL AREAS WHERE EXISTING LANDSCAPING IS REPLACED DUE TO CONSTRUCTION ACTIVITIES. THIS IRRIGATION SHALL BE MAINTAINED UNTIL PLANTINGS ARE FULLY ESTABLISHED. ALL TEMPORARY SURFACE IRRIGATION SYSTEMS SHALL BE REMOVED BY CONTRACTOR AFTER LANDSCAPING HAS BEEN ESTABLISHED AND CAN SURVIVE WITHOUT IRRIGATION

TREE PROTECTION NOTES

- A. PROTECT ALL TREES INDICATED TO REMAIN, INCLUDING BARK AND ROOT ZONES.
- INSTALL FENCING PER EXISTING TREE INVENTORY & PROPOSED TREE PLAN.
- C. TREE PROTECTION FENCING FOR ADJACENT TREES WITHIN OUR PROJECT SITE IS REPRESENTED DIAGRAMMATICALLY FOR GRAPHIC CLARITY. ACTUAL LAYOUT SHALL FOLLOW THE ROOT PROTECTION ZONE PER SPEC SECTION 01 56 39
 D. EXCAVATION WITHIN THE TREE PROTECTION ZONE SHALL BE PERFORMED WITH HANDHELD TOOLS OR
- AIR SPADE. EXCAVATE THE MINIMUM AMOUNT NECESSARY TO ACCOMPLISH PURPOSE FOR EXCAVATION. ROOTS OVER 4" DIAMETER SHALL BE CUT BY PROJECT ARBORIST.
- THE FOLLOWING IS PROHIBITED WITHIN THE ROOT PROTECTION ZONE OF EACH TREE OR OUTSIDE THE LIMITS OF THE DEVELOPMENT IMPACT AREA:
 GROUND DISTURBANCE OR CONSTRUCTION ACTIVITY INCLUDING VEHICLE OR EQUIPMENT ACCESS
- (BUT EXCLUDING ACCESS ON EXISTING STREETS OR DRIVEWAYS)
 STORAGE OF EQUIPMENT OR MATERIALS INCLUDING SOIL, TEMPORARY OR PERMANENT STOCKPILING, PROPOSED BUILDINGS, IMPERVIOUS SURFACES, UNDERGROUND UTILITIES,
- EXCAVATION OR FILL, TRENCHING OR OTHER WORK ACTIVITIES.
 E. PROTECTIVE FENCE SHALL BE INSTALLED BEFORE ANY GROUND DISTURBING ACTIVITIES INCLUDING, BUT NOT LIMITED TO, CLEARING AND GRADING, OR START OF CONSTRUCTION. ALL PROTECTIVE FENCING SHALL REMAIN IN PLACE UNTIL FINAL INSPECTION.
- F. SIGNAGE DESIGNATING THE PROTECTION ZONE AND PENALTIES FOR VIOLATIONS SHALL BE SECURED IN A PROMINENT LOCATION ON EACH PROTECTION FENCE.
- G. TREE PROTECTION ZONE SHALL REMAIN FREE OF ALL CHEMICALLY INJURIOUS MATERIALS AND LIQUIDS.

MAINTENANCE NOTES FOR EXISTING TREES

- A. WASH OFF FOLIAGE WHICH BECOMES SOILED DURING CONSTRUCTION.
 B. WATER TREES AND OTHER VEGETATION WHICH ARE TO REMAIN AS NECESSARY TO MAINTAIN THEIR
- HEALTH DURING THE COURSE OF THE WORK. RATE AND FREQUENCY OF APPLICATION TO BE DETERMINED BY PROJECT ARBORIST.
- C. ALL PRUNING SHALL BE PERFORMED BY A CURRENT ARBORIST LICENSED WITHIN THE STATE/COUNTY/CITY WHERE THE WORK IS TO BE COMPLETED.

EXISTING VEGETATION PROTECTION AND REMOVAL WITHIN PROJECT LIMIT OF WORK

- A. CLEAR AND GRUB ALL INVASIVE VEGETATION. ALL OTHER SHRUBS, TREE SAPLINGS/VOLUNTEERS, AND GROUNDCOVERS WITHIN THE PROJECT LIMIT OF WORK IS TO BE CLEARED AND GRUBBED UNLESS OTHERWISE NOTED IN PLANS. TREES TO BE PROTECTED AND REMOVED AS INDICATED IN THE EXISTING VEGETATION AND TREE INVENTORY PLAN.
- B. SEE CIVIL DEMOLITION PLANS FOR ADDITIONAL INFORMATION.

DRAWING LOG

LAND USE REVIEW SET

6/18/2021

KEY MAP


DRAWING PHASE

DESIGN DEVELOPMENT

SHEET TITLE EXISTING TREE & VEGETATION PROTECTION PLAN SHEET NO.



L1.00

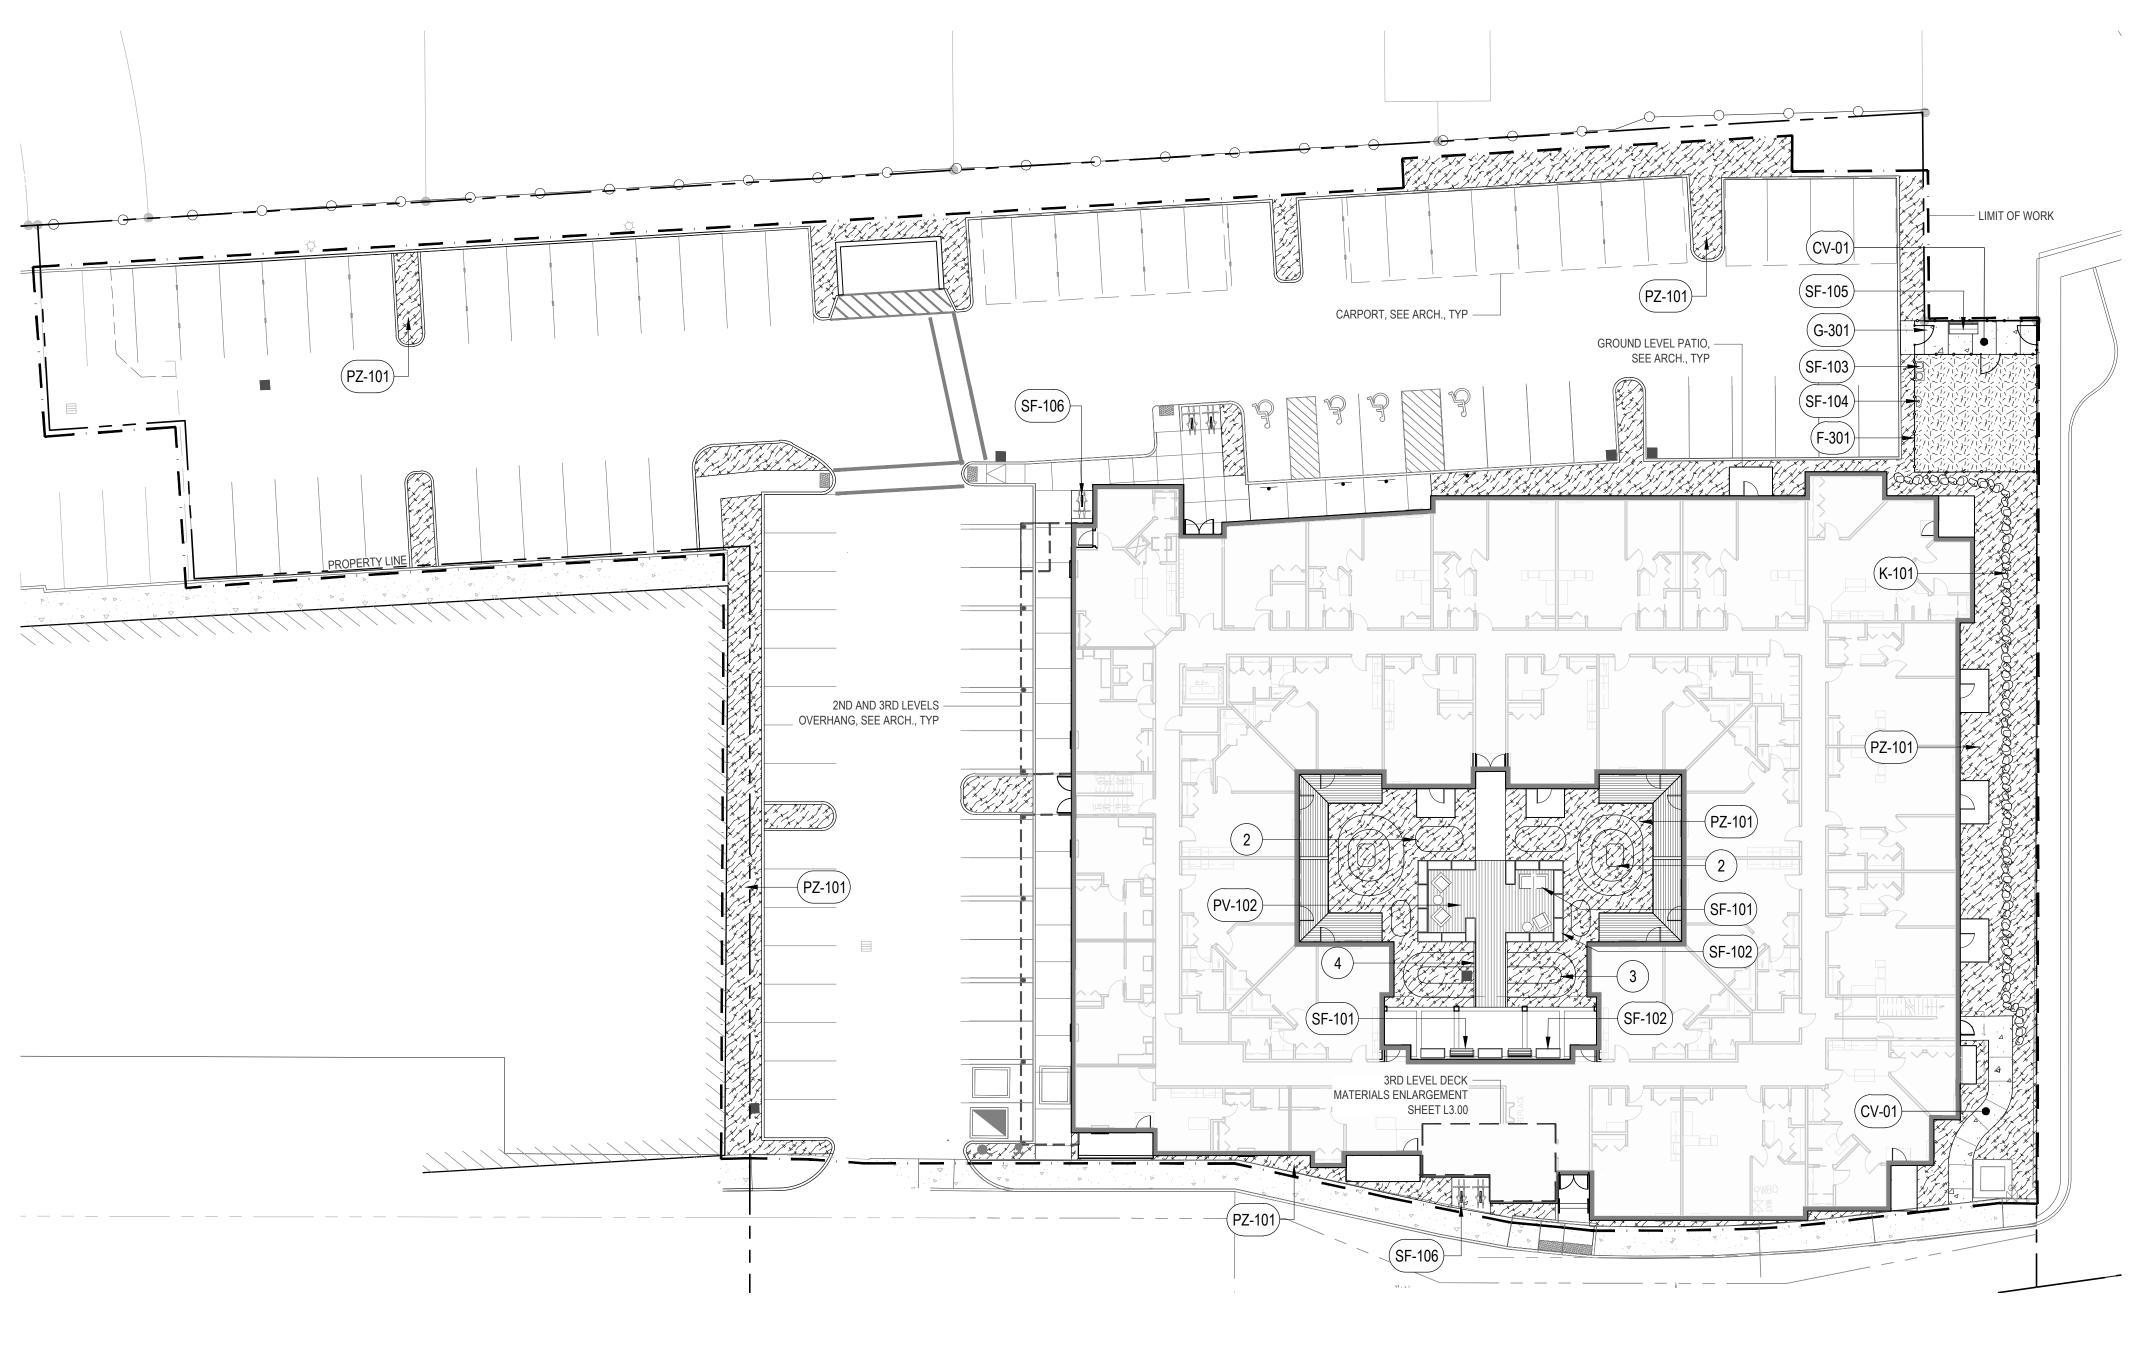

MATERIALS PLAN GROUND LEVEL

SCALE: 1" = 20'



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CEDAR CREEK APTS.

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	REFERENCE	NOTES SCHEDULE MATERIALS
	SYMBOL	DESCRIPTION
	2	GRADED BERM, 1` TO 3` HT, TYP.
	3	GRADED SWALE
	4	WOOD BRIDGE
	SYMBOL	SEE CIVIL DRAWINGS / DETAILS / SPECS DESCRIPTION
	(CV-01)	CONCRETE SURFACING - TYPE I DETAIL PER CIVIL SCORING AND JOINTING: PER LANDSCAPE PLANS FINISH: LIGHT BROOM FINISH
	SYMBOL	METAL DESCRIPTION
	(F-301)	DOG PARK FENCE: 4` HT, METAL, TYP.
	SYMBOL	METAL GATE DESCRIPTION
	G-301	DOG PARK GATE: 48" WIDE X 4` HT. METAL, TYP.
	SYMBOL	ROCK DESCRIPTION
	(K-101)	LANDSCAPE ROCK TYP.
	SYMBOL	PAVING DESCRIPTION
	(PV-101)	PRE-ENGINEERED WOOD FIBER, TYP.
	(PV-102)	WOOD DECKING, TYP.
	SYMBOL	PLANTING ZONES DESCRIPTION
	PZ-101	PLANTING AREA, TYP.
	SYMBOL	SITE FURNISHINGS DESCRIPTION
	(SF-101)	LOUNGE FURNITURE, OFCI, TYP.
	SF-102	PLANTER - TYPE I, 60 L X24 W X36 H TYP.
	SF-103	DOG WATER STATION
$\overline{\mathbf{O}}$	(SF-104)	PET WASTE STATION
	SF-105	BENCH TYPE 1, TYP.
I	SF-106	BIKE RACK, TYP.

DRAWING LOG

6/18/2021

LAND USE REVIEW SET


KEY MAP

DRAWING PHASE


DESIGN DEVELOPMENT SHEET TITLE MATERIALS PLAN **GROUND LEVEL**

SHEET NO.



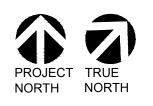

ROOF DECK MATERIALS AND PLANTING PLAN 1

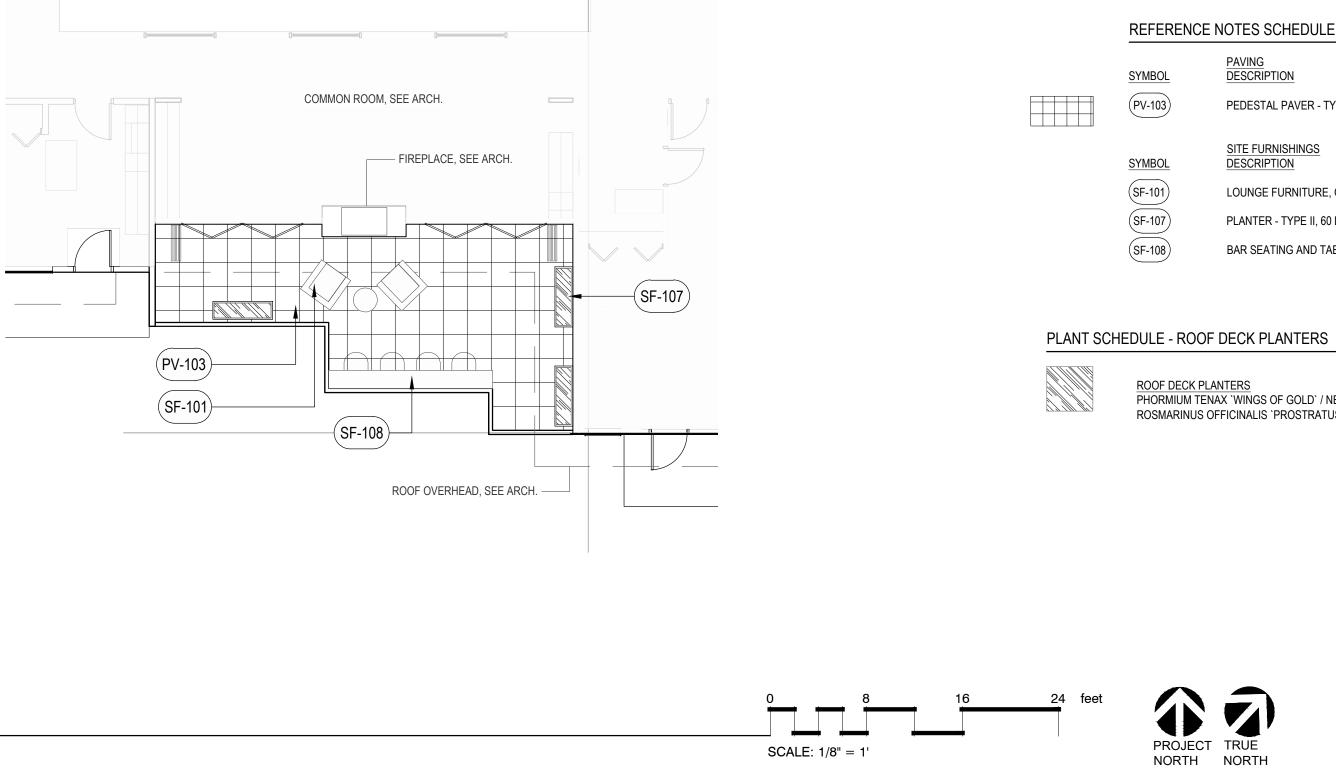

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DRAWING LOG

LAND USE REVIEW SET

6/18/2021

REFERENCE NOTES SCHEDULE ROOF DECK

PAVING DESCRIPTION DETAIL PEDESTAL PAVER - TYPE 1 - ARCH. SLAB, TYP. SITE FURNISHINGS DESCRIPTION DETAIL LOUNGE FURNITURE, OFCI, TYP. PLANTER - TYPE II, 60 L X 18 W X 24 H, TYP. BAR SEATING AND TABLE, OFCI.

<u>ROOF DECK PLANTERS</u> PHORMIUM TENAX `WINGS OF GOLD` / NEW ZEALAND FLAX 1 GAL 50% @ 20" oc ROSMARINUS OFFICINALIS `PROSTRATUS` / DWARF ROSEMARY 1 GAL 50% @ 20" oc

KEY MAP

DRAWING PHASE


DESIGN DEVELOPMENT

SHEET TITLE MATERIALS AND PLANTING PLAN LEVEL 3

SHEET NO.

L2.01 JUNE 18, 2021 CODE REQUIREMENTS RETAIN COMMERCIAL ZONING

	CODE STANDARD	REQUIRED	PROVIDED	REQUIREMENT MET
PERIMETER SCREENING AND BUFFERING SEPARATING RESIDENTIAL ZONES (16.92.030.A)	A MINIMUM SIX (6) FOOT HIGH SIGHT-OBSCURING FENCE, DECORATIVE MASONRY WALL, OR EVERGREEN SCREEN, SHALL BE REQUIRED ALONG PROPERTY LINES. A MINIMUM TEN (10) FOOT WIDE LANDSCAPE STRIP COMPRISED OF TREES, SHRUBS AND GROUNDCOVERS BETWEEN OFF-STREET PARKING, LOADING, OR VEHICULAR USE AREAS ON SEPARATE, ABUTTING OR ADJACENT PROPERTIES.	367 LINEAR FEET OF BUFFER ALONG NORTHWEST PERIMETER ABUTTING HDR-PUD RESIDENTIAL ZONE.	367 LINEAR FEET OF BUFFER X 10' WIDE.	YES
PARKING AREA LANDSCAPING (16.92.030.B)	TREES: 1 LG TREE PER 4 PARKING SPACES, 1 MED TREE PER 3 PARKING SPACES OR 1 SM TREE PER 2 PARKING SPACES OR 1 SM MUST BE EVERGREEN. AT LEAST 1 TREE PER INDIVIDUAL LANDSCAPED ISLAND. MINIMUM CALIPER OF TWO (2) INCHES, HEIGHT OF 6' AT TIME OF PLANTING. AT LEAST FORTY-FIVE (45) SQ FT OF PARKING AREA LANDSCAPING FOR EACH PARKING SPACE LOCATED ON THE SITE. MINIMUM OF 90 SQ FT OF LANDSCAPING PER INDIVIDUAL LANDSCAPE ISLAND. SHRUBS: 2 SHRUBS PER EACH PARKING SPACE (EVERGREEN OR DECIDUOUS). MINIMUM 1-GAL. GROUNDCOVER: REMAINING AREA MUST BE GROUNDCOVER TO COMPLETELY COVER WITHIN 3 YEARS, MINIMUM 4" POT.	90 PARKING SPACES = 4,050 SQ FT. OF PARKING AREA LANDSCAPE. TREES REQUIRED: 23 LG TREES OR 30 MED TREES OR 45 SM TREES. SHRUBS REQUIRED: 180 SHRUBS.	PARKING AREA LANDSCAPING PROVIDED: 6,861 SQ FT. TREES PROVIDED: 16 MEDIUM TREES PROVIDED, 15 LARGE TREES. SHRUBS PROVIDED: 265 MINIMUM IN 1-GAL TO 15- GAL. REMAINING AREA TO BE PLANTED WITH GROUNDCOVER IN MINIMUM 4" POTS.	YES

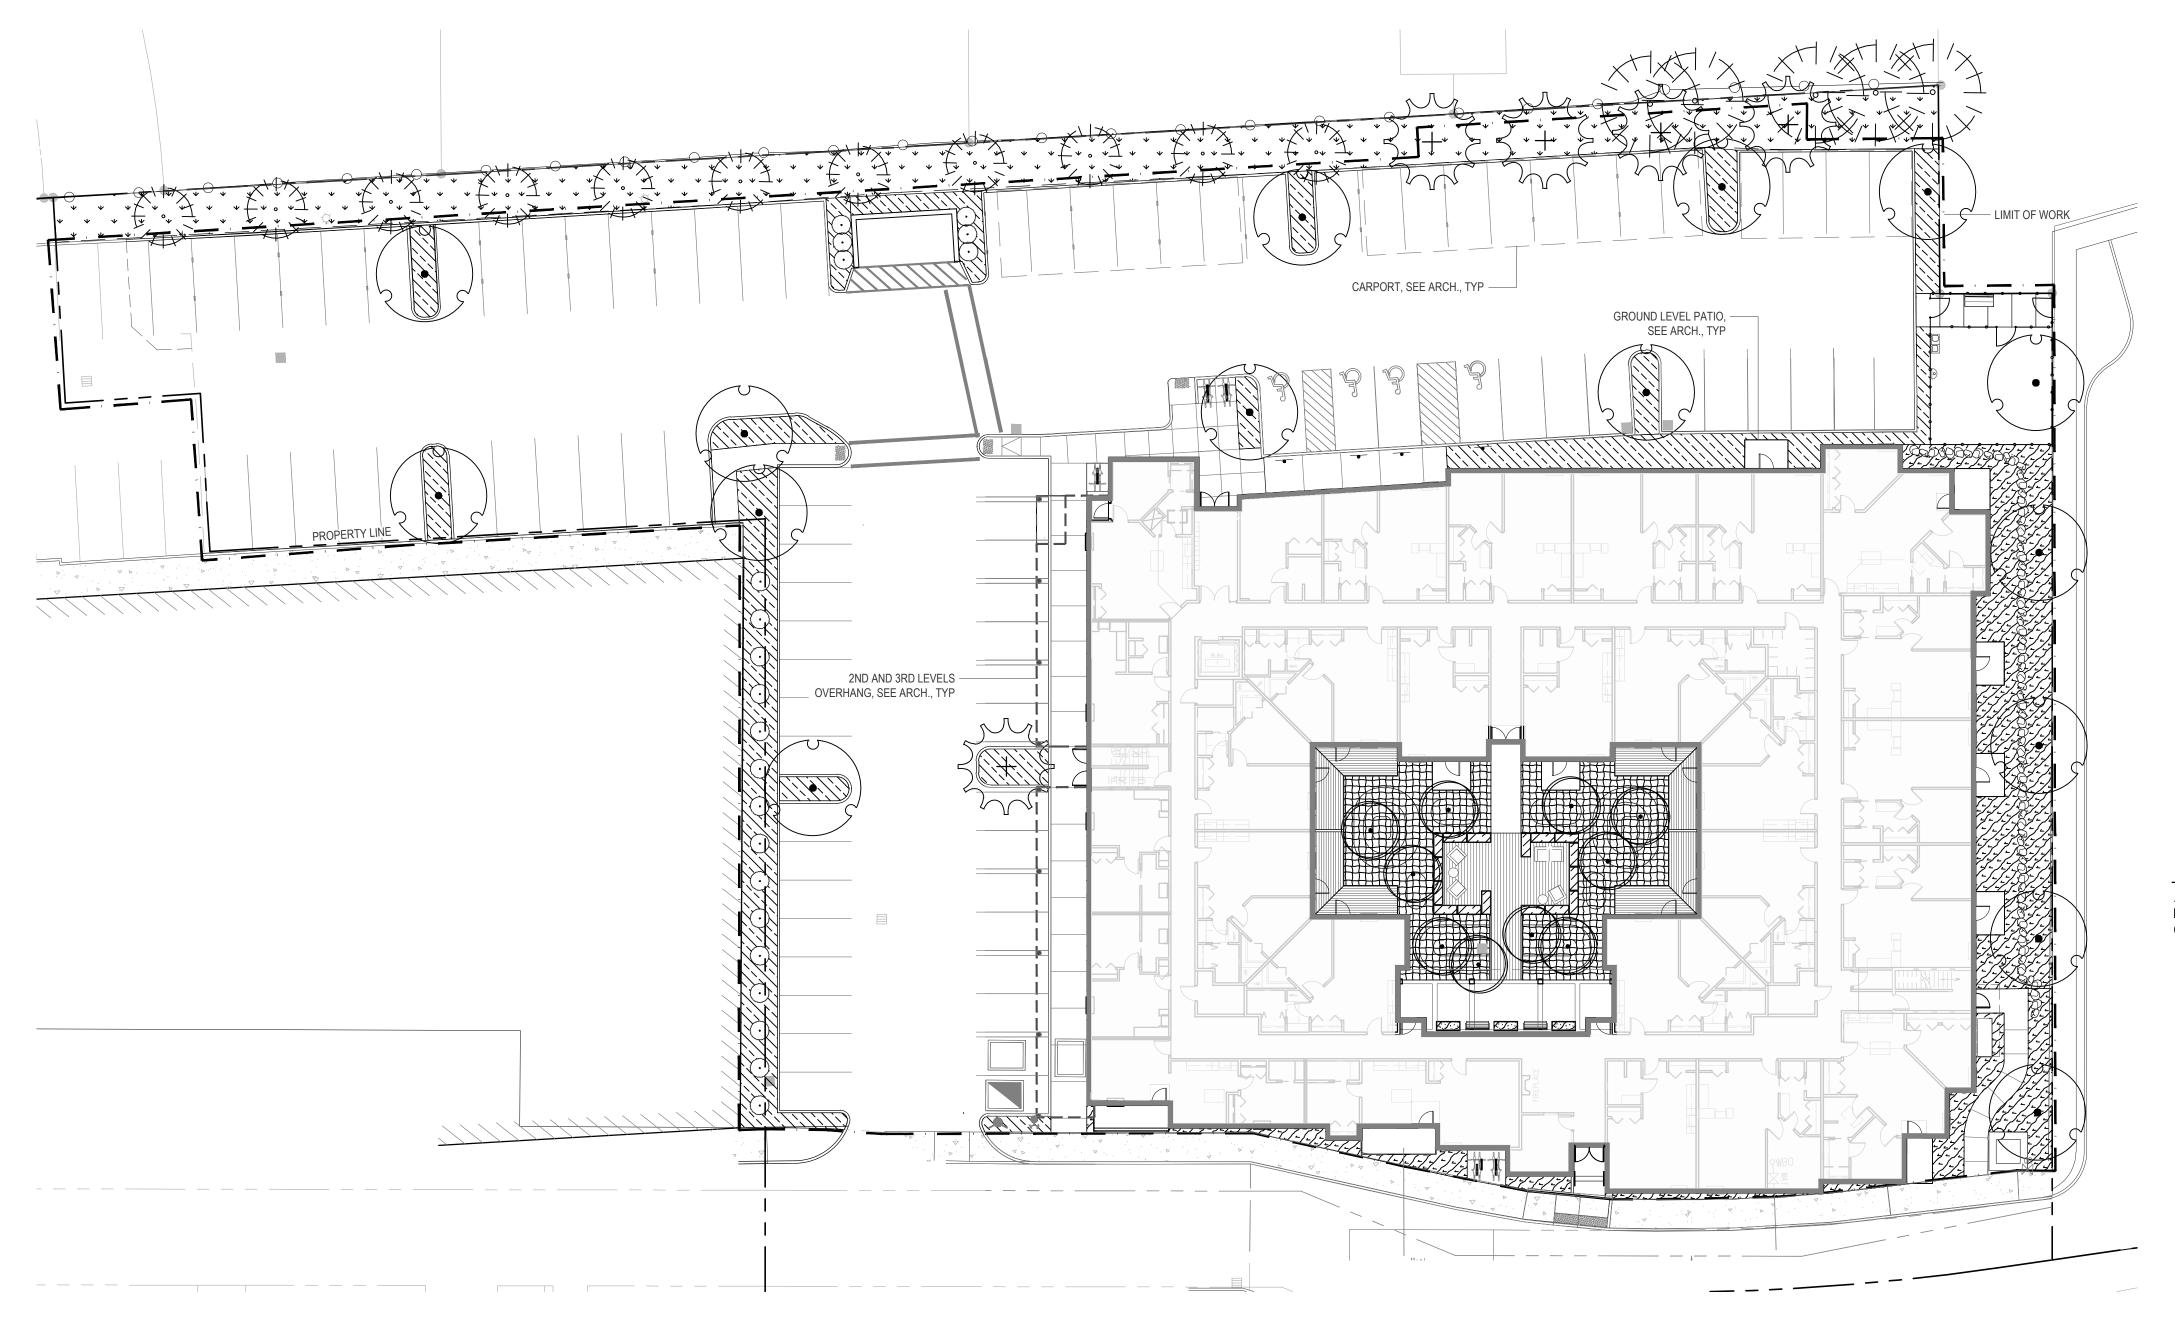

	CODE STANDARD	REQUIRED	PROVIDED	REQUIREMEN MET
SCREENING OF MECHANICAL EQUIPMENT, OUTDOOR STORAGE, SERVICE AND DELIVERY AREAS (16.92.030.C)	SCREENED FROM VIEW FROM ALL PUBLIC STREETS AND ANY ADJACENT RESIDENTIAL ZONES. IF UNFEASIBLE TO FULLY SCREEN DUE TO POLICIES AND STANDARDS, APPLICANT SHALL MAKE EFFORTS TO MINIMIZE THE VISUAL IMPACT OF THE MECHANICAL EQUIPMENT.	TRASH BIN ENCLOSURE NEXT TO PERIMETER BUFFER SEPARATING SITE FROM HDR-PUD ZONE	5-GAL AND 1-GAL PLANTS PROVIDED TO MINIMIZE VISUAL IMPACT OF ENCLOSURE.	YES
IRRIGATION (16.92.040.C)	ALL LANDSCAPE AREAS MUST PROVIDE AN IRRIGATION SYSTEM: OPTION 1 - PERMANENT BUILT-IN SYSTEM WITH AUTOMATIC CONTROLLER; OPTION 2 - AN IRRIGATION SYSTEM DESIGNED BY A LICENSED LANDSCAPE ARCHITECT OR OTHER QUALIFIED PROFESSIONAL; OPTON 3 - IRRIGATION BY HAND WITH AN INSPECTION REQUIRED ONE (1) YEAR AFTER FINAL INSPECTION TO ENSURE LANDSCAPE ESTABLISHMENT.	IRRIGATION FOR TREES, SHRUBS AND GROUNDCOVERS.	OPTION 2 PROVIDED.	YES

	CODE STANDARD	PROVIDED
TREE CANOPY CALCULATIONS (16.92.030.B)	CANOPY FACTOR=MATURE HT(FT) x CANOPY SPREAD(FT) x GROWTH RATE FACTOR x 0.01. TREE GROWTH INFO: SUGGESTED PLANT	FRAXINUS PENNSYLVANICA 'MARSHALL' (LARGE TREE): CANOPY FACTOR = 75' (MATURE HEIGHT) X 100' (CANOPY SPREAD) X 2 (GROWTH RATE) X .01 = 150 EXISTING PSEUDOSTUGA MENZIESII (LARGE TREE): CANOPY FACTOR = 240' (MATURE HEIGHT) X 60' (CANOPY SPREAD) X 2 (GROWTH RATE) X .01= 288
	LISTS FOR REQUIRED LANDSCAPING	EXISTING AND NEW CALOCEDRUS DECURRENS (MEDIUM TREE): CANOPY FACTOR = 100' (MATURE HEIGHT) X 30' (CANOPY SPREAD) X 2 (GROWTH RATE) X .01= 60



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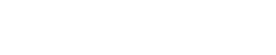
TREE AND VEGETATION LEGEND

KT FX	STING EVERGREEN				PROFESSIONAL LICENSE
	EE TO REMAIN				BLAIR L. DIDWAY
CONCEPT PL	ANT SCHEDULE SITE PLANTING				BLAIR L. DIDWAY E OREGON 4.APR.2019
, rr	MEDIUM SIZE EVERGREEN TREE 8`-10` HT. MIN B& B	5			APE ARCS
z' + z'	CALOCEDRUS DECURRENS / INCENSE CEDAR		B & B		PROJECT
and a	LARGE SIZE DECIDUOUS TREE	15			
•)	2" CAL. B&B FRAXINUS PENNSYLVANICA `MARSHALL`S SEEDLESS` / MARSHALL`S SEEDLESS GREEN ASH		B & B		CEDAR CREEK
	COURTYARD TREE	10			APTS.
\bigcirc	POPULUS TREMULOIDES / QUAKING ASPEN		B & B		16864 SW EDY ROAD SHERWOOD, OR
\odot	<u>COLUMNAR SHRUBS</u> TAXUS BACCATA 'FASTIGIATA' / IRISH YEW	21	15 GAL		97140
	EXISTING PERIMETER PLANTS SEPARATING RESIDENTIAL ZONES SHRUBS OF SUFFICIENT SIZE AND NUMBER, 1-GAL MINIMUM AT PLANTING, TO BE AT FULL GROWTH WITHIN 3 YEARS.	3,908 SF			
	GROUNDCOVERS TO COVER REMAINING AREA NOT PLANTED WITH TREES AND SHRUBS, MINIMUM 4" POT AT PLANTING, SPACED TO GROW TO 100% COVERAGE WITHIN 3 YEARS. ARCTOSTAPHYLOS UVA-URSI / KINNIKINNICK BERBERIS THUNBERGII `LIME GLOW` / LIME GLOW JAPANESE BARBERRY BERBERIS THUNBERGII `ROYAL CLOAK` / ROYAL CLOAK JAPANESE BARBERRY ILEX GLABRA `SHAMROCK` / SHAMROCK INKBERRY HOLLY	402 85 71 46	1 GAL 5 GAL 5 GAL 5 GAL	20% @ 18" oc 30% @ 48" oc 25% @ 48" oc 25% @ 60" oc	
				-	DRAWING LOG
	PARKING AREA LANDSCAPE 45 SF OF LANDSCAPED AREA MINIMUM FOR EACH PARKING SPACE. AT LEAST 1 TREE PER INDIVIDUAL LANDSCAPED PARKING ISLAND. SHRUBS: MINIMUM OF TWO SHRUBS PER PARKING SPACE (EVERGREEN OR DECIDUOUS, 1-GAL MINIMUM.	2,953 SF			6/18/2021 LAND USE REVIEW SET
	GROUNDCOVERS TO COVER REMAINING AREA NOT PLANTED WITH TREES AND SHRUBS, MINIMUM 4" POT AT PLANTING, SPACED TO GROW TO 100% COVERAGE WITHIN 3 YEARS. BERBERIS THUNBERGII `GORUZAM` TM / GOLDEN RUBY JAPANESE BARBERRY NANDINA DOMESTICA `GULF STREAM` TM / GULF STREAM HEAVENLY BAMBOO PRUNUS LAUROCERASUS `OTTO LUYKEN` / OTTO LUYKEN ENGLISH LAUREL RUBUS CALYCINOIDES `EMERALD CARPET` / EMERALD CARPET CREEPING BRAMBLE	54 95 95 379	5 GAL 5 GAL 5 GAL 1 GAL	25% @ 48" oc 25% @ 36" oc 25% @ 36" oc 25% @ 18" oc	
	ORNAMENTAL PLANTING CHOISYA X DEWITTEANA 'AZTEC PEARL' / AZTEC PEARL MEXICAN ORANGE LIRIOPE MUSCARI 'BIG BLUE' / BIG BLUE LILYTURF MAHONIA X 'SOFT CARESS' / SOFT CARESS MAHONIA PENNISETUM ALOPECUROIDES 'HAMELN' / HAMELN FOUNTAIN GRASS RHAPHIOLEPIS UMBELLATA 'MINOR' / DWARF YEDDA HAWTHORNE STANDARD	2,092 SF 54 269 121 41 121	5 GAL 1 GAL 1 GAL 1 GAL 5 GAL	20% @ 36" oc 25% @ 18" oc 20% @ 24" oc 15% @ 36" oc 20% @ 24" oc	
	COURTYARD PLANTING CAREX MORROWII 'ICE DANCE' / ICE DANCE JAPANESE SEDGE CAREX OSHIMENSIS 'EVERILLO' TM / EVERCOLOR EVERILLO JAPANESE SEDGE EUONYMUS JAPONICUS 'GREEN SPIRE' / GREEN SPIRE EUONYMUS HELLEBORUS X HYBRIDUS 'JADE TIGER' / JADE TIGER WINTER JEWELS HELLEBORE HOSTA SIEBOLDIANA 'ELEGANS' / ELEGANS PLANTAIN LILY POLYSTICHUM MUNITUM / WESTERN SWORD FERN POLYSTICHUM POLYBLEPHARUM / JAPANESE TASSEL FERN	1,715 SF 75 75 100 89 89 75 133	1 GAL 1 GAL 1 GAL 1 GAL 1 GAL 1 GAL 1 GAL	15% @ 24" oc 15% @ 24" oc 20% @ 24" oc 10% @ 18" oc 10% @ 18" oc 15% @ 24" oc 15% @ 18" oc	
	COURTYARD RAISED PLANTER FARGESIA RUFA / CLUMPING BAMBOO	133 SF 56	1 GAL	20" oc	
	COURTYARD COVERED PATIO RAISED PLANTER	25 SF			
III)	ASPIDISTRA ELATIOR / CAST IRON PLANT	19	1 GAL	15" oc	KEY MAP

PLANTING AREA NOTE

A. ALL PLANTING AREAS TO RECEIVE BARK MULCH, 3" MINIMUM.

B. ALL PLANTING TO BE IRRIGATED BY PERMANENT IRRIGATION SYSTEM WITH AUTOMATIC CONTROLLER. C. PROTECT EXISTING VEGETATION. REPLACE ANY DAMAGED WITH LIKE KIND AND SIZE.




DRAWING PHASE

DESIGN DEVELOPMENT

SHEET TITLE PLANTING PLAN GROUND LEVEL



SHEET NO.

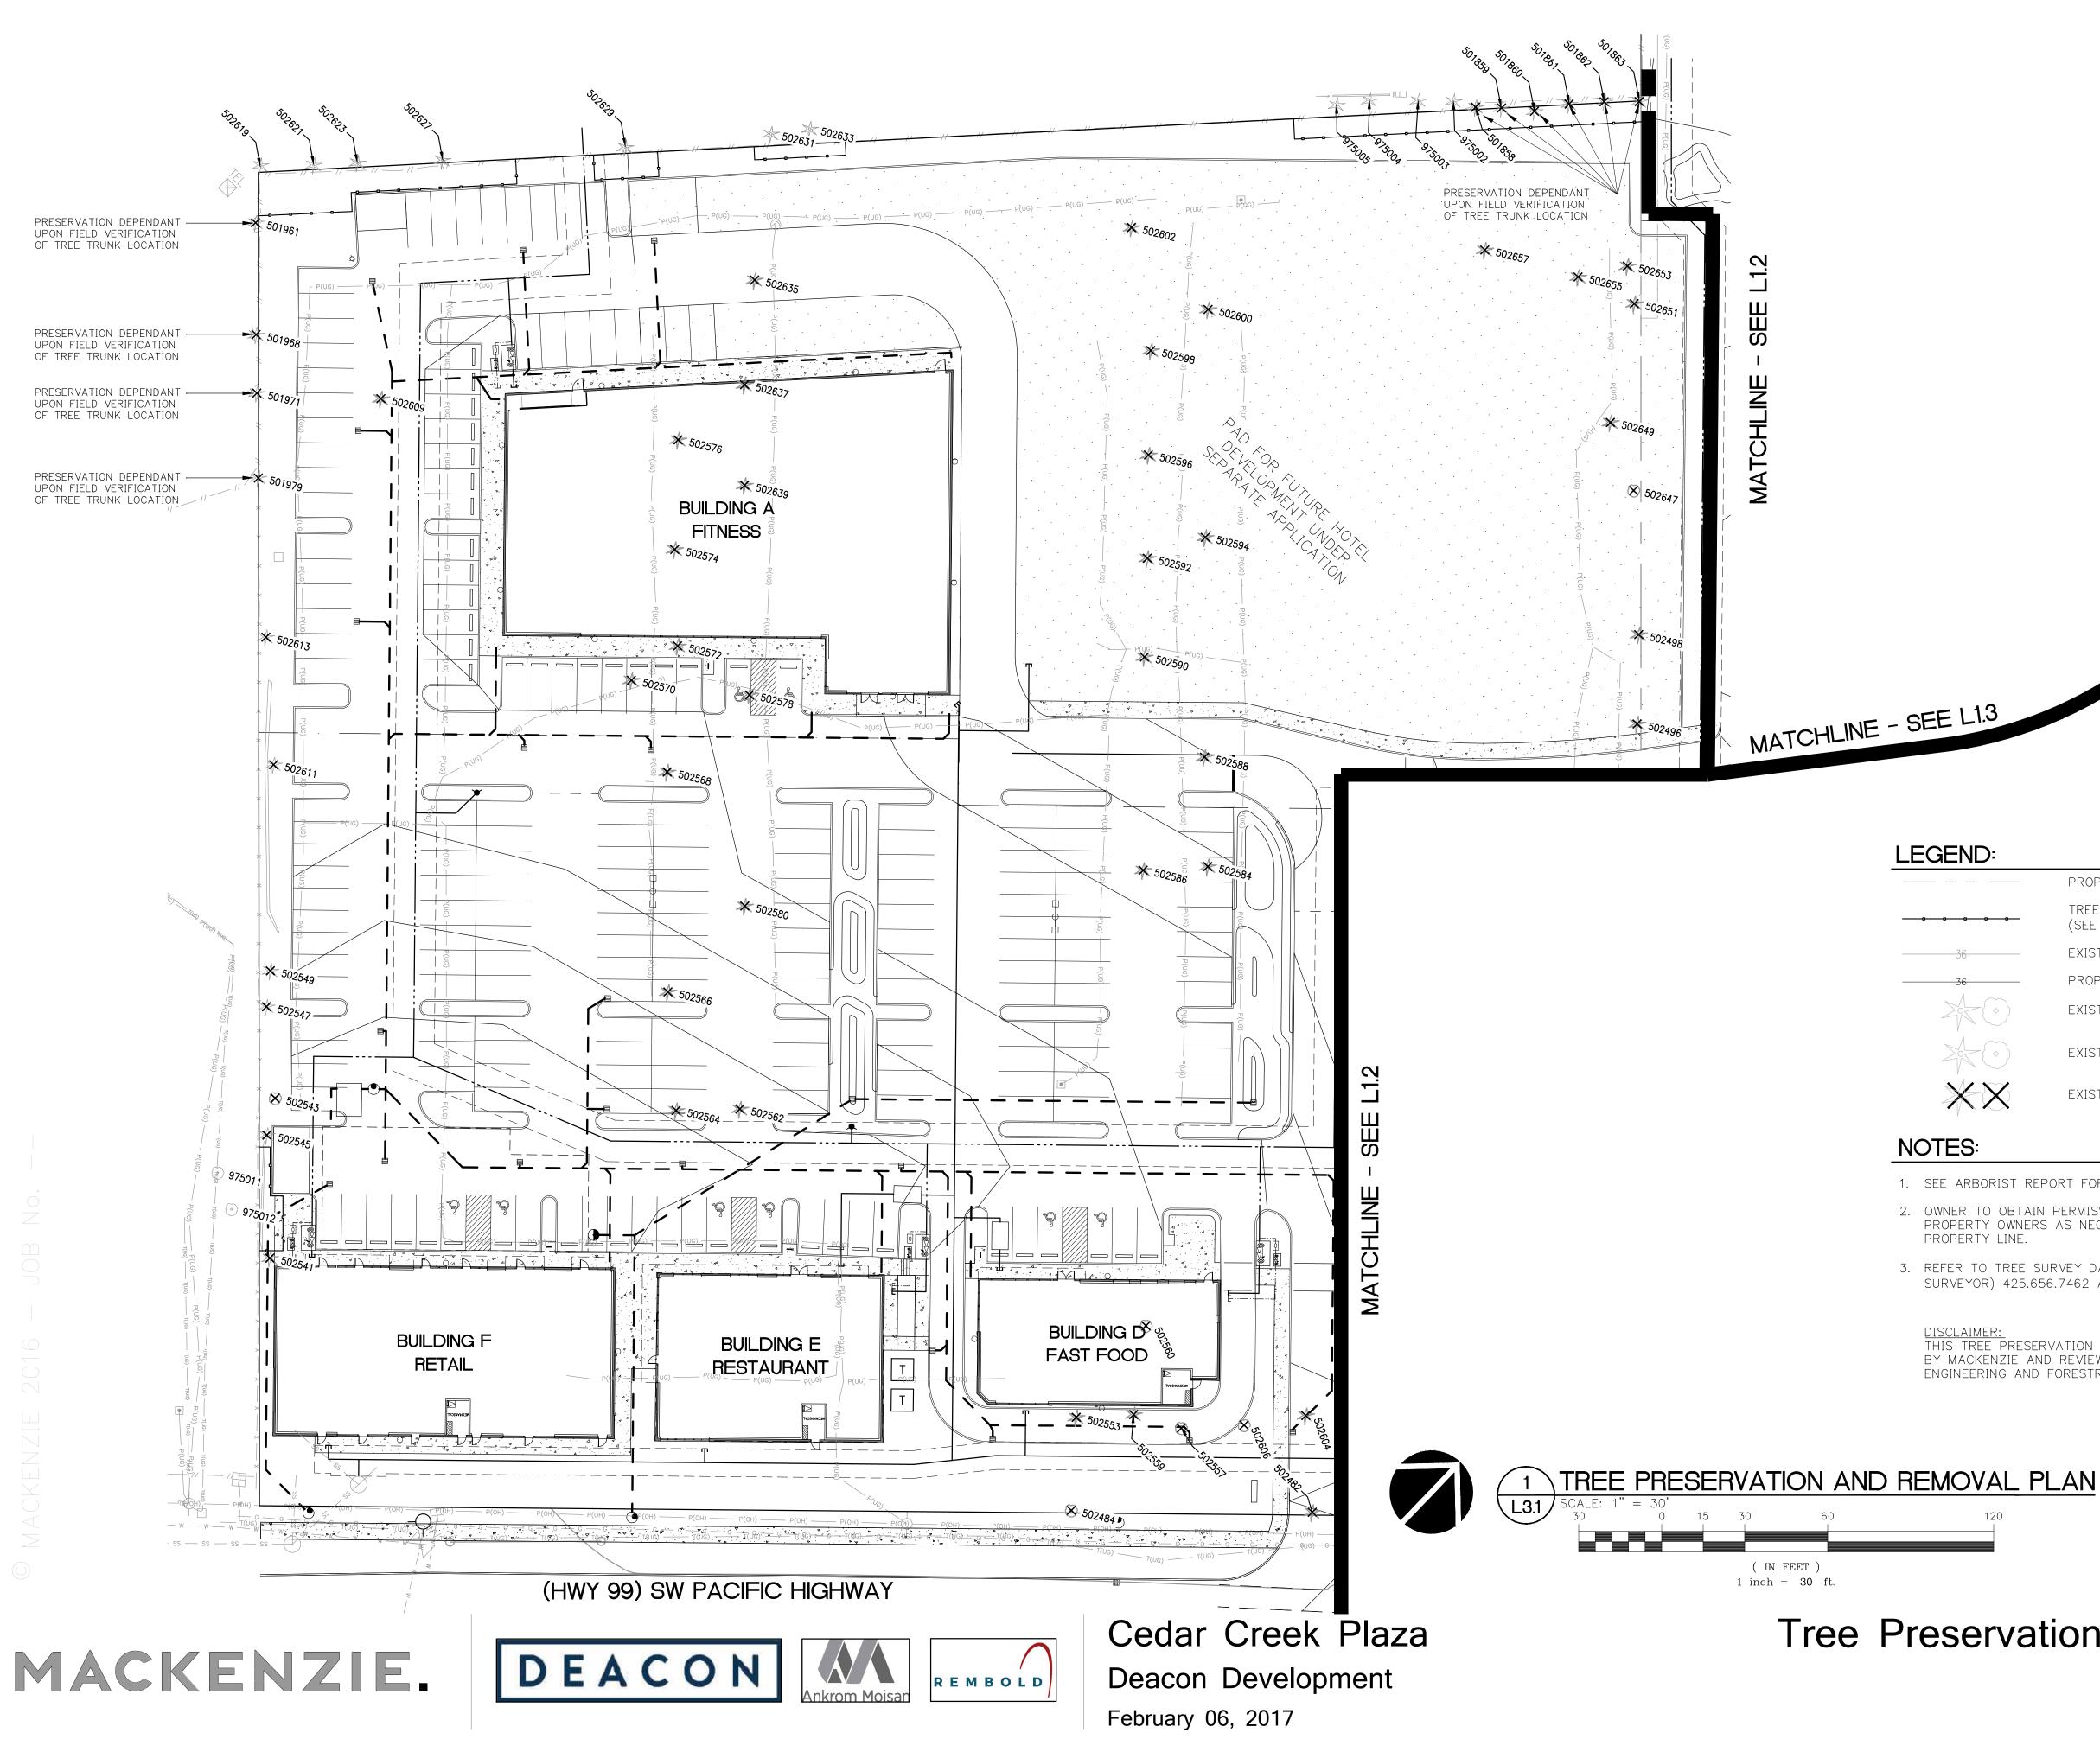

Tree Preservation and Removal Plan Site Design Submittal

<u>DISCLAIMER:</u> THIS TREE PRESERVATION AND REMOVAL PLAN WAS PREPARED BY MACKENZIE AND REVIEWED BY DAVID STEINKE WITH AKS ENGINEERING AND FORESTRY.

SURVEYOR) 425.656.7462 ATTN: BRIAN GILLOOLY

3. REFER TO TREE SURVEY DATED DECEMBER 05, 2016 FROM (PROFESSIONAL LAND

(SEE ARBORIST REPORT FOR FENCING SPECIFICATIONS)

EXISTING OFF-SITE TREE (PROTECT DURING CONSTRUCTION)

EXISTING TREE TO REMAIN (PROTECT DURING CONSTRUCTION)

2. OWNER TO OBTAIN PERMISSION FROM, AND COORDINATE WITH ADJACENT PROPERTY OWNERS AS NECESSARY FOR REMOVAL OF ANY TREES ON THE

1. SEE ARBORIST REPORT FOR MORE INFORMATION.

PROPERTY LINE

EXISTING CONTOUR

PROPOSED CONTOUR

TREE PROTECTION FENCING


EXISTING TREE TO BE REMOVED


MACKENZIE.



SEE L1.3



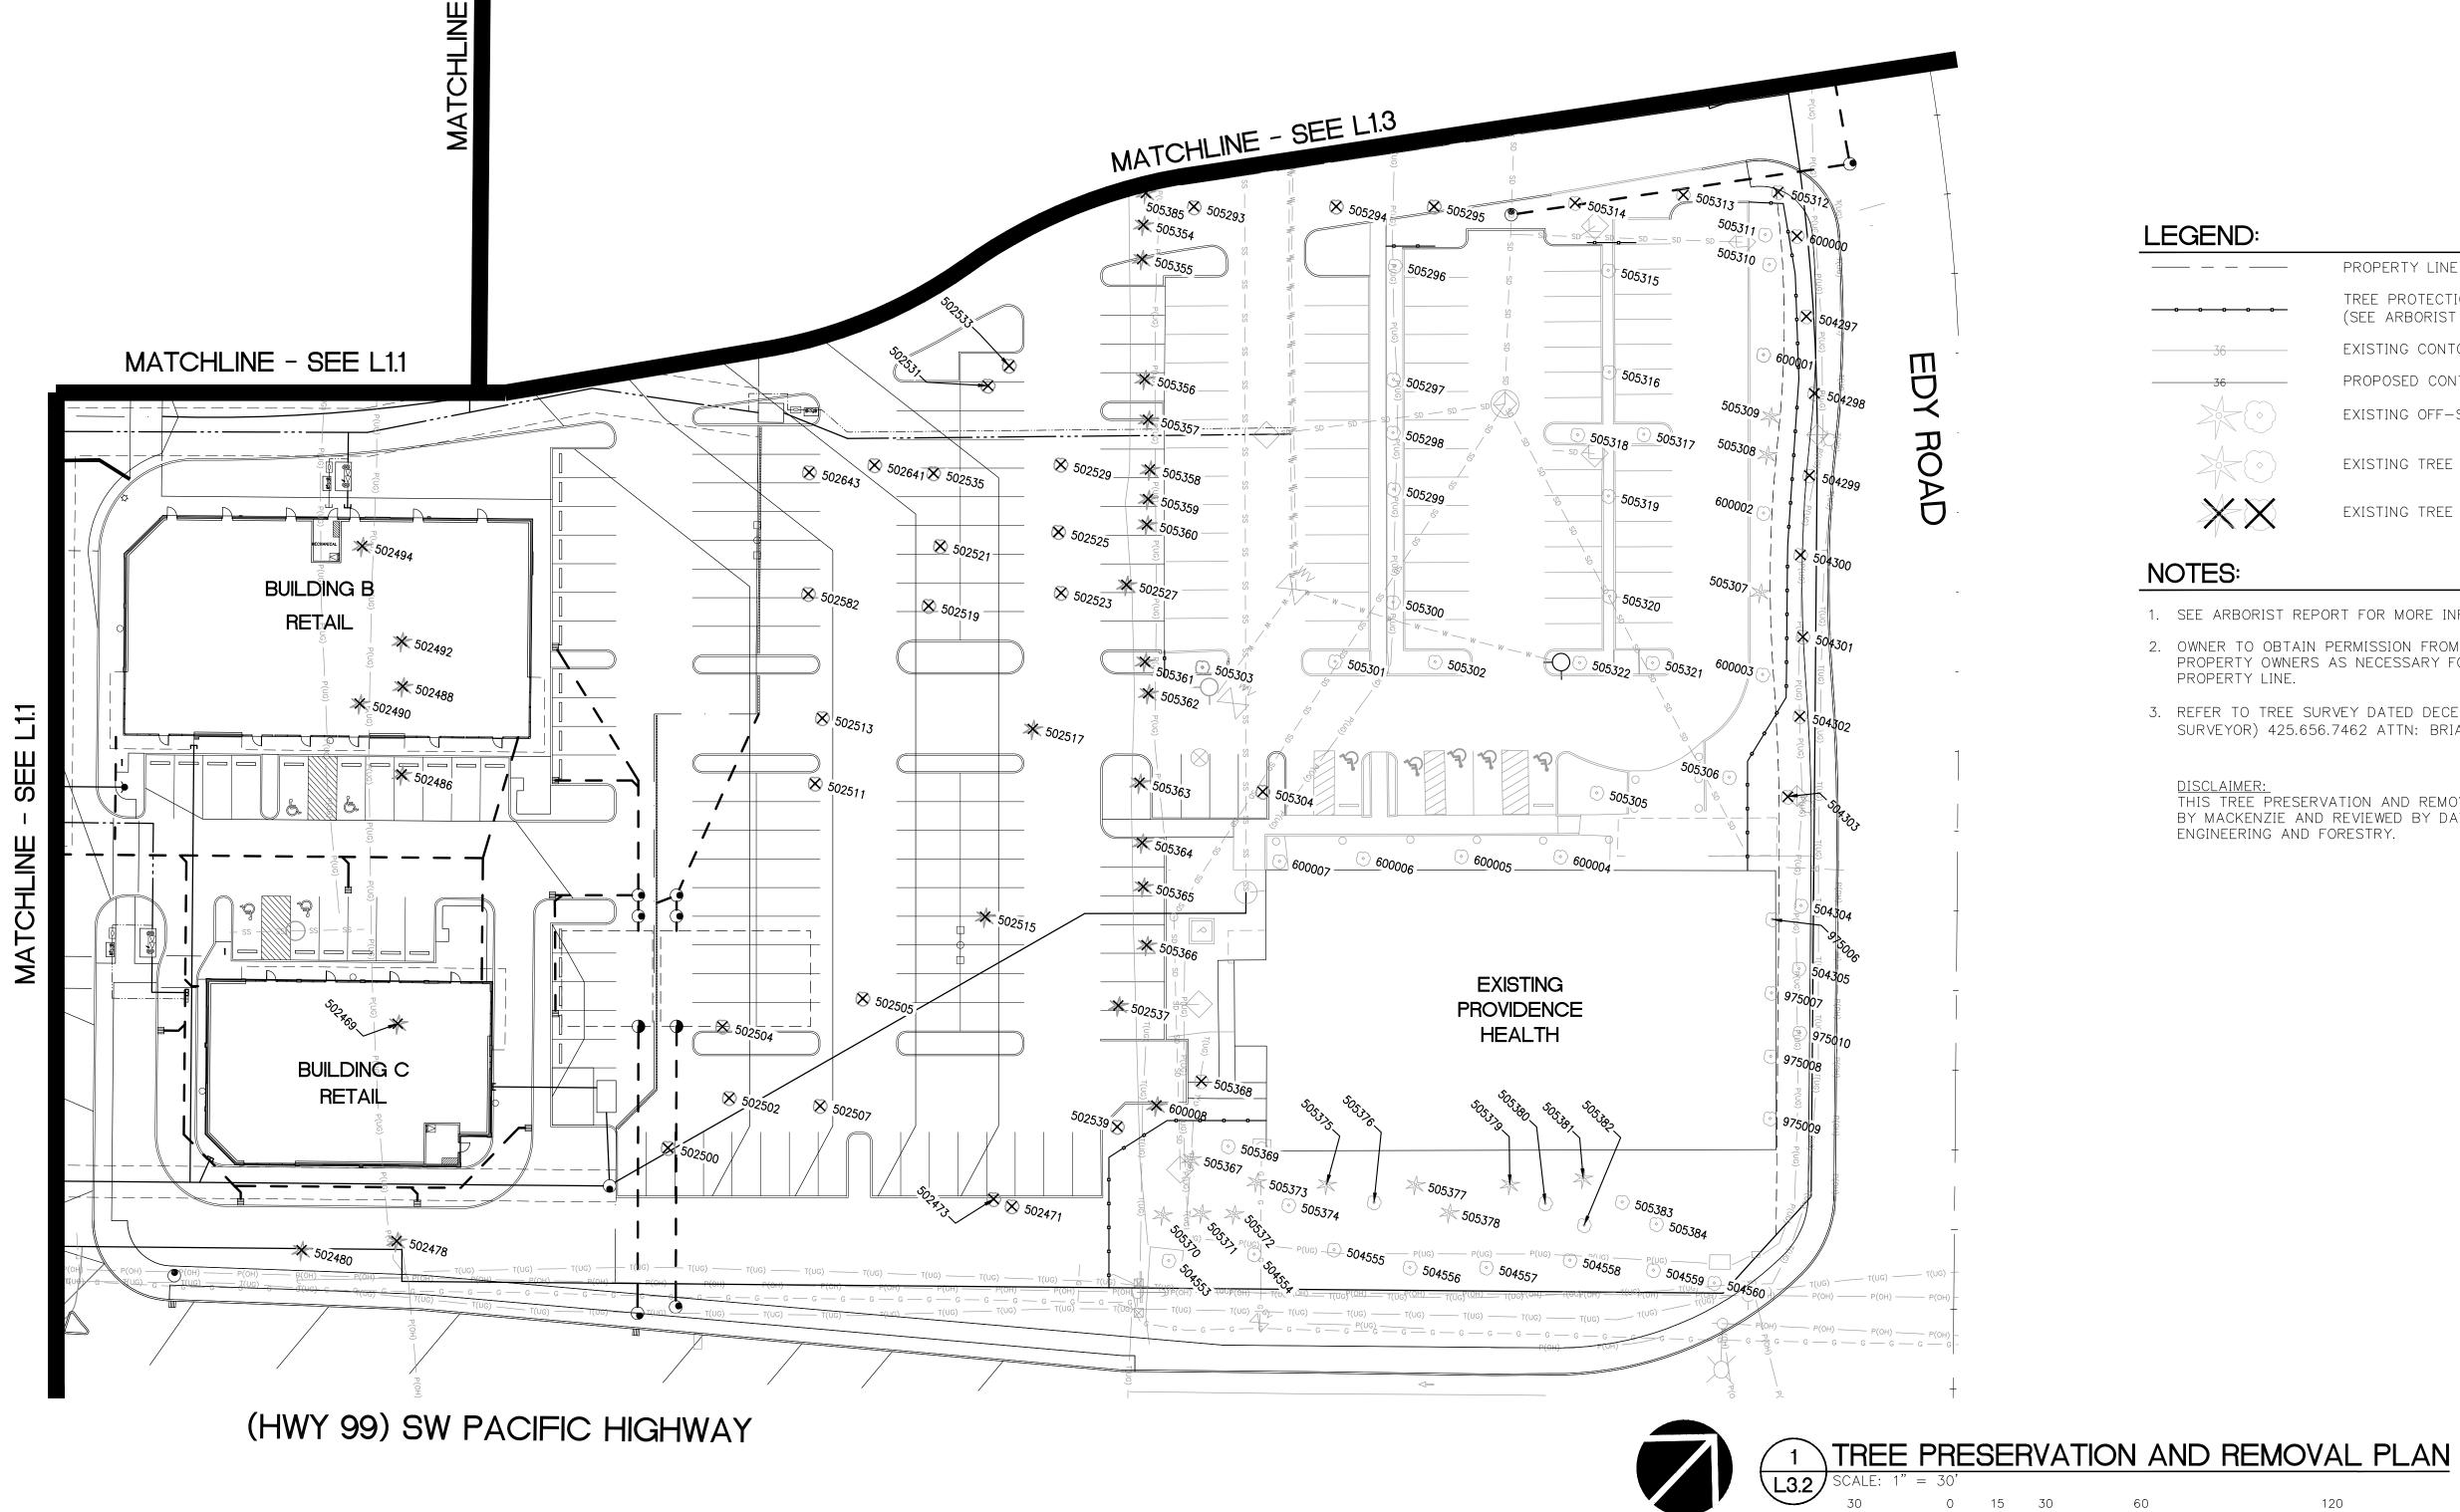

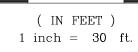

Cedar Creek Plaza Deacon Development February 06, 2017

REMBOLD

	PROPERTY LINE
	TREE PROTECTION FENCING (SEE ARBORIST REPORT FOR FENCING SPECIFICATIONS)
-36	EXISTING CONTOUR
-36	PROPOSED CONTOUR
XO	EXISTING OFF-SITE TREE (PROTECT DURING CONSTRUCTION)
	EXISTING TREE TO REMAIN (PROTECT DURING CONSTRUCTION)
$\times \times$	EXISTING TREE TO BE REMOVED
r.	

1. SEE ARBORIST REPORT FOR MORE INFORMATION.


2. OWNER TO OBTAIN PERMISSION FROM, AND COORDINATE WITH ADJACENT PROPERTY OWNERS AS NECESSARY FOR REMOVAL OF ANY TREES ON THE PROPERTY LINE.

3. REFER TO TREE SURVEY DATED DECEMBER 05, 2016 FROM (PROFESSIONAL LAND SURVEYOR) 425.656.7462 ATTN: BRIAN GILLOOLY

DISCLAIMER: THIS TREE PRESERVATION AND REMOVAL PLAN WAS PREPARED BY MACKENZIE AND REVIEWED BY DAVID STEINKE WITH AKS ENGINEERING AND FORESTRY.

Tree Preservation and Removal Plan Site Design Submittal

1.2

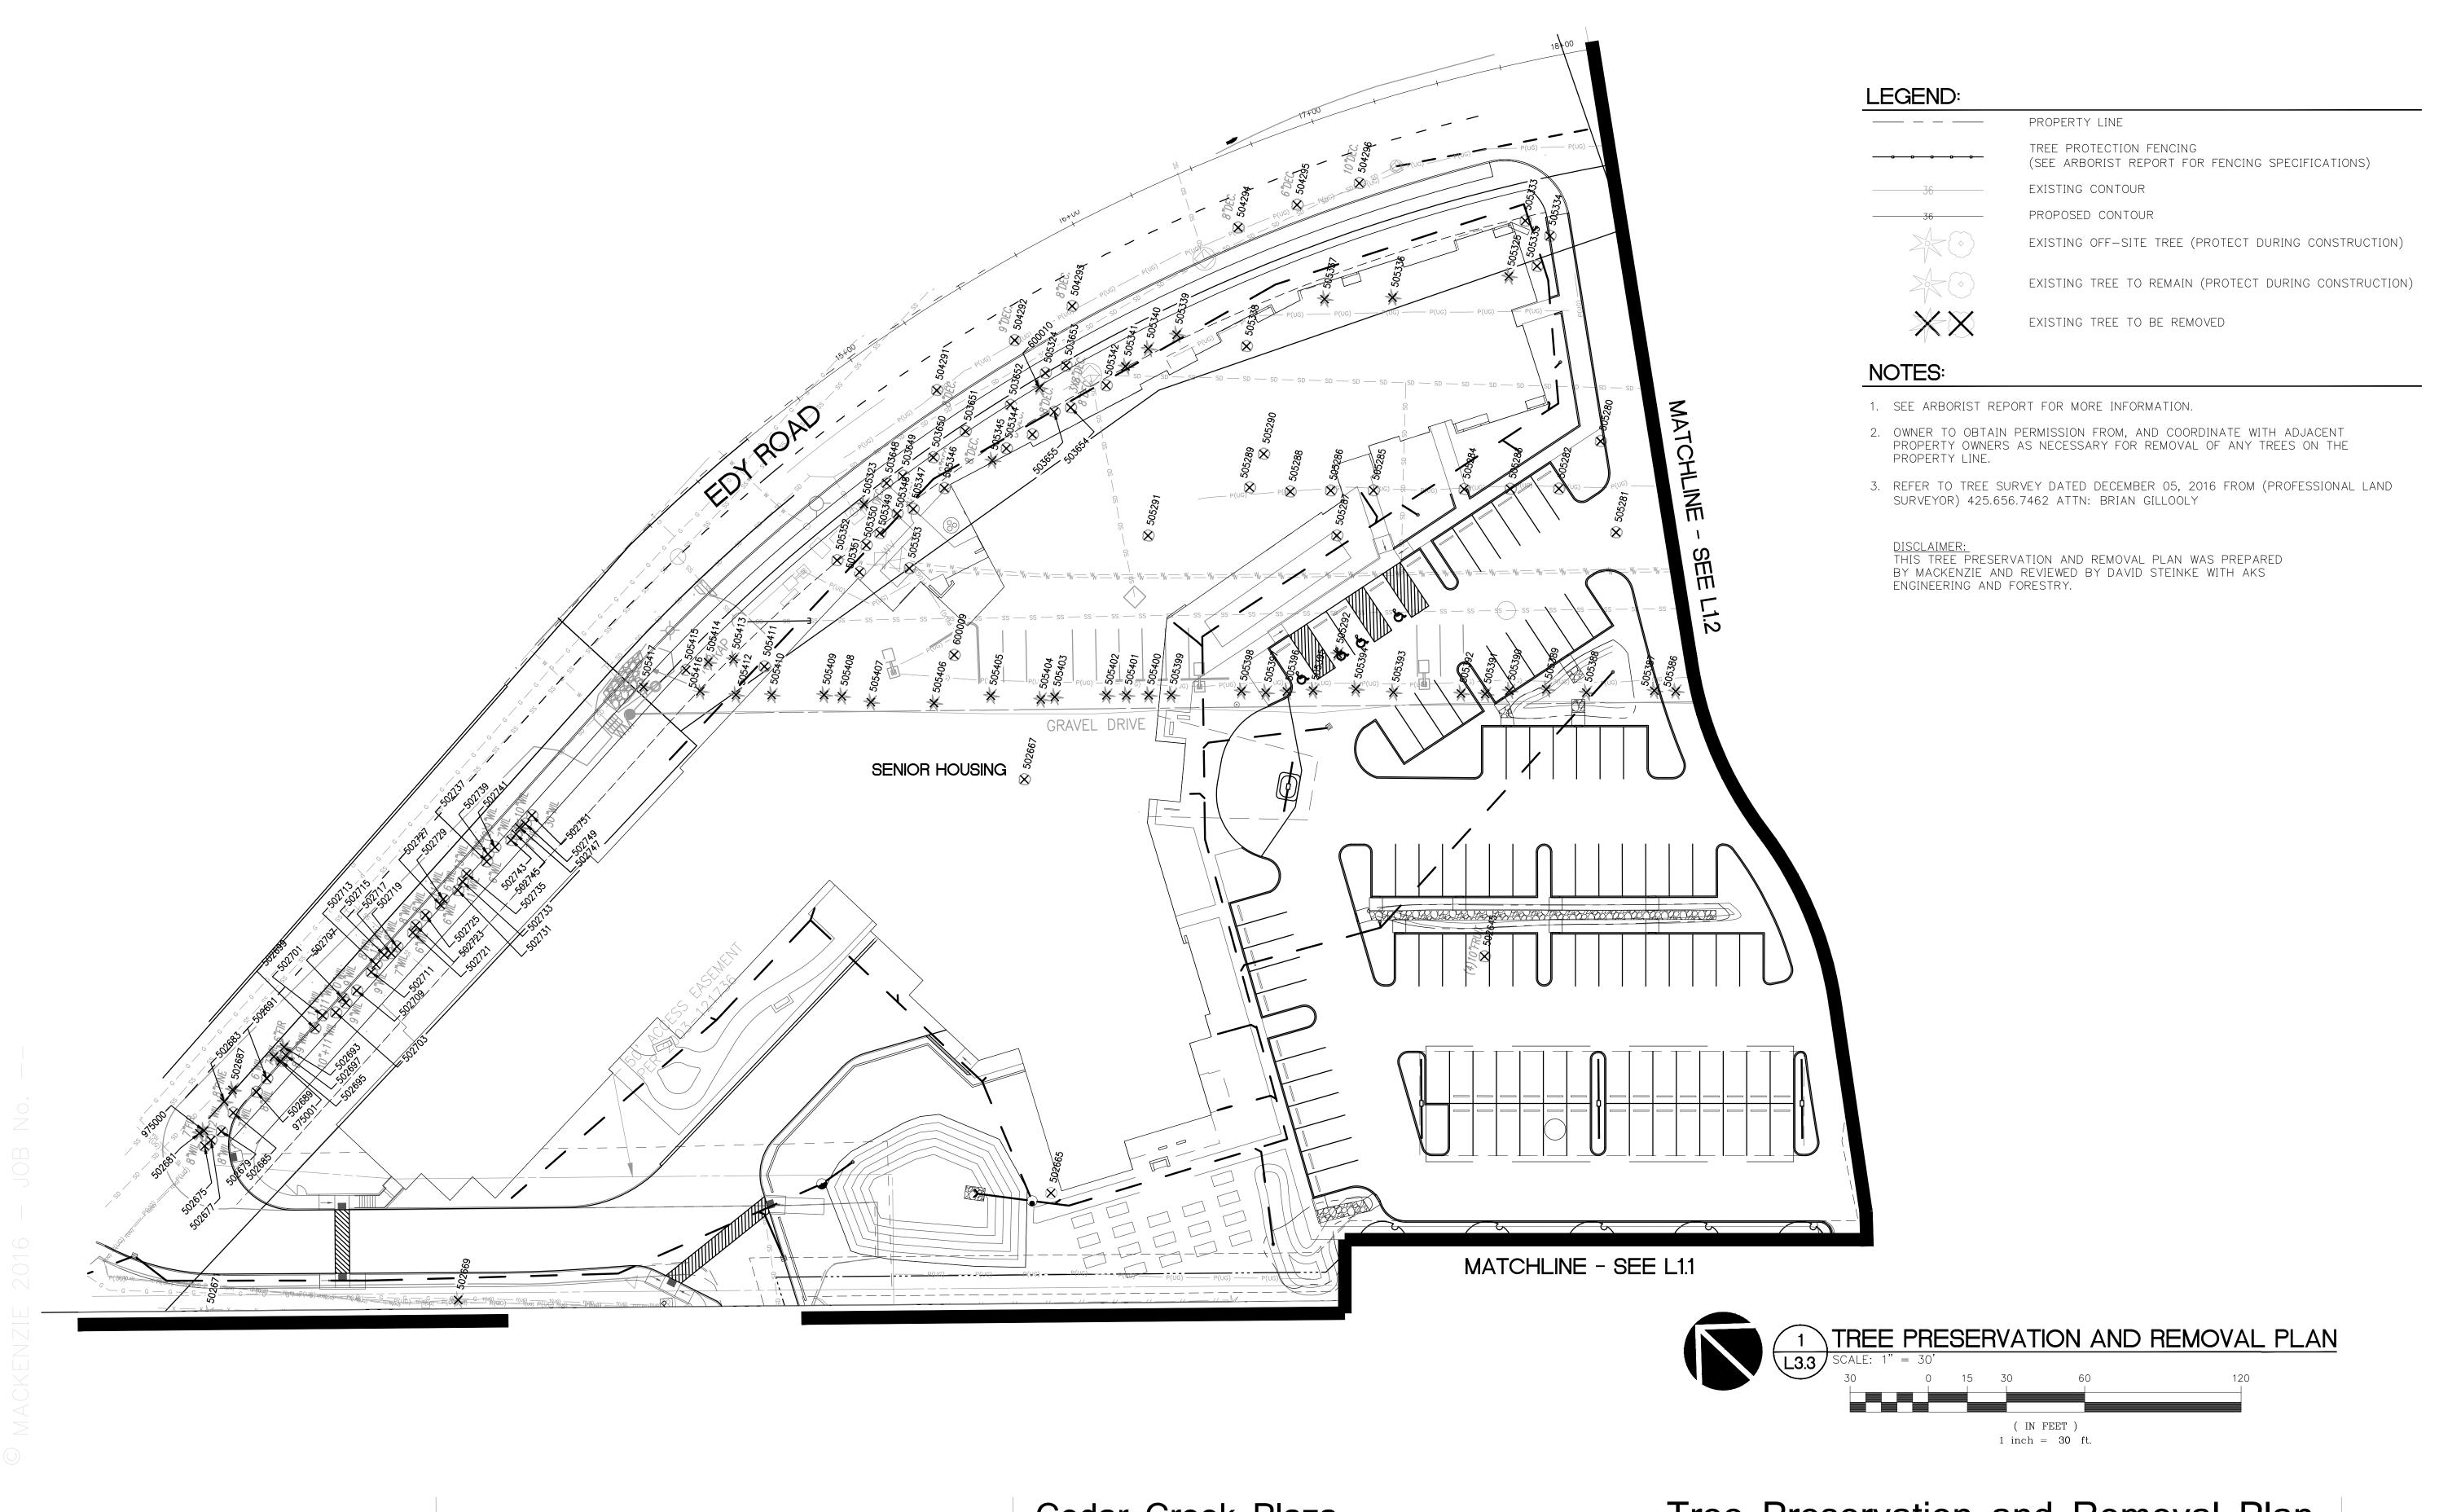



Cedar Creek Plaza Deacon Development February 06, 2017

	PROPERTY LINE
	TREE PROTECTION FENCING (SEE ARBORIST REPORT FOR FENCING SPECIFICATIONS)
	EXISTING CONTOUR
36	PROPOSED CONTOUR
	EXISTING OFF-SITE TREE (PROTECT DURING CONSTRUCTION)
	EXISTING TREE TO REMAIN (PROTECT DURING CONSTRUCTION)
$\times \times$	EXISTING TREE TO BE REMOVED

Tree Preservation and Removal Plan Site Design Submittal

L1.3

PLANT SCHEDULE

Image: Series and the series of the serie	s	CODE			1	
Image: Section of the section of th	\frown		BOTANICAL NAME / COMMON NAME	SIZE		QTY
AB ACER HUBRUM "BOWHALL" / BOWHALL MAPLE 2 CAL BBB C AB ACER HUBRUM "BOWHALL" / BOWHALL MAPLE 2 CAL BBB C CD CALOCEDERUS DECURRENS / INCENSE CEDAR 8'-10' HT, MIN BBB C CJ CERCIDIPHYLLUM JAPONICUM / KATSURA TREE 2 CAL BBB C CJ CERCIDIPHYLLUM JAPONICUM / KATSURA TREE 2 CAL BBB C CC CERCIDIPHYLLUM JAPONICUM / KATSURA TREE 2 CAL BBB C CC CERCIDIPHYLLUM JAPONICUM / KATSURA TREE 2 CAL BBB C CC CERCIS CANADENSIS / EASTERN REDBUD 2 CAL BBB C FM FRAINIUS PENNSYLVANICA 'IMARSHALL'S SEEDLESS' / MARSHALL'S SEEDLESS ASH 2 CAL BBB C FM FRAINUS SERRIULATA 'KWANZAN' / FLOWERING CHERRY 2 CAL BBB C FR PRUNUS SERRIULATA 'KWANZAN' / FLOWERING CHERRY 2 CAL BBB C TC TILLAX EUCHLORA / CRIMEAN LINDEN 2 CAL BBB C TC TILLAX EUCHLORA / CRIMEAN LINDEN 2 CAL BBB C TC TILLAX EUCHLORA / CRIMEAN LINDEN 2 CAL BBB C TC TILLAX EUCHLORA / CRIMEAN LINDEN 2 CAL BBB SHOUE		AG	ACER GRISEUM / PAPERBARK MAPLE	2" CAL. B&B		13
Color CALOCEDHUS DECURHENS / INCENSE CEDAH 81-10° HT MIN, BAS Color CALOCEDHUS DECURHENS / INCENSE CEDAH 81-10° HT MIN, BAS Color CERCIDIPHYLLUM, JAPONICUM / KATSURA TREE 2° CAL, BAS Color CERCIDIPHYLLUM, JAPONICUM / KATSURA TREE 2° CAL, BAS Color CERCIDIPHYLLUM, JAPONICUM / KATSURA TREE 2° CAL, BAS Color CERCIDIPHYLLUM, JAPONICUM / KATSURA TREE 2° CAL, BAS Color CERCIDIPHYLLUM, JAPONICUM / KATSURA TREE 2° CAL, BAS Color FM FRAXINUS PENNSYLVANICA ' MARSHALL'S SEEDLESS' / MARSHALL'S SEEDLESS ASH 2° CAL, BAS Color IF URICORNING PENNSYLVANICA ' MARSHALL'S SEEDLESS' / MARSHALL'S SEEDLESS ASH 2° CAL, BAS Color IF URICORNING Y FLOWENING CHERRY 2° CAL, BAS Color PRUNUS SERRULATA ' KWANZAN' / FLOWENING CHERRY 2° CAL, BAS Color TULA FLICATA ' HOGAN' / HOGAN CEDAR 2° CAL, BAS Color TULA FLICATA ' HOGAN' / HOGAN CEDAR 2° CAL, BAS Color SOTANICAL NAME / COMMON NAME 2° CAL, BAS Color SOTANICAL NAME / COLORIZAM' / GOLDEN RUBY BARBERRY 3° CAL, 3° SHRUES CODE SOTANICAL NAME / COMMO						
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Image: Second	$\overline{\frown}$	AB	ACER RUBRUM `BOWHALL` / BOWHALL MAPLE	2" CAL. B&B		14
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Image: Construct of the second sec	\sim					
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Image: Constraint of the second se	\bigcap	PK	PRUNUS SERRULATA `KWANZAN` / FLOWERING CHERRY	2" CAL. B&B		21
Image: Constant of the second seco	$\langle \cdot \rangle$					
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Image: Second	ground along	IP	THUJA PLICATA "HOGAN" / HOGAN CEDAR	8 -10 HI. MIN. B&B		35
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Image: Series of the series		CODE		SIZE	SPACING	QTY
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Image: Column and the set of the se	$\langle \mathcal{P} \rangle$					
Image: Column and the set of the se				5 0 4 1	401 0.0	137
Image: Construct of the sector of the sec		DL	BERBERIS I HUNDERGII LIIVIE GLOW / LIIVIE GLOW BARBERRI	5 GAL	48" o.c.	137
Image: Column State Column Calamagrostis X acutiflora `OVERDAM` / OVERDAM FEATHER REED GRASS 1 Gal 30" Image: Column State Column State 5 Gal 54" Image: Column State Cornus Sericea `Kelseyi` / Kelseyi Dogwood 2 Gal 30" Image: Column State GS Gaultheria Shallon / Salal 5 Gal 54"	Y~4					
Image: Comparison of the system Comparison of the system Second of the system	<u>A</u>	BR	BERBERIS THUNBERGII `ROYAL CLOAK` / ROYAL CLOAK BARBERRY	5 GAL	48" o.c.	92
Image: Comparison of the system Comparison of the system Second of the system	Ecculus of					
Image: Second	MINN/	CO	CALAMAGROSTIS X ACUTIFLORA `OVERDAM` / OVERDAM FEATHER REED GRASS	1 GAL	30" o.c.	255
Image: Second						
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Image: Constraint of the second se	\bigcirc					
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	5.7	GS	GAULTHERIA SHALLON / SALAL	o GAL	54" o.c.	112
IS ILEX GLABRA `SHAMROCK` / INKBERRY 5 GAL 60"	Ŵ					
		IS	LEX GLABRA `SHAMROCK` / INKBERRY	5 GAL	60" o.c.	84
	V The second					
MA MAHONIA AQUIFOLIUM / OREGON GRAPE 1 GAL., 6" HT. MIN. 54"	(v)	MA	MAHONIA AQUIFOLIUM / OREGON GRAPE	1 GAL., 6" HT. MIN.	54" o.c.	106
	(ی یک					
NG NANDINA DOMESTICA `GULF STREAM` TM / HEAVENLY BAMBOO 5 GAL 36"		NG	NANDINA DOMESTICA `GULF STREAM` TM / HEAVENLY BAMBOO	5 GAL	36" o.c.	330
POM POLYSTICHUM MUNITUM / WESTERN SWORD FERN 2 GAL 48"		POM		2 GAL	48" o.c.	14
	×	FOIVI			40 0.0.	14
	July July	PO	PRUNUS LAUROCERASUS `OTTO LUYKEN` / LUYKENS LAUREL	5 GAL	36" o.c.	428
PO PRUNUS LAUROCERASUS `OTTO LUYKEN` / LUYKENS LAUREL 5 GAL 36"	۲ ۲ ۲					
PO PRUNUS LAUROCERASUS `OTTO LUYKEN` / LUYKENS LAUREL 5 GAL 36"	\frown	SW	SPIRAEA JAPONICA `WALBUMA` / MAGIC CARPET SPIREA	2 GAL	36" o.c.	121
	())					
	\checkmark					1
Image: Stress of the state		VD	VIBURNUM DAVIDII / DAVID VIBURNUM	5 GAL	42" o.c.	210
Image: Second state SW SPIRAEA JAPONICA `WALBUMA` / MAGIC CARPET SPIREA 2 GAL 36"		VD	VIBURNUM DAVIDII / DAVID VIBURNUM	5 GAL	42" o.c.	210

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LANDSCAPE CALCULATIONS

LANDSCAPE AREAS EXISTING LANDSCAPE TO REMAIN: NEW LANDSCAPE TO BE INSTALLED: TOTAL LANDSCAPE AREA:

19,684 SQFT. 50,760 SQFT. 70,444 SQFT.

ESTIMATED NEW PLANT QUANTITIES TREES: SHRUBS: GROUNDCOVER: 5,934 TURF: STORMWATER

200 2,421 9,946 SF. + 4,998 SF. AT PROVIDENCE (TO REMAIN) TOTAL: 14,944 SF. PLANTING AREA: 228 SHRUBS/4,552 PLUGS

TREE CANOPY CALCULATIONS

SITE TREE CANOPY COVERAGE

	1 00				
30% SITE CANOPY COVERAGE	E REQU	IRED			
TREE SPECIES	QTY.	SIZE CLASSIFICATION	MATURE SPREAD	MATURE CANOPY AREA (SF)	TOTAL CANOPY COVERAGE (SF)
ACER RUBRUM `BOWHALL`	14	SMALL	15'	176	2,464
CALOCEDRUS DECURRENS	21	SMALL	30'	706	14,826
CERCIDIPHYLLUM JAPONICUM	11	MEDIUM	40'	1256	13,816
CERCIS CANADENSIS	18	SMALL	30'	706	12,708
FRAXINUS PENNSYLVANICA `MARSHALL`S SEEDLESS`	31	MEDIUM	40'	1256	38,936
LIRIODENDRON TULIPIFERA `FASTIGIATA`	8	SMALL	15'	176	1,408
PRUNUS SERRULATA `KWANZAN`	21	SMALL	20'	314	6,594
THUJA PLICATA `HOGAN`	35	SMALL	15'	176	6,160
TILIA X EUCHLORA	8	SMALL	35'	962	7,696
ZELKOVA SERRATA `GREEN VASE'	33	SMALL	30'	706	23,298
			TOTAL QUALIFYING TRE	EES	200
			TOTAL CANOPY COVER	AGE AREA	127,906
			SITE AREA		325,658
			% OF SITE		39.2%

SITE TREE PRESERVATION, REMOVAL AND MITIGATION

	QTY.	
TOTAL EXISTING TREES	255	RETAIL, PROVIDENCE AND SENIOR HOUSING
EXISTING TREES TO BE REMOVED	193	RETAIL, PROVIDENCE AND SENIOR HOUSING
NEW TREES (PROPOSED)	200	RETAIL AND PROVIDENCE
NEW TREES (PROPOSED)	79	SENIOR HOUSING
TOTAL NEW TREES (PROPOSED)	279	RETAIL, PROVIDENCE AND SENIOR HOUSING

PLANT SCHEDULE - CONTINUED

SHRUB AREAS	CODE	BOTANICAL NAME / COMMON NAME	CONT	SPACING	QTY
	SP	STORMWATER PLANTING / SHRUBS AND GROUNDCOVER PER CWS STANDARDS	N/A		4,552 SF
GROUND COVERS	CODE	BOTANICAL NAME / COMMON NAME	CONT	SPACING	QTY
मात्रात्वात्वात्वात्वात्वात्वात्वात्वात्वात्व	AU	ARCTOSTAPHYLOS UVA-URSI / KINNIKINNICK	1 GAL	18" o.c.	1,848
	FE	FESTUCA GLAUCA `ELIJAH BLUE` / BLUE FESCUE	1 GAL	12" o.c.	3,142
· · · · · · · · · · · · · · · · · · ·	L2	LAWN -	N/A		5,318 SF
	RC	RUBUS CALYCINOIDES / GREEN CARPET RASPBERRY	1 GAL	18" o.c.	944
		EXISTING LANDSCAPE TO REMAIN			




Cedar Creek Plaza Deacon Development February 06, 2017

Landscape Plan Site Design Submittal


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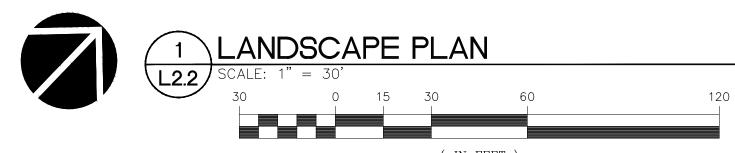
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(IN FEET) 1 inch = 30 ft.

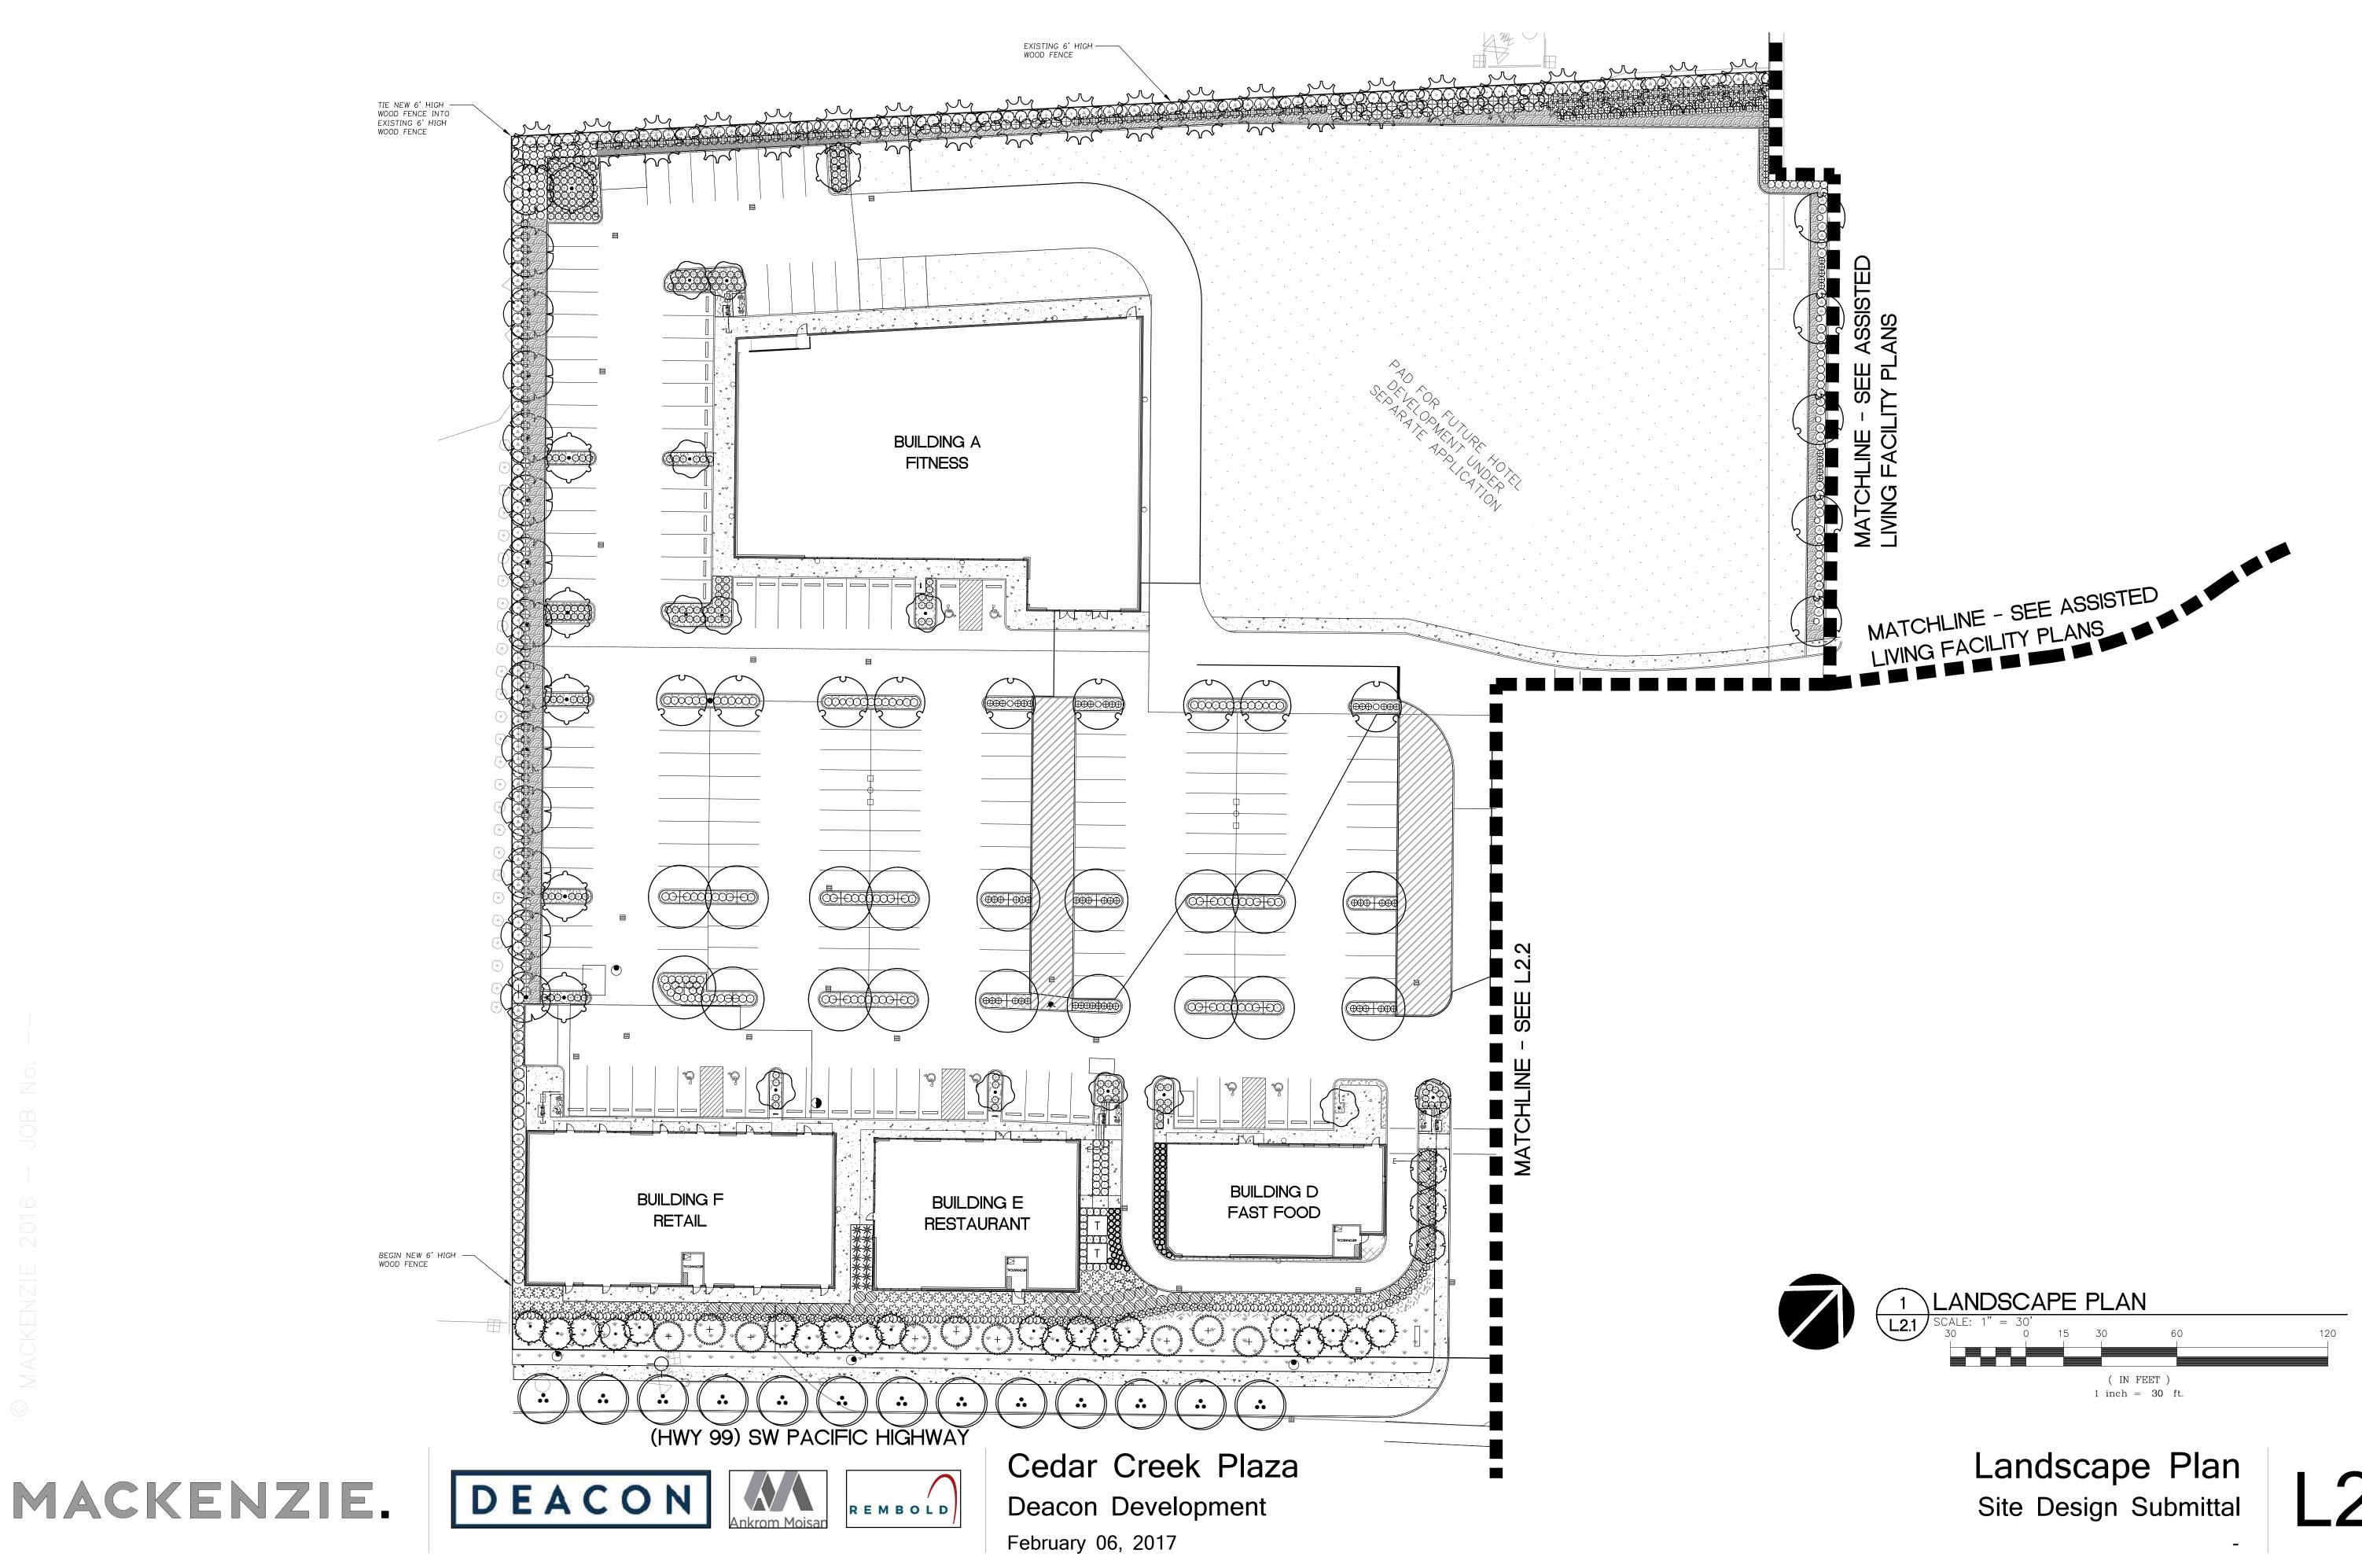

Cedar Creek Plaza Deacon Development February 06, 2017

EDY ROAD

Landscape Plan Site Design Submittal

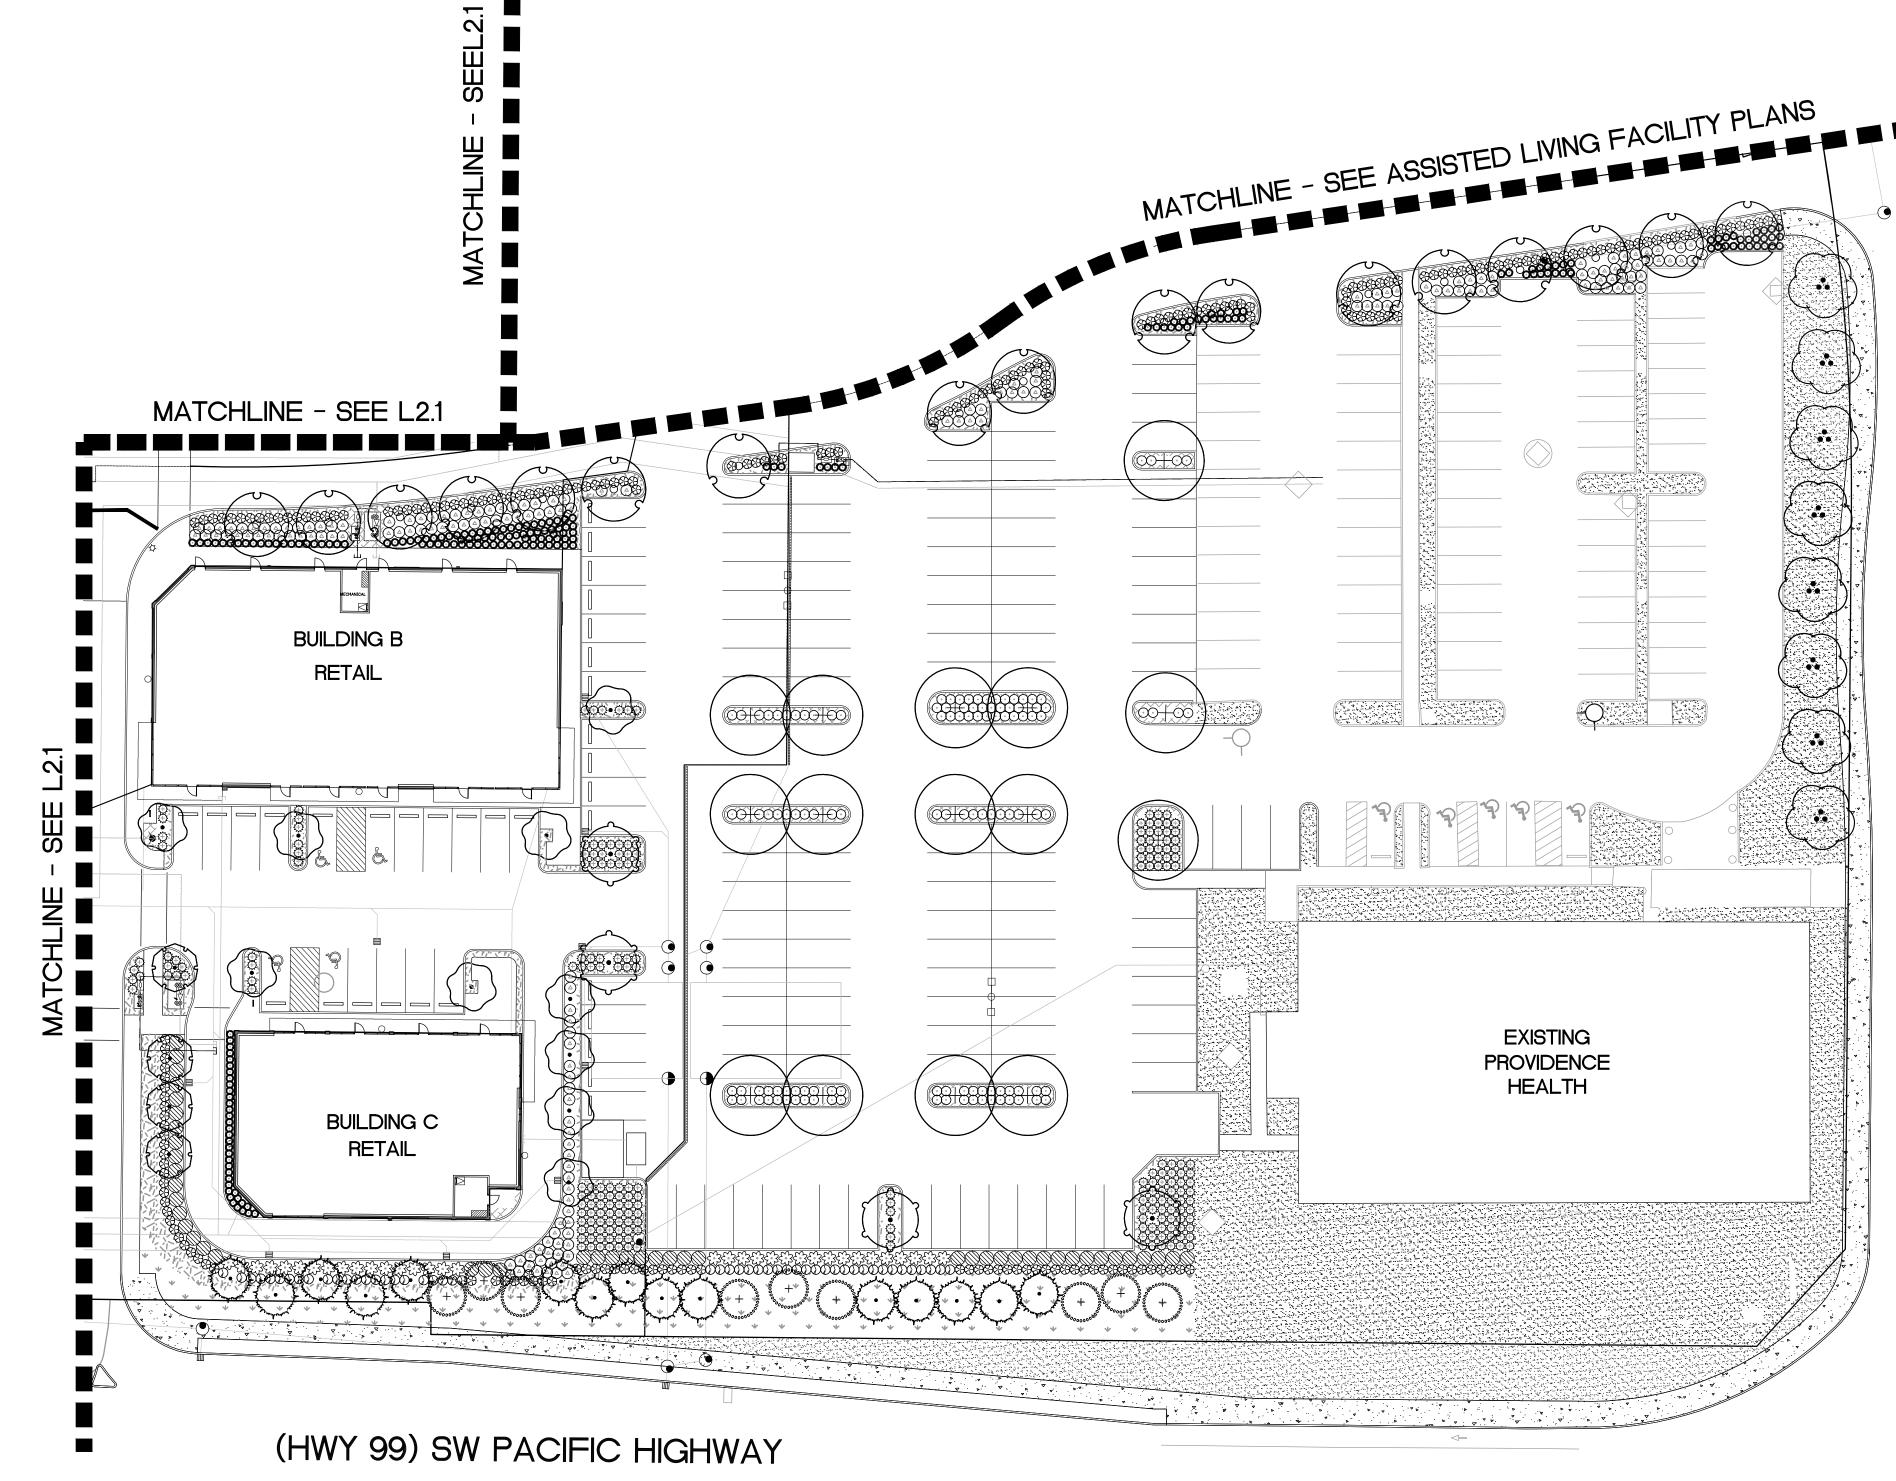_2.2

SITE TREE CANOPY COVERAGE

PLANT LIST: TREES

0


SYMBOL QTY.

TREE SPECIES		SIZE CLASSIFICATION	MATURE SPREAD	MATURE CANOPY AREA	CANOPY COVERAGE (SF)
ACER GRISEUM		SMALL	20'	314	1,256
CORNUS FL. 'CHEROKEE PRINCESS'	15	SMALL	20'	314	4,710
CHAMAECYPARIS OB. 'GRACILIS'	4	SMALL	10'	79	316
FAGUS SYLVATICA 'RIVERSII'	2	LARGE	40'	1,256	2,512
FRAXINUS PENN. 'MARSHALL'	15	LARGE	40'	1,256	18,840
FRAXINUS LATIFOLIA	13	MEDIUM	30'	707	9,191
PRUNUS YEDOENSIS 'AKEBONO'	6	MEDIUM	30'	707	4,242
PINUS SYLVESTRIS	5	MEDIUM	20'	314	1,570
RHAMNUS PURSHIANA	7	SMALL	20'	314	2,198
ACER PALMATUM 'BLOODGOOD'	2	SMALL	20'	314	628
ACER PALMATUM 'KATSURA'	3	SMALL	15'	177	531
THUJA PLICATA 'FASTIGIATA'	2	SMALL	15'	177	354
EXISTING DOUGLAS FIR		LARGE	30'	707 (x 2)	1,414
PARKING LOT TREES BY OTHERS		LARGE	40'	1,256	5,024
			тот	AL QUALIFYING TREES	83

			SITE AREA % SITE COVERAGE	175,810 SF 30%		R TREE TO		- HA
ST:	TREES							
-	QTY.	LATIN NAME/Comm	non Name	SIZE				
S	TREET	TREE						
	20	TILIA EUCHLORA Crimean Linden		2" cal.				
P	ARKING	LOT TREE						
	15	FRAXINUS PENN. 'N Marshall Seedless		3" cal.				
SI	te tre	E			PLANT SYM	BOLS &	SUGGESTED	PLANT LIST
					SYMBOL	QTY.	TYPE	
	4	ACER GRISEUM Paperbark Maple		2" cal.				

EXISTING 7" CALIPER-FIR TREE TO REMAIN

2 ACER PALMATUM (BLODGOOD) Bioodgood Joponese Maple 2" cal. Snrubs Magnolia Enkinthus 0 3 ACER PALMATUM (KATSURA' Katsura Japanese Maple 2" cal. 2" cal. 237 Medium/Large Snrubs Abelia Columnar J Spring Bou Hydrongeo Rhoddoendr Sundace Ar Border 6 PRUNUS YEDOENSIS 'AKEBONO' Akebono Flowering Cherry 3" cal. 2" cal. 26 643 Small/Medium Snrubs Flower Can Hold r holly Nandino Priver Hon Surceocacc Water Purple Beech 15 CORNUS FL, 'OHEROKEE PRINCESS' Cherokee Princess' Sender Hincki (Cyress 2" cal. 249 Perennials/Grasses Dayli Unit lerree Dovid Vibur Siender 4 CHAMAECYPARIS OB, 'GRACILIS' Sociah Pine 6' ht. 219 Perennials/Grasses Dayli Unit lerree Dovid Vibur Siender 5 PINUS SYLVESTRIS Sociah Pine 6' ht. 219 Perennials/Grasses Dayli Sind Sward Fem Moring Log Social Surubs 0 224 Small Native Sind Sward Fem Nutka Rese Social Sward Fem Nutka Reser Social Sward Fem Nutka Reser Social Sward Fem Nutka Reser Social Sward Fem Nutka Reser Social Sward Fem Nutka Reser Social Swar	Λ						4 · · · ·	••••	
Bioodgood Japanese Mople Enkinthus Image: Shruba strain	\mathcal{H}	4		2"	cal.				
Katsura Japanese Maple Shrubs Shrubs Spring Bour Hydronges 6 PRUNUS YEDOENSIS 'AKEBONO' 3" cal. Spring Bour Hydronges Rhododendr 6 PRUNUS YEDOENSIS 'AKEBONO' 3" cal. Small /Medium Flower Can Hydronges 1 2 FACUS SYLVATICA 'RIVERSI' 2" cal. So 643 Small /Medium 1 CORNUS FL. 'CHEROKEE PRINCESS' 2" cal. So 643 Small /Medium 1 CORNUS FL. 'CHEROKEE PRINCESS' 2" cal. So 643 Small /Medium 1 CORNUS FL. 'CHEROKEE PRINCESS' 2" cal. So 643 Small /Medium 1 CORNUS FL. 'CHEROKEE PRINCESS' 2" cal. So and anticle princesse David Vibur 1 Cherokee Princess Flowering Dogwood 6' ht. Sc and anticle princesse David Vibur 1 Cherokee Princess Flowering Dogwood 6' ht. Sc and anticle princesse Bayliy 1 Cherokee Princess 6' ht. 249 Perennials/Grasses Bayliy 1 Scatch Pline So and anticle princesse Bayliy Evergold Sk Horigo anticle princesse	R	2		2"	cal.	$^{\odot}$	11	-	
6 PRUNUS YEDOENSIS 'AKEBONO' Akebono Flowering Cherry 3" cal. Rhododenth Sundance M Wax Leaf F Barberry 4 FAGUS SYLVATICA 'RIVERSI' Rivers Purple Beech 2" cal. 64.3 Small/Medium Shrubs Flower Carp Heiler Holy Nardina Privet Ham Sarcococcc Wintercreeg David Vibur 15 CORNUS FL, 'CHEROKEE PRINCESS' Cherokee Princess Flowering Dogwood 2" cal. 249 Perennials/Grasses David Waxican Fe 4 CHAMAECYPARIS OB. 'CRACILIS' Scoten Pine 6' ht. 249 Perennials/Grasses David Wexican Fe 5 PINUS SYLVESTRIS Scoten Pine 6' ht. 234 Small Native Shrubs Kelsey Dog Salal Sword Fern Nutko Rose 0 22 ACER CICINATUM Yine Maple 5' ht. 934 Groundcover Kinnikinnick Greeping T 13 FRAXINUS LATIFOLIA Cascoro 2" cal. 210 14,324 SF Fine Lown 13 PRAXINUS PURSHIANA Cascoro 2" cal. 210 Stormwater Facility Native Shrup Native Shrup 14,324 SF Fine Lown 2" cal. 210 Stormwater Facility Native Shrup Native Shrup	\bigcirc	3		2"	cal.		237	, .	Columnar Junipe Spring Bouquet `
+ 2 Inversion Stream Anderson 2 Coll Shrubs Heller Holly Nondina Privet Hon Sarcooccoc Construction on Sarcooccoc Constructinde Construction on Sarcooccoc Construction on		6		3"	cal.				Rhododendron Sundance Mexica Wax Leaf Privet
15 CORNUS FL. 'CHEROKEE PRINCESS' Cherokee Princess Flowering Dogwood 2" cal. David Vibur 4 CHAMAECYPARIS OB. 'GRACILIS' Slender Hinoki Cypress 6' ht. 249 Perennials/Grasses David Vibur 5 PINUS SYLVESTRIS Scotch Pine 6' ht. 234 Small Native Shrubs Essender Kelsey Dog Solal Sword Fern Nutka Rose WATER QUALITY TREES 2 ACER CIRCINATUM Vine Maple 5' ht. 934 Groundcover Kinnikinnick Creeping The Pachysandr Coast Strav 7 RHAMNUS PURSHIANA Cascara 2" cal. 220 Stormwater Facility Native Shrub Native Shrub Native Shrub 2 THUJA PLICATA 6' ht. 220 Stormwater Facility Native Shrub Native Shrub Vative Shrub	+	2		2"	cal.		643	Small/Medium Shrubs	Flower Carpet R Heller Holly Nandina Privet Honeysuck Sarcococca Wintercreeper
4 CHAMAECYPARIS OB. 'GRACILIS' 6' ht. Evergoid Set Ferns Hosto 5 PINUS SYLVESTRIS 6' ht. Mexican Fe 6 ht. Morning Lig Lavender Morning Lig Lavender WATER QUALITY TREES 6' ht. Small Native Shrubs Kelsey Dog Shrubs 0 22 ACER CIRCINATUM Vine Maple 5' ht. 934 Groundcover 13 FRAXINUS LATIFOLIA Oregon Ash 2" cal. 14,324 SF Fine Lawn 7 RHAMNUS PURSHIANA Cascara 2" cal. 14,324 SF Fine Lawn 2 THUJA PLICATA 6' ht. 11 430 Planting per GWS Wative Shrub		15		2"	cal.	يبلنو	0.40		David Viburnum
5 PINUS SYLVESTRIS Scotch Pine 6' ht. Morning Lig Lavender WATER QUALITY TREES 234 Small Native Shrubs Kelsey Dog Salal Sword Fern Nutka Rose Q 22 ACER CIRCINATUM Vine Maple 5' ht. 934 Groundcover Kinnikinnick Creeping Th Pachysandr Coast Strav I 7 RHAMNUS PURSHIANA Cascora 2" cal. Image: Cal. 14,324 SF Fine Lawn I 2 THUJA PLICATA 6' ht. Image: Cal.		4		6' I	ht.	*** ● ⊙ *****	249	Perennials/Grasses	Evergold Sedge Ferns Hosta
WATER QUALITY TREES Shrubs Salal Image: Constraint of the state of	<pre> { * } </pre>	5	PINUS SYLVESTRIS Scotch Pine	6' I	ht.				Morning Light Mi
 ACER CIRCINATION Vine Maple 13 FRAXINUS LATIFOLIA Oregon Ash 7 RHAMNUS PURSHIANA 2" cal. 7 RHAMNUS PURSHIANA 2" cal. 2 THUJA PLICATA 6 ht. 6 ht. 220 Stormwater Facility Native Shru Wetland Planting per CWS Wetland Planting per CWS 	₩,	ATER G	QUALITY TREES				234		Kelsey Dogwood Salal Sword Fern
13 FRAXINUS LATIFOLIA Oregon Ash 2" cal. Creeping Th Pachysandr Coast Strav 14,324 SF Fine Lawn	$\textcircled{\bullet}$	22		5' I	ht.				Nutka Rose
7RHAMNUS PURSHIANA Cascara2" cal.2"2THUJA PLICATA6' ht.220Stormwater Facility Planting per CWSNative Shru Wetland Planting Planting	$\left\langle \right\rangle$	13		2"	cal.		934	Groundcover	Kinnikinnick Creeping Thyme Pachysandra Coast Strawberry
\leftarrow 2 IHUJA PLICATA 6 ht. $\frac{1}{2}$ 11.430 Planting per CWS Wetland Pla	(index)	7		2"	cal.		14,324 SF	Fine Lawn	
	$\overline{\mathfrak{A}}$	2		6' I	ht.				Native Shrubs Wetland Plants

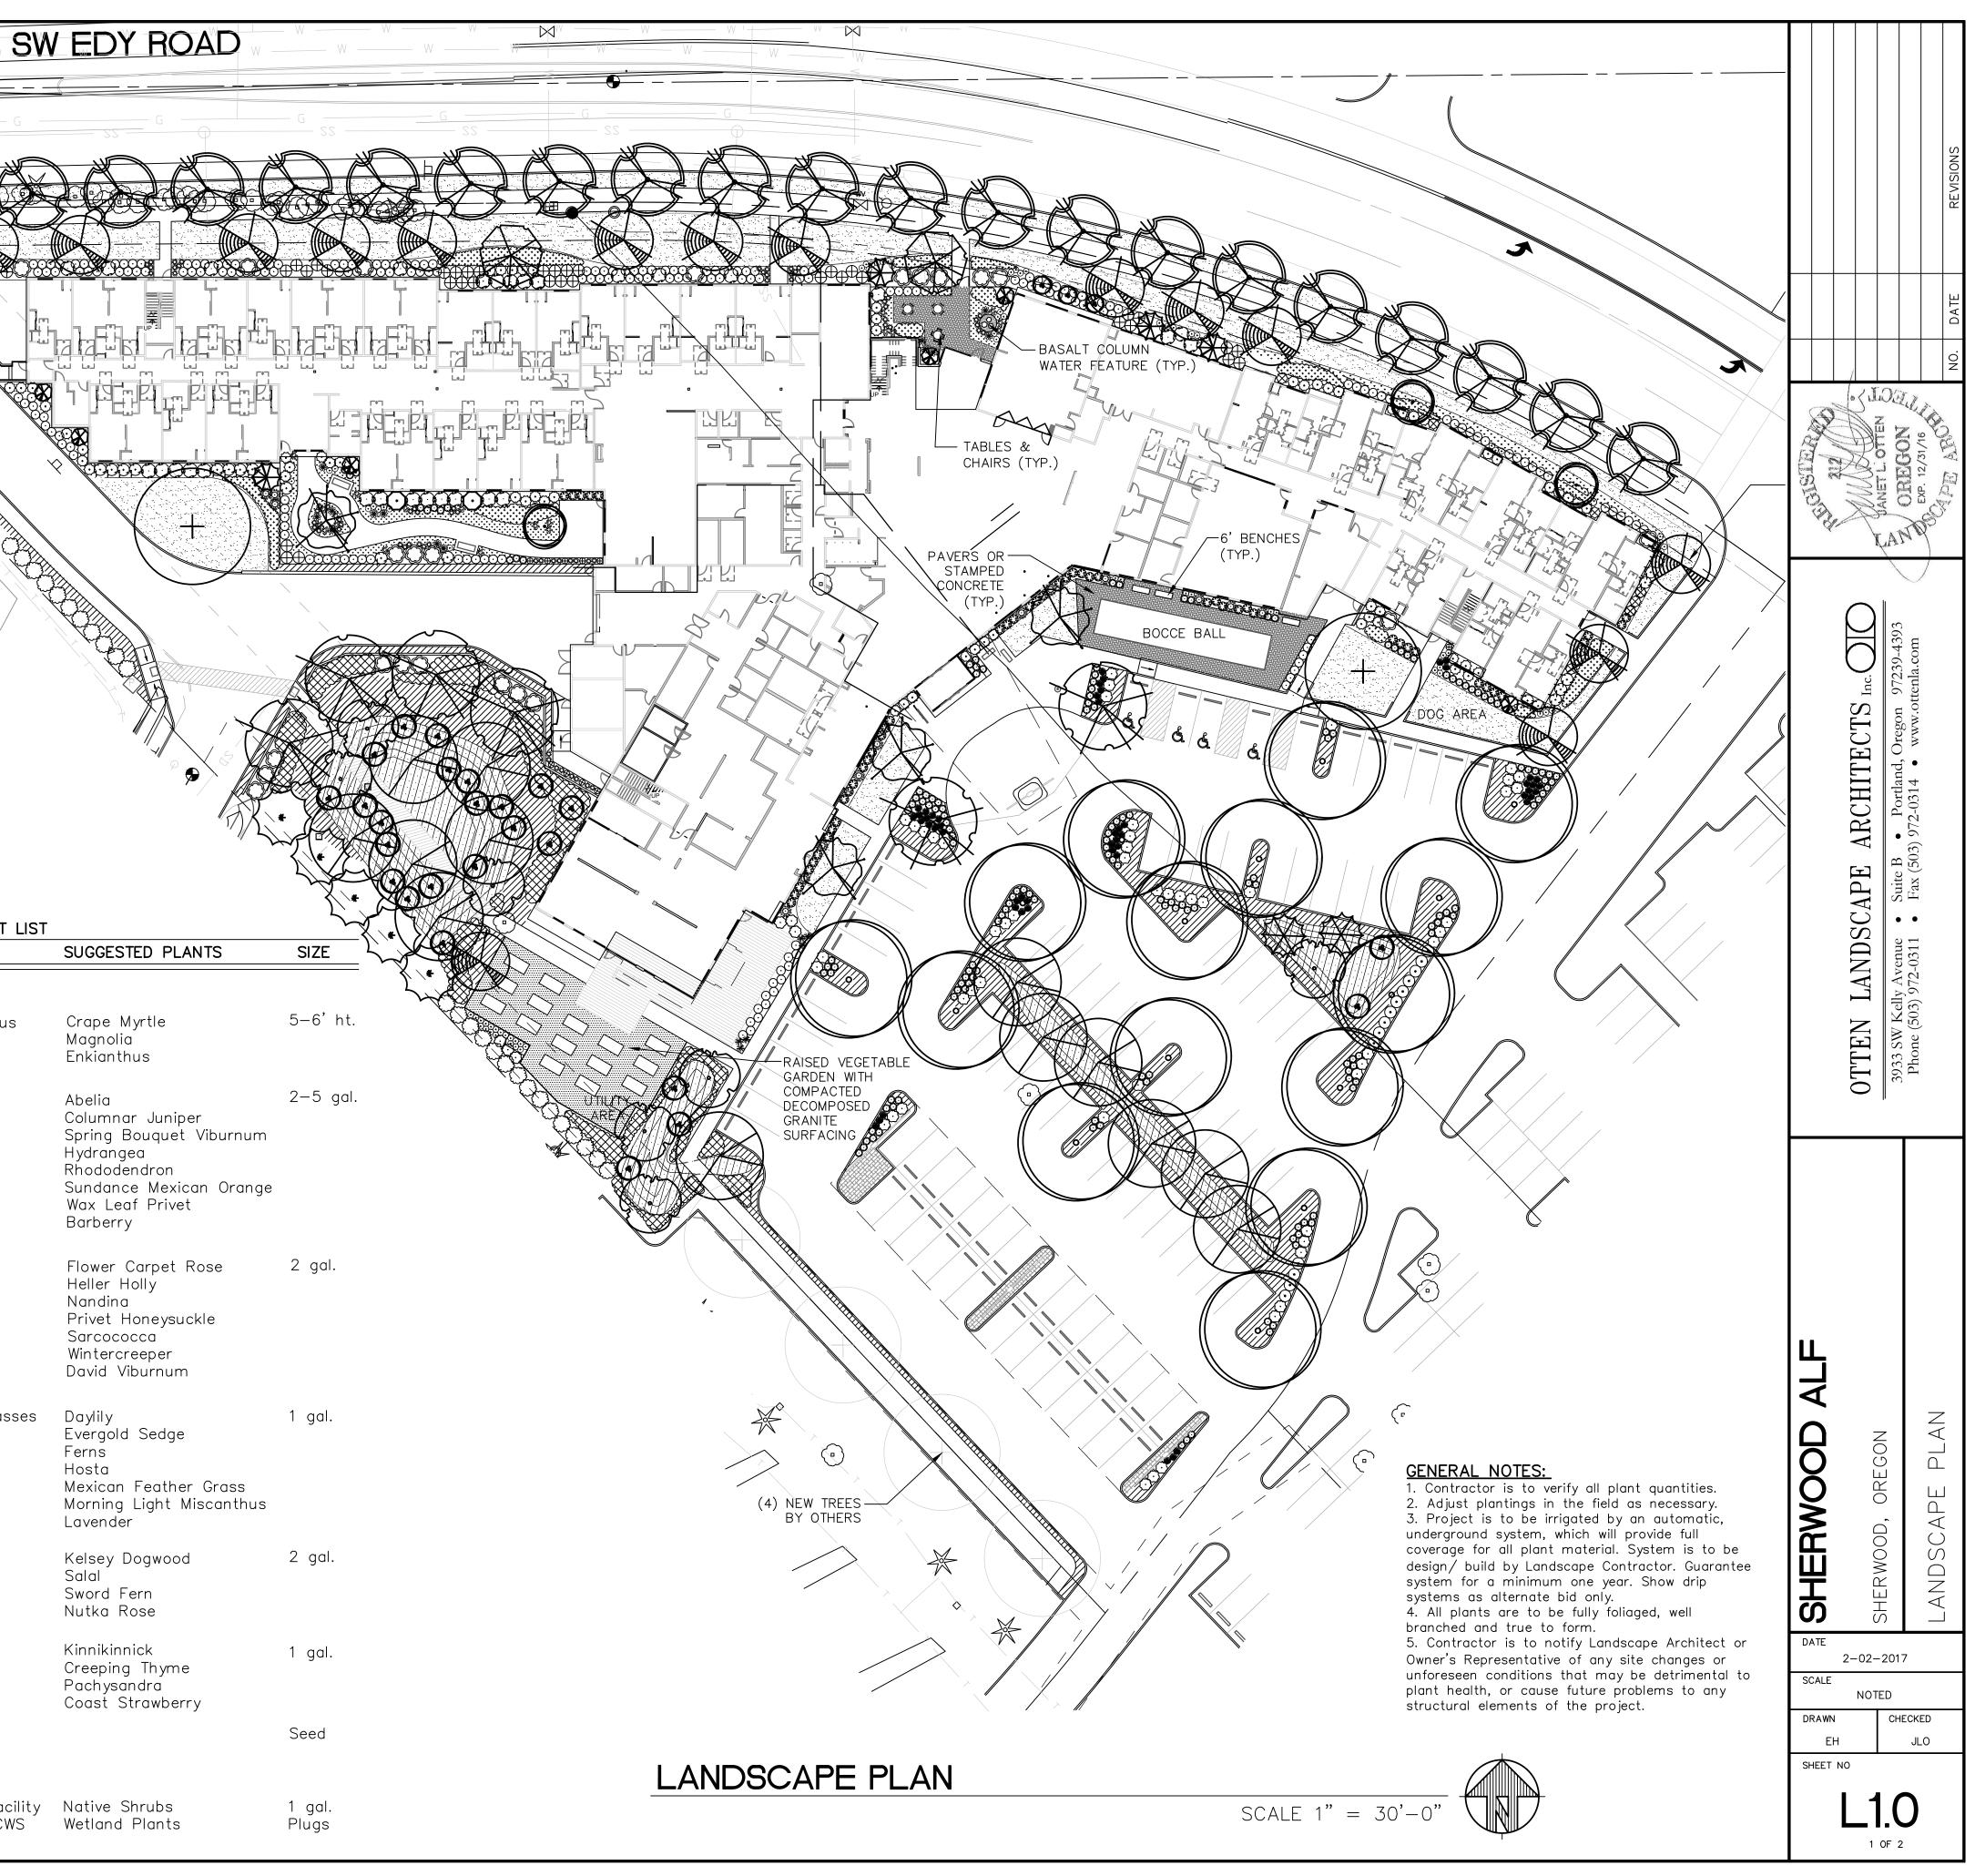

OUTLINE SPECIFICATIONS PLANTING AND SEEDING:

GENERAL: All plants shall conform to all applicable standards of the latest edition of the "American Association of Nurserymen Standards", A.N.S.I. Z60.1 - 1973. Meet or exceed the regulations and laws of Federal, State, and County regulations, regarding the inspection of plant materials, certified as free from hazardous insects, disease, and noxious weeds, and certified fit for sale in Oregon.

The apparent silence of the Specifications and Plans as to any detail, or the apparent omission from them of a detailed description concerning any point, shall be regarded as meaning that only the best general practice is to prevail and that only material and workmanship of first quality are to be used. All interpretations of these Specifications shall be made upon the basis above stated.

Landscape contractor shall perform a site visit prior to bidding to view existing conditions.

PERFORMANCE QUALITY ASSURANCE: Use adequate numbers of skilled workmen who are thoroughly trained and experienced in the necessary horticultural practices and who are completely familiar with the specified requirements and methods needed for the proper performance of the work of this section.

NOTIFICATION: Give Landscape Architect minimum of 2 days advance notice of times for inspections. Inspections at growing site does not preclude Landscape Architect's right of rejection of deficient materials at project site. Each plant failing to meet the above mentioned "Standards" or otherwise failing to meet the specified requirements as set forth shall be rejected and removed immediately from the premises by the Contractor and at his expense, and replaced with satisfactory plants or trees conforming to the specified requirements.

SUBSTITUTIONS: Only as approved by the Landscape Architect or the Owner's Representative.

GUARANTEE AND REPLACEMENT: All plant material shall be guaranteed from final acceptance for one full growing season or one year, whichever is longer. During this period the Contractor shall replace any plant material that is not in good condition and producing new growth (except that material damaged by severe weather conditions, due to Owner's negligence, normally unforeseen peculiarities of the planting site, or lost due to vandalism). Guarantee to replace, at no cost to Owner, unacceptable plant materials with plants of same variety, age, size and quality as plant originally specified. Conditions of guarantee on replacement plant shall be same as for original plant.

Landscape Contractor shall keep on site for Owner's Representative's inspection, all receipts for soil amendment and topsoil deliveries.

PROTECTION: Protect existing roads, sidewalks, and curbs, landscaping, and other features remaining as final work. Verify location of underground utilities prior to doing work. Repair and make good any damage to service lines, existing features, etc. caused by landscaping installation.

PLANT QUALITY ASSURANCE: Deliver direct from nursery. Maintain and protect roots of plant material from drying or other possible injury. Store plants in shade and protect them from weather immediately upon delivery, if not to be planted within four hours.

Nursery stock shall be healthy, well branched and rooted, formed true to variety and species, full foliaged, free of disease, injury, defects, insects, weeds, and weed roots. Trees shall have straight trunks, symmetrical tips, and have an intact single leader. Any trees with double leaders will be rejected upon inspection. All Plants: True to name, with one of each bundle or lot tagged with the common and botanical name and size of the plants in accordance with standards of practice of the American Association of Nurserymen, and shall conform to the Standardized Plant Names, 1942 Edition.

Container grown stock: Small container-grown plants, furnished in removable containers, shall be well rooted to ensure healthy growth. Grow container plants in containers a minimum of one year prior to delivery, with roots filling container but not root bound. Bare root stock: Roots well-branched and fibrous. Balled and burlapped (B&B): Ball shall be of natural size to ensure healthy growth. Ball shall be firm and the burlap sound. No loose or made ball will be acceptable.

TOPSOIL AND FINAL GRADES: Landscape Contractor is to verify with the General Contractor if the on site topsoil is or is not conducive to proper plant growth. Supply alternate bid for imported topsoil.

Landscape Contractor is to supply and place 12" of topsoil in planting beds and 6" in lawn areas. If topsoil stockpiled on site is not conducive to proper plant growth, the Landscape Contractor shall import the required amount. Landscape Contractor is to submit samples of the imported soil and/or soil amendments to the Landscape Architect. The topsoil shall be a sandy loam, free of all weeds and debris inimical to lawn or plant growth.

Landscaping shall include finished grades and even distribution of topsoil to meet planting requirements. Grades and slopes shall be as indicated. Planting bed grades shall be approximately 3" below adjacent walks, paving, finished grade lines, etc., to allow for bark application. Finish grading shall remove all depressions or low areas to provide positive drainage throughout the area.

PLANTING SPECIFICATIONS:

HERBICIDES: Prior to soil preparation, all areas showing any undesirable weed or grass growth shall be treated with Round-up in strict accordance with the manufacturer's instructions.

SOIL PREPARATION: Work all areas by rototilling to a minimum depth of 8". Remove all stones (over 1½" size), sticks, mortar, large clumps of vegetation, roots, debris, or extraneous matter turned up in working. Soil shall be of a homogeneous fine texture. Level, smooth and lightly compact area to plus or minus .10 of required grades.

In groundcover areas add 2" of compost (or as approved) and till in to the top 6" of soil.

PLANTING HOLE: Lay out all plant locations and excavate all soils from planting holes to 2 1/2 times the root ball or root system width. Loosen soil inside bottom of plant hole. Dispose of any "subsoil" or debris from excavation. Check drainage of planting hole with water, and adjust any area showing drainage problems.

SOIL MIX: Prepare soil mix in each planting hole by mixing: 2 part native topsoil (no subsoil) 1 part compost (as approved)

Thoroughly mix in planting hole and add fertilizers at the following rates: Small shrubs - 1/8 lb./ plant Shrubs - 1/3 to 1/2 lb./ plant Trees - 1/3 to 1 lb./ plant

FERTILIZER: For trees and shrubs use Commercial Fertilizer "A" Inorganic (5-4-3) with micro-nutrients and 50% slow releasing nitrogen. For initial application in fine seed lawn areas use Commercial Fertilizer "B" (8-16-8) with micro-nutrients and 50% slow-releasing nitrogen. For lawn maintenance use Commercial Fertilizer "C" (22-16-8) with micro-nutrients and 50% slow-releasing nitrogen. DO NOT apply fertilizer to Water Quality Swale.

PLANTING TREES AND SHRUBS: Plant upright and face to give best appearance or relationship to adjacent plants and structures. Place 6" minimum, lightly compacted layer of prepared planting soil under root system. Loosen and remove twine binding and burlap from top 1/2 of root balls. Cut off cleanly all broken or frayed roots, and spread roots out. Stagger Plants in rows. Backfill planting hole with soil mix while working each layer to eliminate voids.

When approximately 2/3 full, water thoroughly, then allow water to soak away. Place remaining backfill and dish surface around plant to hold water. Final grade should keep root ball slightly above surrounding grade, not to exceed 1". Water again until no more water is absorbed. Initial watering by irrigation system is not allowed.

STAKING OF TREES: Stake or guy all trees. Stakes shall be 2" X 2" (nom.) quality tree stakes with point. They shall be of Douglas Fir, clear and sturdy. Stake to be minimum 2/3 the height of the tree, not to exceed 8'-0". Drive stake firmly 1'-6" below the planting hole. Tree ties for deciduous trees shall be "Chainlock" (or better). For Evergreen trees use "Gro-Strait" Tree Ties (or a reinforced rubber hose and guy wires) with guy wires of a minimum 2 strand twisted 12 ga. wire. Staking and guying shall be loose enough to allow movement of tree while holding tree upright.

MULCHING OF PLANTINGS: Mulch planting areas with dark, aged, medium grind fir or hemlock bark (aged at least 6 months) to a depth of 2" in ground cover areas and 2½" in shrub beds. Apply evenly, not higher than grade of plant as it came from the nursery, and rake to a smooth finish. Water thoroughly, then hose down planting area with fine spray to wash leaves of plants.

FINE LAWN AREAS: In fine lawn area apply Commercial Fertilizer Mix "B" at 4.5 lbs. Per 1,000 sq.ft. and rake into soil surface. Establish an even, fine textured seedbed meeting grades, surfaces and texture. Sow seed with a mechanical spreader at the uniform rates as noted below. Rake seed lightly to provide cover.

SEED: Bluetag grass seed conforming to applicable State laws. No noxious weed seeds. Submit Guaranteed analysis.


Fine Lawn Seed Mix: To contain 50% Top Hat Perennial Ryegrass, 30% Derby Supreme Ryegrass, 20% Longfellow Chewings Fescue (Hobbs and Hopkins Pro-Time 303 Lawn Mix or as approved) Sow Seed at 5 lbs. / 1000 sq. ft.


MAINTENANCE OF SEEDED AREAS:


Fine Lawn Areas: The lawn areas shall be maintained by watering, mowing, reseeding, and weeding for a minimum of 60 days after seeding. After 30 days, or after the second mowing, apply Commercial Fertilizer Mix "C" at 5 lbs. per 1,000 sq. ft. Mow and keep at 1½" to 2" in height. Remove clippings and dispose of off site.


GENERAL MAINTENANCE: Protect and maintain work described in these specifications against all defects of materials and workmanship, through final acceptance. Replace plants not in normal healthy condition at the end of this period. Water, weed, cultivate, mulch, reset plants to proper grade or upright position, remove dead wood and do necessary standard maintenance operations. Irrigate when necessary to avoid drying out of plant materials, and to promote healthy growth.


CLEAN-UP: At completion of each division of work all extra material, supplies, equipment, etc., shall be removed from the site. All walks, paving, or other surfaces shall be swept clean, mulch areas shall have debris removed and any soil cleared from surface. All areas of the project shall be kept clean, orderly and complete.

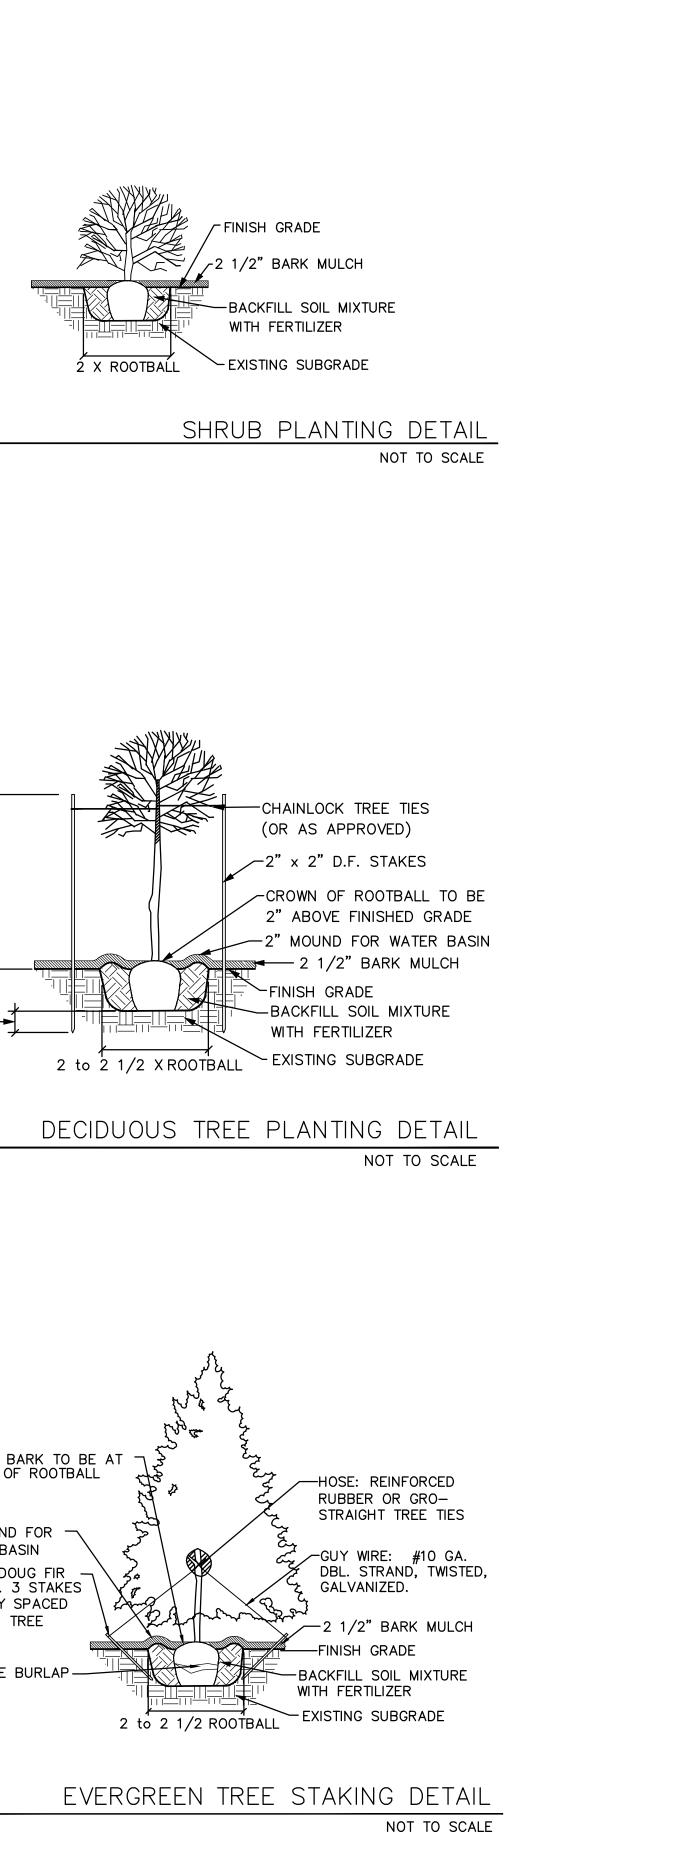

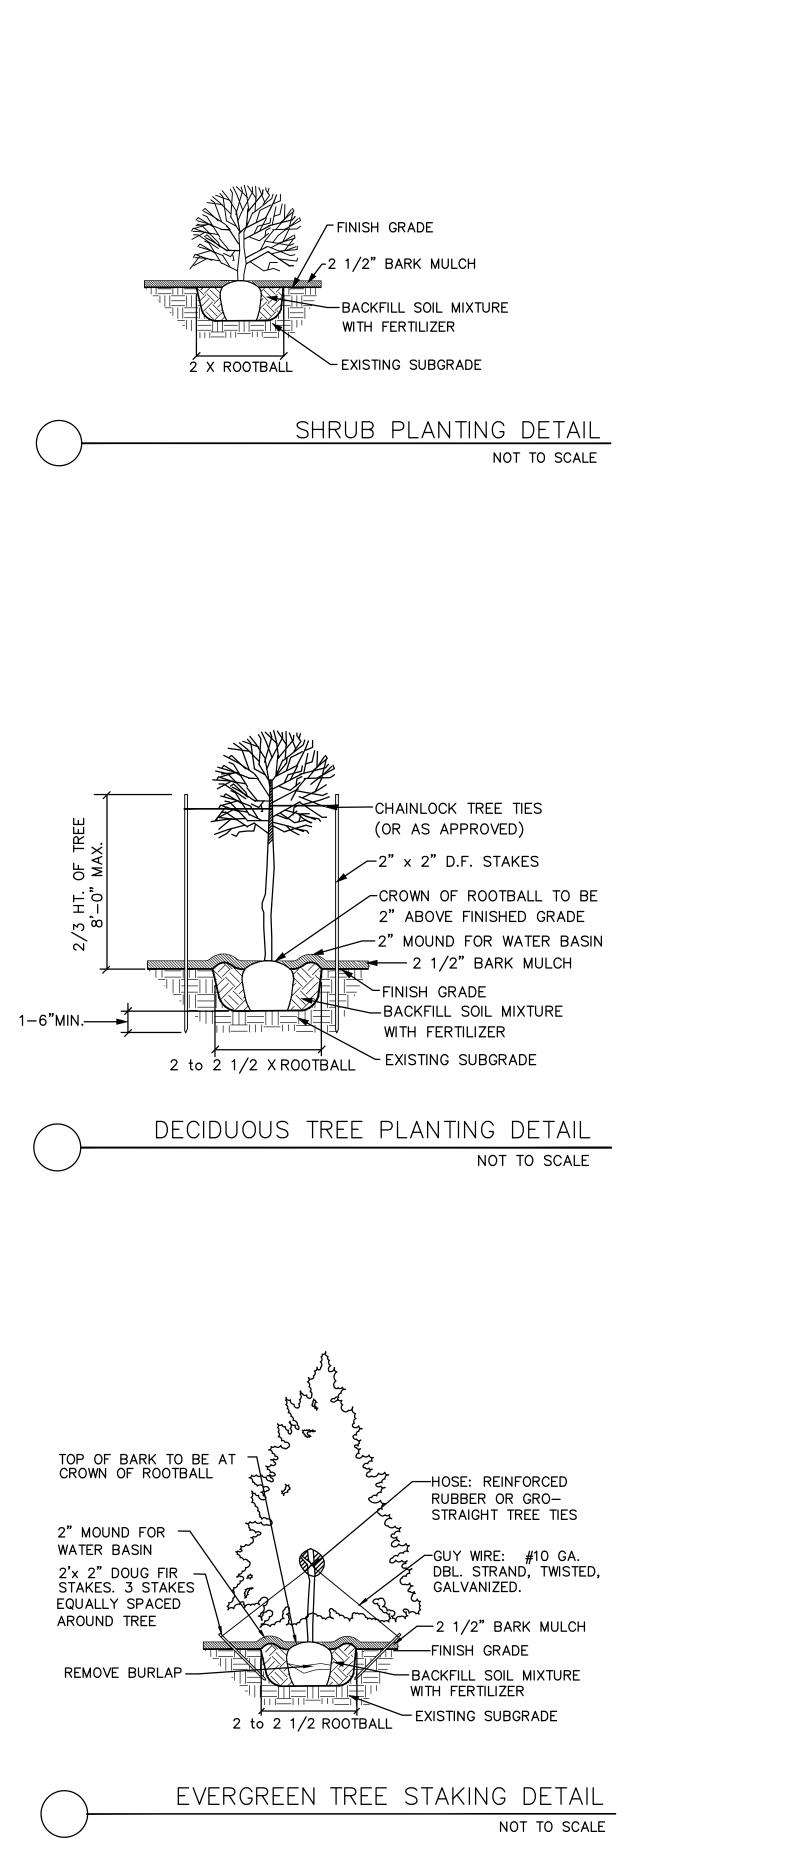

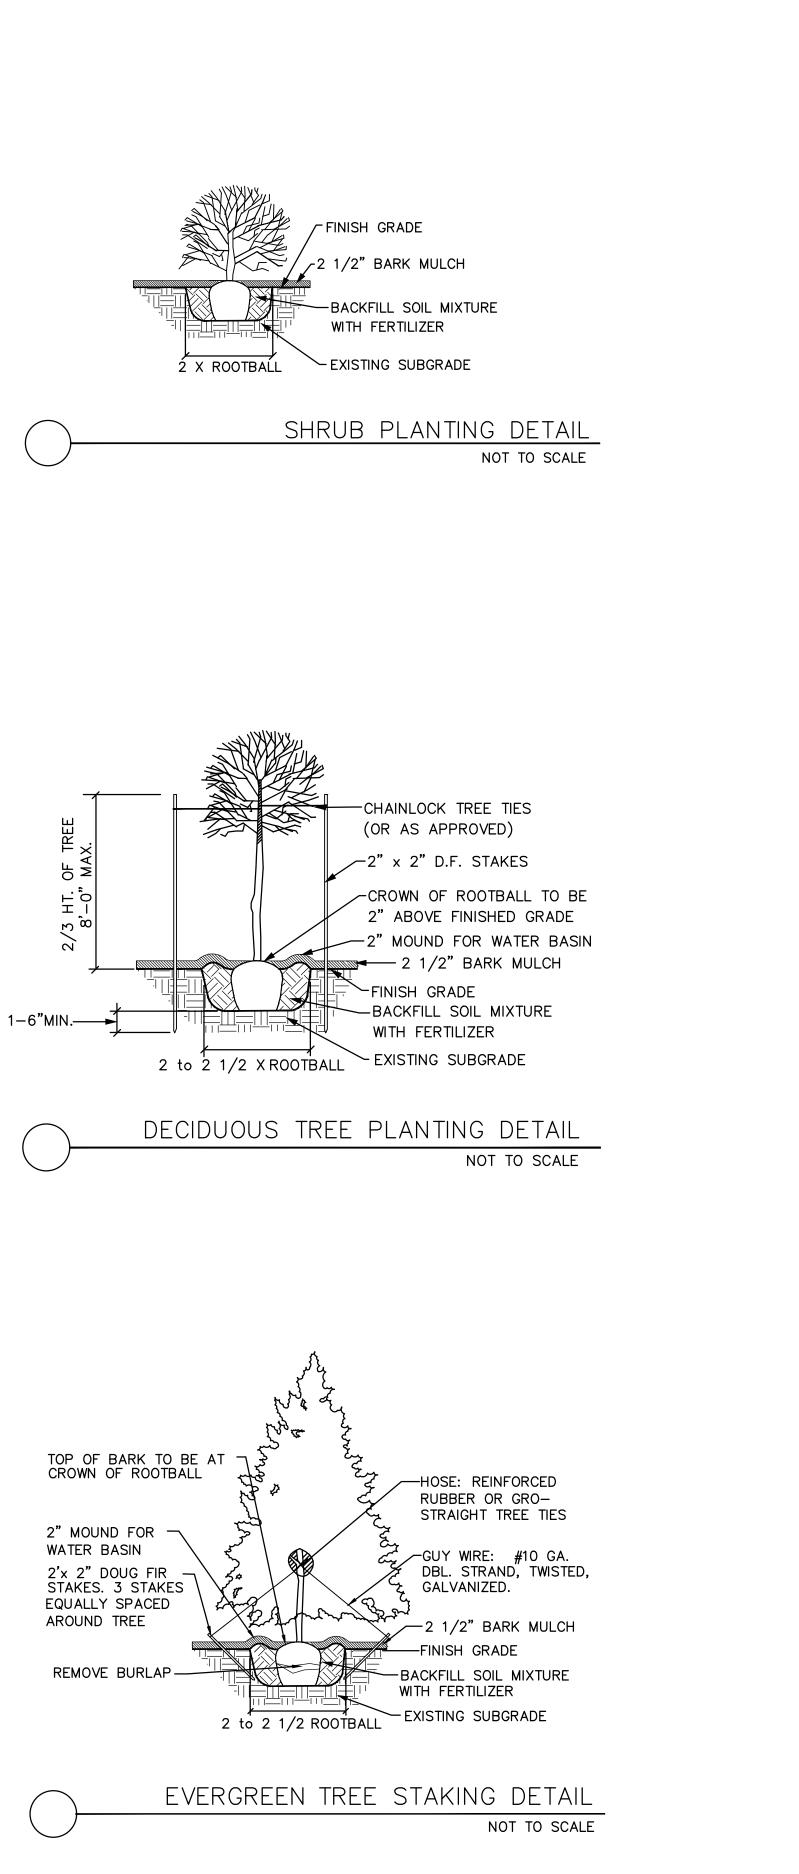

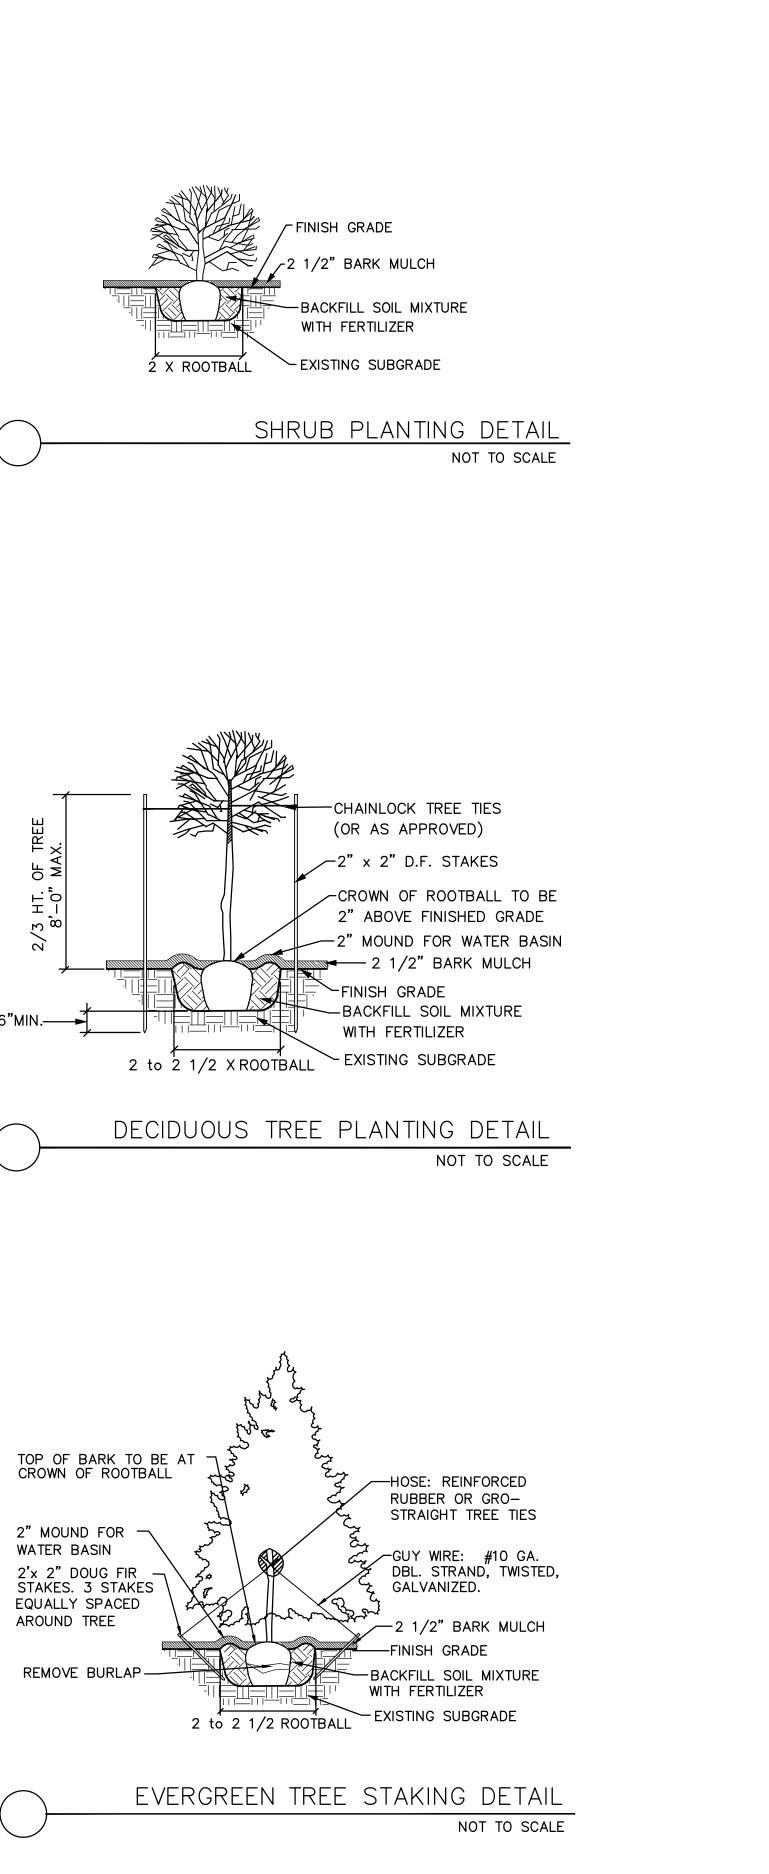

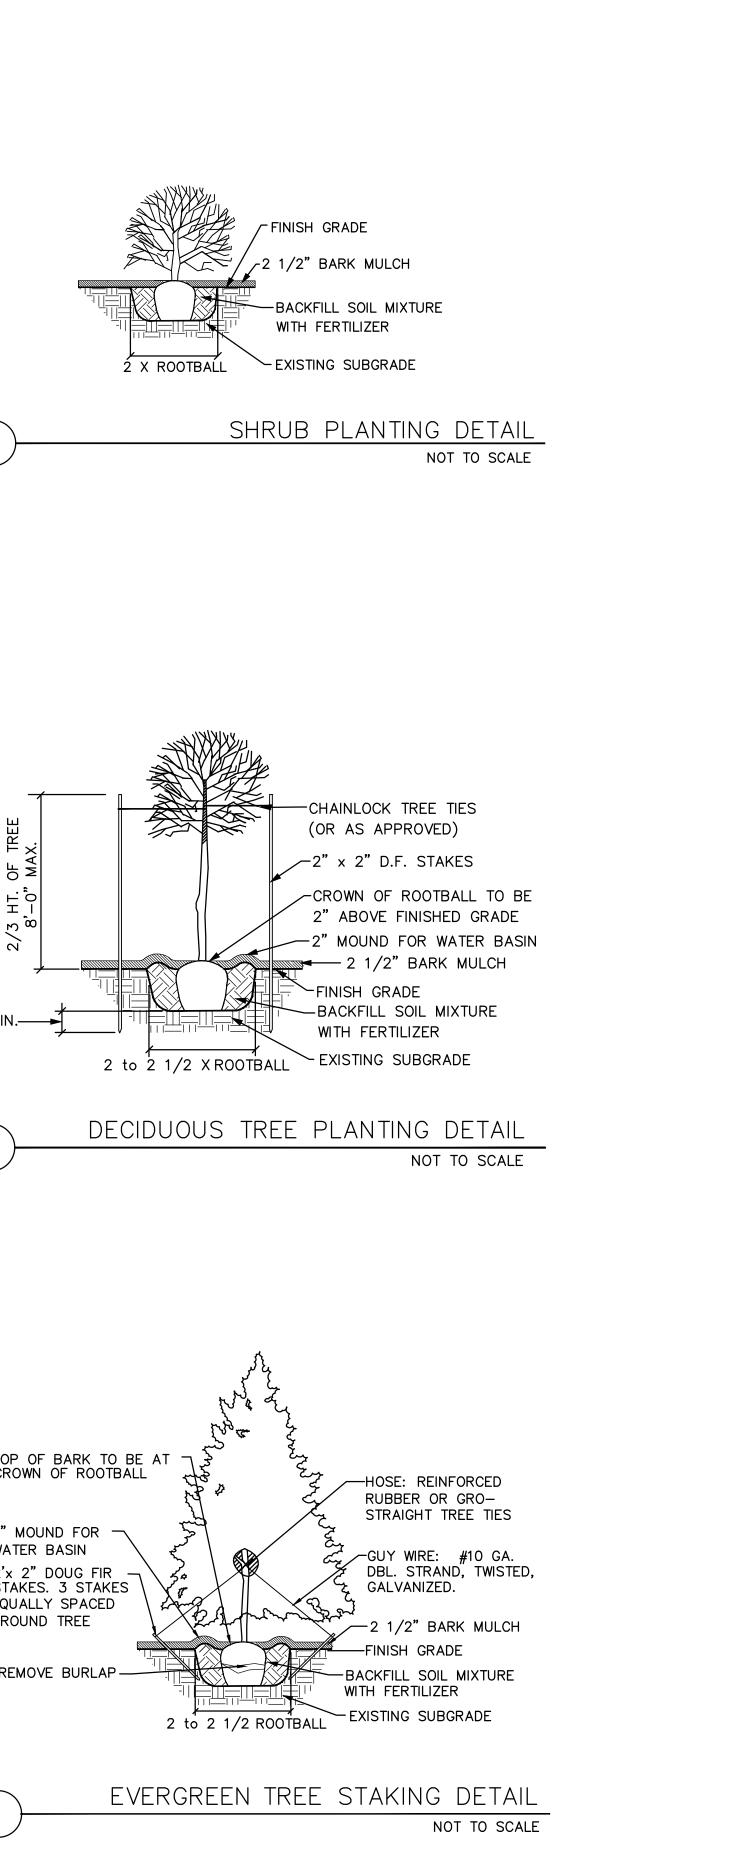

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