CITY OF SHERWOOD FIRST STREET PARKING LOT 2017

PROJECT LOCATION:

TAXLOT 2800 AND 3000 BETWEEN SW OAK ST AND PINE ST IN SHERWOOD, OREGON

PROJECT OWNER:


CITY OF SHERWOOD — ENGINEERING
22560 SW PINE ST SHERWOOD, OREGON 97140
CONTACT: BOB GALATI
PH. 503—925—2303
GALATIB@SHERWOODOREGON.GOV

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THIS DESIGN COMPLIES WITH ORS 92.044 (7) IN THAT NO UTILITY INFRASTRUCTURE IS DESIGNED TO BE WITHIN ONE (1) FOOT OF A SURVEY MONUMENT LOCATION SHOWN ON A SUBDIVISION OR PARTITION PLAT. NO DESIGN EXCEPTIONS NOR FINAL FIELD LOCATION CHANGES SHALL BE PERMITTED IF THAT CHANGE WOULD CAUSE ANY UTILITY INFRASTRUCTURE TO BE PLACED WITHIN THE PROHIBITED AREA.

ATTENTION EXCAVATORS: OREGON LAW REQUIRES YOU TO FOLLOW RULES ADOPTED BY THE OREGON UTILITY NOTIFICATION CENTER. THOSE RULES ARE SET FORTH IN OAR 952-011-0010 THROUGH OAR 952-001-0090. YOU MAY OBTAIN COPIES OF THESE RULES FROM THE CENTER BY CALLING (503) 232-1987. IF YOU HAVE ANY QUESTIONS ABOUT THE RULES, YOU MAY CONTACT THE CENTER. YOU MUST NOTIFY THE CENTER AT LEAST 2 BUSINESS DAYS, BEFORE COMMENCING ANY EXCAVATION. CALL (503) 246-6699.



MCINITY MAP NOT TO SCALE

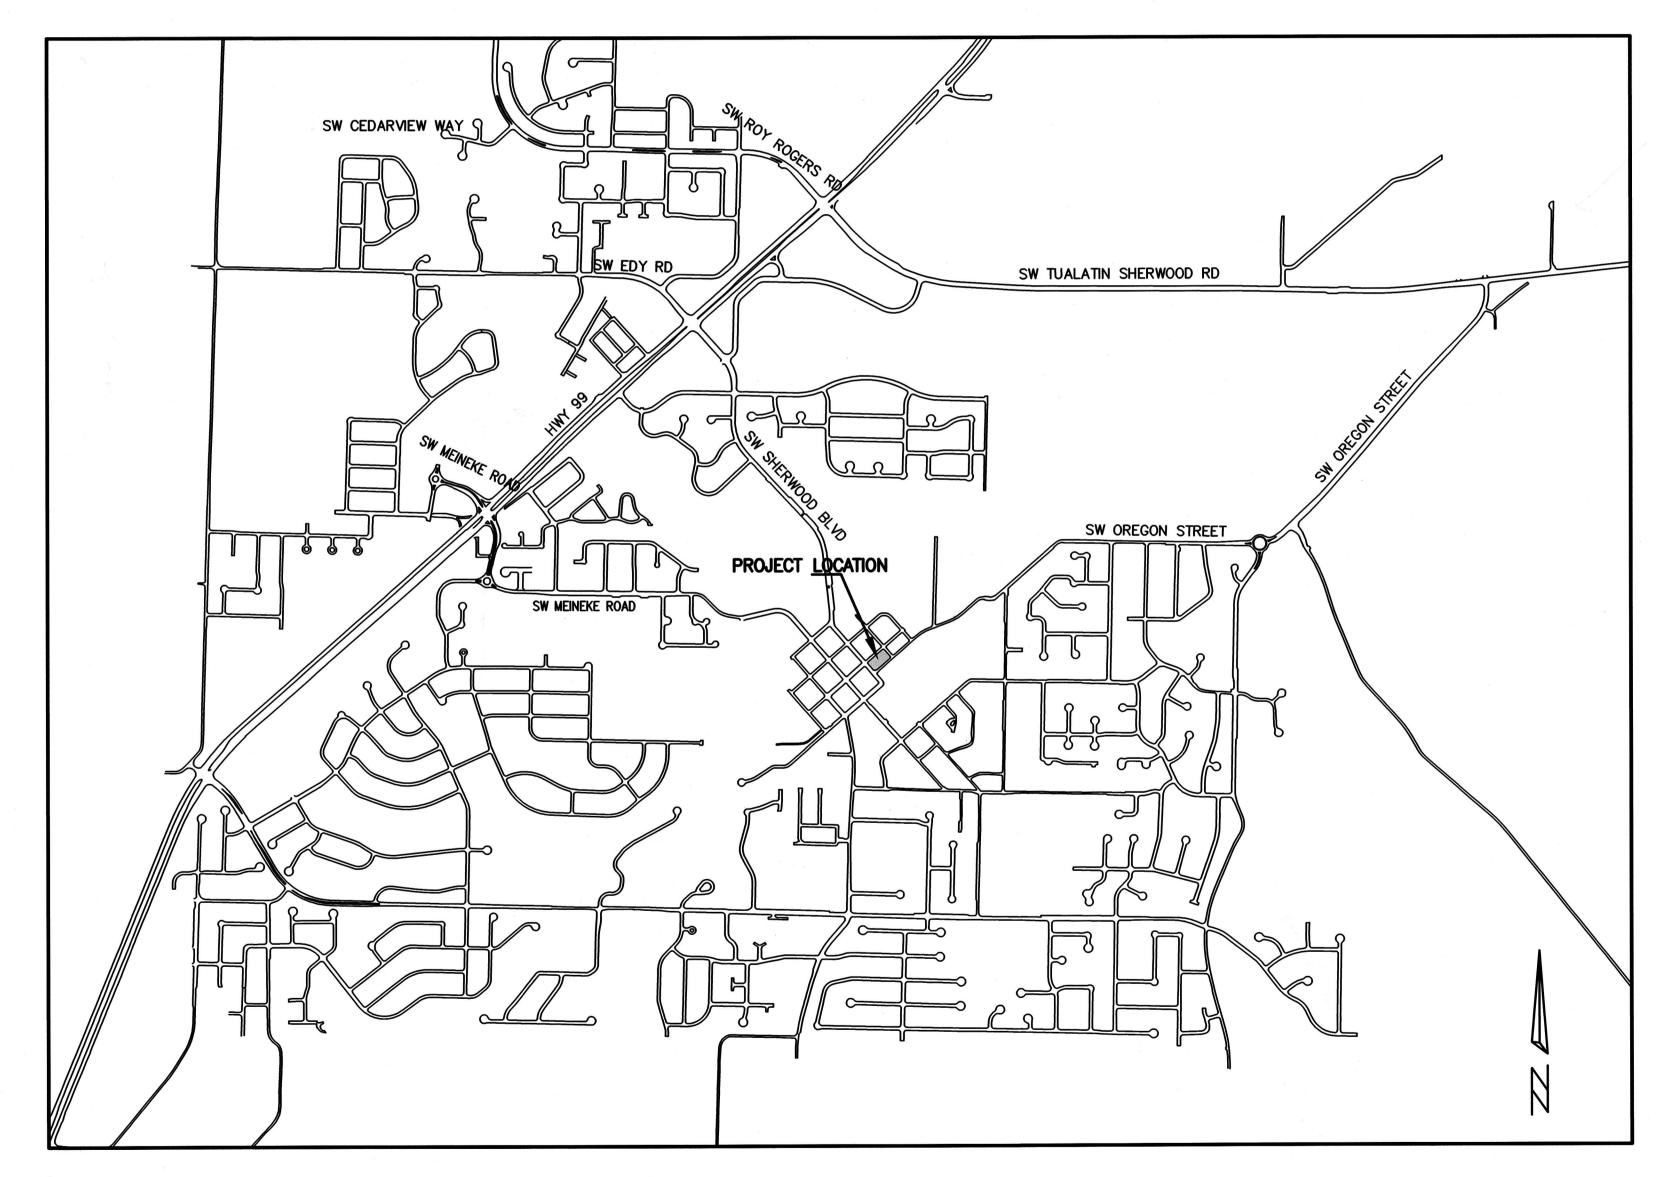INPSECTOR INFORMATION:

CITY OF SHERWOOD: ANDY STIRLING (503) 925-2307 CONTACT INSPECTOR 48 HOURS PRIOR TO CONSTRUCTION.

SURVEY INFORMATION:

- 1. VERTICAL DATUM: ELEVATIONS ARE BASED ON A 2" DIAMETER BRASS CAP MARKED "NO. 1, 1988", IN A MONUMENT BOX NEAR THE SOUTH EDGE OF PAVEMENT OF HIGHWAY 99 WEST, 300 FEET± SOUTHWEST OF SIX CORNERS, WITH AN NGVD 29 ELEVATION OF 210.10 FEET.
- 2. A LOCAL DATUM PLANE SCALED FROM OREGON STATE PLANE NORTH 3601 NAD83 (1991) BY HOLDING A PROJECT MEAN GROUND COMBINED SCALE FACTOR OF 1.0001057061 AT A CALCULATED CENTRAL PROJECT POINT WITH INTERNATIONAL FOOT GRID VALUES OF (N 625072.855, E 7600461.855). THE CONVERGENCE ANGLE BETWEEN GRID NORTH AND GEODETIC NORTH AT THE CALCULATED CENTRAL POINT IS -1*39*37". THE STATE PLANE COORDINATES WERE ESTABLISHED BY GPS OBSERVATIONS AND HOLDING THE NAD83 (1991) CONTROL VALUES PER WASHINGTON COUNTY HORIZONTAL CONTROL DATA SHEETS GC31-119A AND GC31-115A.

IRST STREET PARKING

EET PARKING LOT

S DEP ARTMENT
PINE STREET
OREGON 97140

1) 925–2309
C 625–0629

E-MAIL: engineering@sherwoo

RECON
S2196PE
52196PE
52196PE
727, 2017

DESIGNED BY: AGS
DRAWN BY: AGS
CHECKED BY: RJG
FULL SIZE SCALE: 1"=

REVISIONS
Sheets_8089.dwg

202

SHEET NO.

GENERAL NOTES

- 1. ALL WORK AND MATERIALS INSIDE OF THE PUBLIC RIGHT-OF-WAY SHALL CONFORM TO THE CLEAN WATER SERVICES DESIGN AND CONSTRUCTION STANDARDS R&O 07-20 AND THE CITY OF SHERWOOD CONSTRUCTION STANDARDS MANUAL, LATEST VERSION.
- 2. THE CONTRACTOR SHALL OBTAIN ALL REQUIRED PERMITS AND LICENSES BEFORE STARTING CONSTRUCTION. A COPY OF THE REQUIRED PERMITS AND ATTACHMENTS SHALL BE AT THE WORK SITE AND AVAILABLE DURING CONSTRUCTION.
- 3. IT SHALL BE THE RESPONSIBILITY OF THE CONTRACTOR TO VERIFY ALL UTILITY LOCATIONS PRIOR TO CONSTRUCTION AND ARRANGE FOR THE RELOCATION OF ANY IN CONFLICT WITH THE PROPOSED CONSTRUCTION. THE LOCATIONS, DEPTHS, AND DESCRIPTIONS OF EXISTING UTILITIES SHOWN WERE COMPILED FROM AVAILABLE RECORDS AND/OR FIELD SURVEYS. THE ENGINEER OR UTILITY COMPANIES DO NOT GUARANTEE THE ACCURACY OR THE COMPLETENESS OF SUCH RECORDS. ADDITIONAL UTILITIES MAY EXIST WITHIN THE WORK AREA.
- 4. OREGON LAW REQUIRES THAT THE RULES ADOPTED BY OREGON UTILITY NOTIFICATION CENTER BE FOLLOWED. THOSE RULES ARE SET FORTH IN OAR 952-001-0090. YOU MAY OBTAIN COPIES OF THE RULES BY CALLING THE CENTER OR ACCESSING VIA INTERNET AT WWW.STATE.OR.US/GOVERNME.HTM. CALL BEFORE YOU DIG - PORTLAND METRO AREA 503-246-6699.
- 5. THE CONTRACTOR SHALL MAKE PROVISIONS TO KEEP ALL EXISTING UTILITIES IN SERVICE AND PROTECT THEM DURING CONSTRUCTION. CONTRACTOR SHALL IMMEDIATELY REPAIR OR REPLACE ANY DAMAGED UTILITIES USING MATERIALS AND METHODS APPROVED BY THE UTILITY OWNER. NO SERVICE INTERRUPTIONS SHALL BE PERMITTED WITHOUT PRIOR WRITTEN AGREEMENT WITH THE UTILITY PROVIDER.
- 6. ALL WATER LINE CROSSINGS SHALL BE IN CONFORMANCE WITH OAR CHAPTER 333, CITY OF SHERWOOD STANDARDS AND THE OREGON STATE HEALTH DIVISION.
- THE CONTRACTOR SHALL NOTIFY THE PROJECT ENGINEER, AND THE CITY OF SHERWOOD 48 HOURS IN ADVANCE OF STARTING CONSTRUCTION AND 24 HOURS BEFORE RESUMING WORK AFTER SHUTDOWNS, EXCEPT FOR NORMAL RESUMPTION OF WORK FOLLOWING SATURDAYS, SUNDAYS, OR HOLIDAYS.
- THE CONTRACTOR SHALL KEEP AN APPROVED SET OF PLANS ON THE PROJECT SITE AT ALL TIMES.
- 9. THE CONTRACTOR SHALL PERFORM ALL WORK NECESSARY TO COMPLETE THIS PROJECT IN ACCORDANCE WITH THE PLANS AND SPECIFICATIONS INCLUDING SUCH INCIDENTALS, AS MAY BE NECESSARY TO MEET THE INTENT OF THE PROJECT CONTRACT DOCUMENTS, APPLICABLE AGENCY REQUIREMENTS, AND OTHER WORK AS NECESSARY TO PROVIDE A COMPLETE PROJECT.
- 10. THE CONTRACTOR SHALL PROVIDE EFFECTIVE EROSION PROTECTION TO INCLUDE, BUT NOT LIMITED TO, GRADING, DITCHING, HAY BALES, SILT FENCING, AND SEDIMENT BARRIERS TO MINIMIZE EROSION AND IMPACT TO ADJACENT PROPERTY. SEE EROSION AND SEDIMENT CONTROL NOTES AND PLAN.
- 11. OPEN TRENCHES SHALL BE STRICTLY LIMITED TO A MAXIMUM OF 300 LINEAR FEET WITHIN STREET RIGHT-OF-WAYS UNLESS LIMITED TO A LESSER AMOUNT BY PERMIT. NO TRENCHES WILL BE ALLOWED TO REMAIN OPEN OVERNIGHT. ALL TRENCHES SHALL BE COVERED WITH STEEL PLATES OR FILLED IN AT NIGHT. FLASHING AND REFLECTORIZED BARRICADES SHALL BE IN ACCORDANCE WITH MUTCD REQUIREMENTS.
- 12. ANY AREA OF CUT OR DAMAGED ASPHALT SHALL BE RESTORED IN ACCORDANCE WITH THE SHERWOOD
- 13. THE CONTRACTOR SHALL REPLACE ANY LANDSCAPE VEGETATION OR FENCES THAT ARE DESTROYED. ANY DAMAGE THAT IS NOT FULLY RECOVERED WITHIN 30 DAYS (WEATHER PERMITTED) SHALL BE REPLACED BY THE CITY AT THE EXPENSE OF THE CONTRACTOR.

<u>ADDITIONAL NOTES</u>

- 1. ANY INSPECTION BY THE CITY, COUNTY, STATE, OR FEDERAL AGENCIES OR THE PROJECT ENGINEER SHALL NOT, IN ANY WAY, RELIEVE THE CONTRACTOR FROM ANY OBLIGATION TO PERFORM THE WORK IN COMPLIANCE WITH THE APPLICABLE CODES, REGULATIONS, CITY STANDARDS, AND PROJECT CONTRACT DOCUMENTS.
- 2. THE PROJECT ENGINEER RESERVES THE RIGHT TO ADJUST GRADES OR ALIGNMENT TO ACCOMMODATE OTHER UTILITIES AS REQUIRED; SUCH ADJUSTMENTS OR REVISIONS SHALL BE REVIEWED AND APPROVED BY THE CITY OF SHERWOOD PRIOR TO COMMENCEMENT OF WORK.
- 3. SAW CUT STRAIGHT MATCH LINES WHERE EXISTING PAVEMENT MEETS NEW PAVEMENT. SAND AND SEAL
- 4. PROPERTY AND RIGHT-OF-WAY LINES SHOWN ARE APPROXIMATE. THIS MAP IS NOT MEANT TO SERVE BOUNDARY SURVEY PURPOSES.
- 5. THE CONTRACTOR IS TO NOTIFY PRIVATE UTILITIES FOR RELOCATION OF POWER POLES, VAULTS, ETC.
- 6. THE CONTRACTOR IS TO COORDINATE WITH UTILITY COMPANIES FOR POWER, TELEPHONE, CABLE, TV, AND GAS. POWER, TELEPHONE, CABLE, AND TV TRENCHING AND CONDUITS TO BE INSTALLED PER UTILITY COMPANY REQUIREMENTS WITH PULL WIRE. VERIFY WITH UTILITY COMPANY FOR SIZE AND TYPE OF CONDUIT PRIOR TO
- 7. EXISTING BURIED UTILITIES, WHICH ARE TO BE ABANDONED, SHOULD BE REMOVED UNLESS NOTED ON THE
- 8. THE PERMIT OR APPROVAL GRANTED HEREBY, OR ANY INSPECTIONS CONDUCTED ON THE SITE HEREAFTER, SHALL NOT BE CONSTRUED AS AUTHORIZING ANY ACTIVITY IN VIOLATION OF ANY APPLICABLE FEDERAL OR STATE LAW OR REGULATION, INCLUDING BUT NOT LIMITED TO THE FEDERAL ENDANGERED SPECIES ACT AND ITS

- 1. TRENCH EXCAVATION SHALL CONFORM TO A.P.W.A., DIVISION III, SECTION 301.1.01, AND SHALL BE CLASSIFIED AS EITHER ROCK OR COMMON EXCAVATION. ALL EXCESS MATERIAL FROM THE TRENCH EXCAVATION SHALL BE DISPOSED OF ON AN APPROVED SITE.
- 2. ON SITE STORM PIPE SHALL BE SMOOTH HIGH DENSITY POLYETHYLENE PIPE CONFORMING TO ASTM D1248 WITH WATERTIGHT GASKETS UNLESS OTHERWISE NOTED.
- 3. ALL PIPE BEDDING AND TRENCH BACKFILL WITHIN PAVED AREAS OR ODOT RIGHT-OF-WAY SHALL BE CLASS B, PER ODOT AND CITY OF SHERWOOD STANDARDS.
- 4. PIPE BEDDING, PIPE ZONE, AND BACKFILL OUTSIDE OF THE PUBLIC RIGHT-OF-WAY SHALL BE CRUSHED ROCK AGGREGATE (3/4"-0") COMPACTED TO 95% OF MAXIMUM DENSITY PER AASHTO T-180.
- 5. SUBSEQUENT SETTLEMENT OF THE FINISHED SURFACE WITHIN THE WARRANTY PERIOD SHALL BE CONSIDERED TO BE A RESULT OF IMPROPER COMPACTION AND SHALL BE PROMPTLY REPAIRED BY THE CONTRACTOR AT NO EXPENSE TO THE OWNER.

WATER NOTES:

- 1. ALL PRIVATE WATER SERVICES SHALL BE TYPE "K" COPPER.
- 2. ALL PIPE SHALL HAVE 36" MINIMUM COVER MEASURED FROM FINISH GRADE.
- 3. IRRIGATION SERVICE SHALL HAVE A STATE APPROVED DOUBLE CHECK VALVE ASSEMBLY INSTALLED PER CITY OF SHERWOOD AND OREGON PLUMBING CODE STANDARDS.
- 4. VALVE OPERATION: NO VALVES SHALL BE OPENED OR CLOSED WITHOUT CITY OF SHERWOOD WATER PERSONNEL ON SITE TO OPERATE THEM.
- 5. UPON COMPLETION OF THE INSTALLATION OF THE WATER SYSTEM, ALL LINES SHALL BE FLUSHED AND DISINFECTED IN CONFORMANCE WITH HEALTH DIVISION GUIDELINES AND CITY OF SHERWOOD REQUIREMENTS. THE CONTRACTOR SHALL TEST THE LINES PER CITY OF SHERWOOD REQUIREMENTS.


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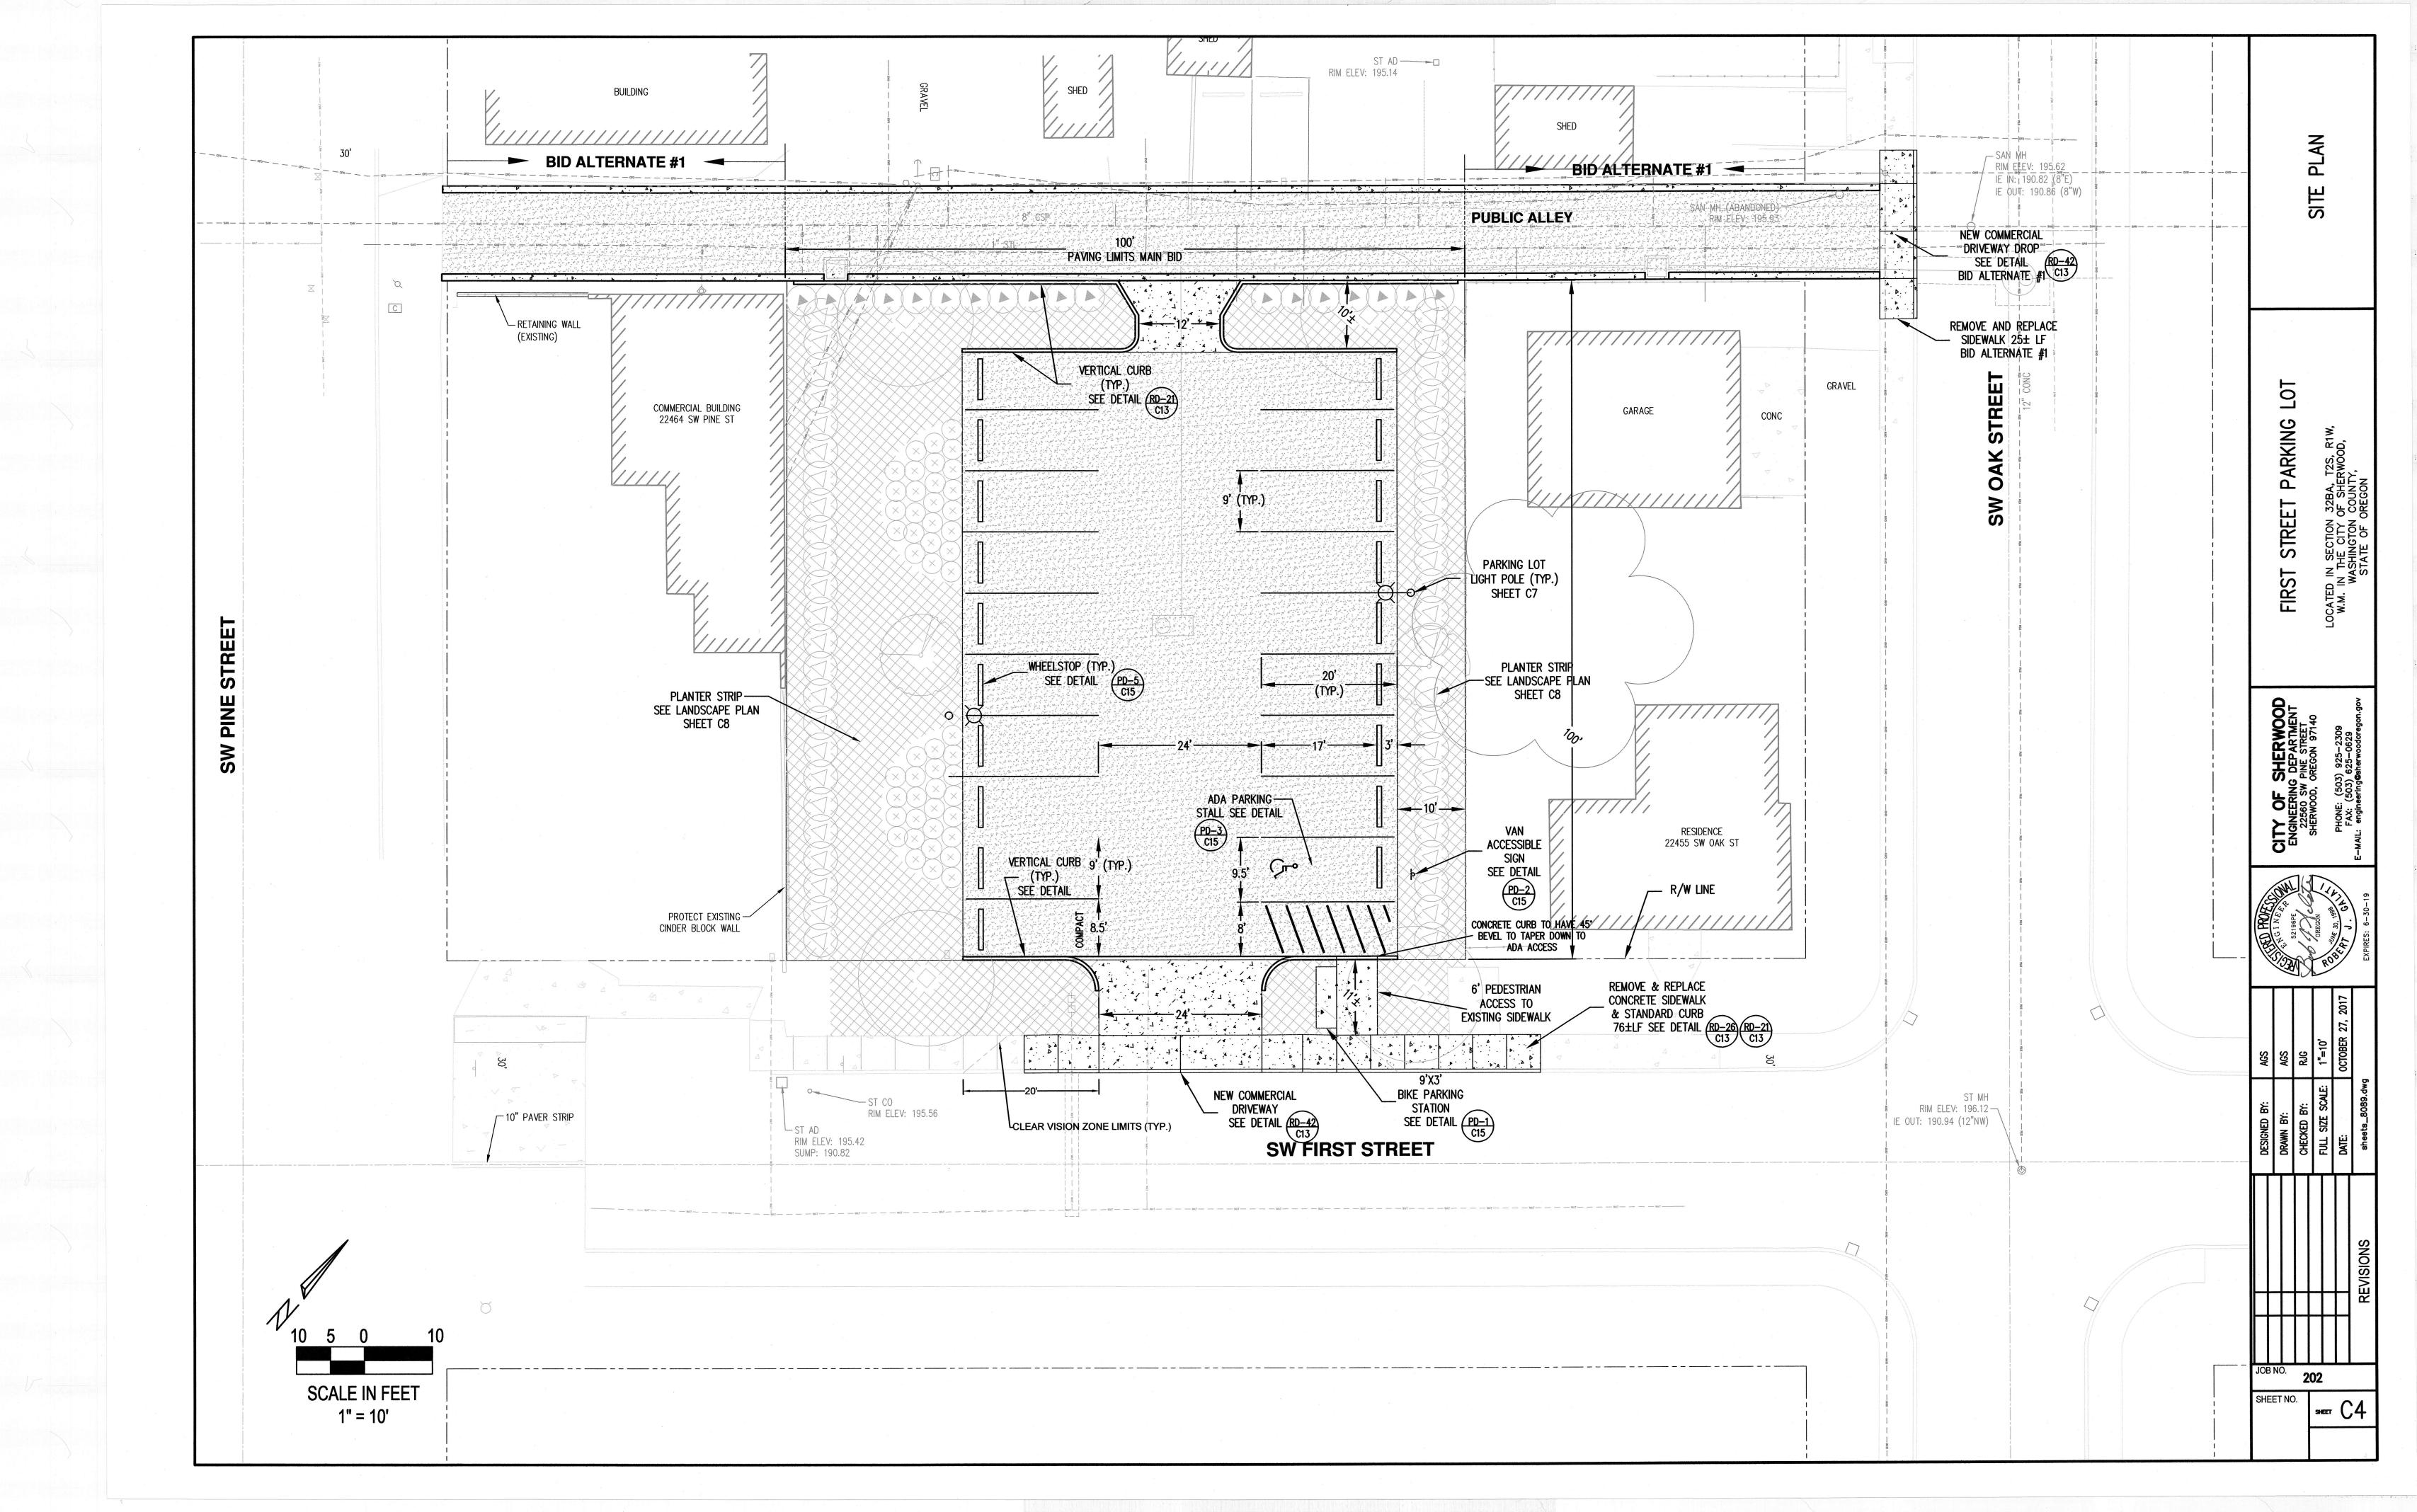
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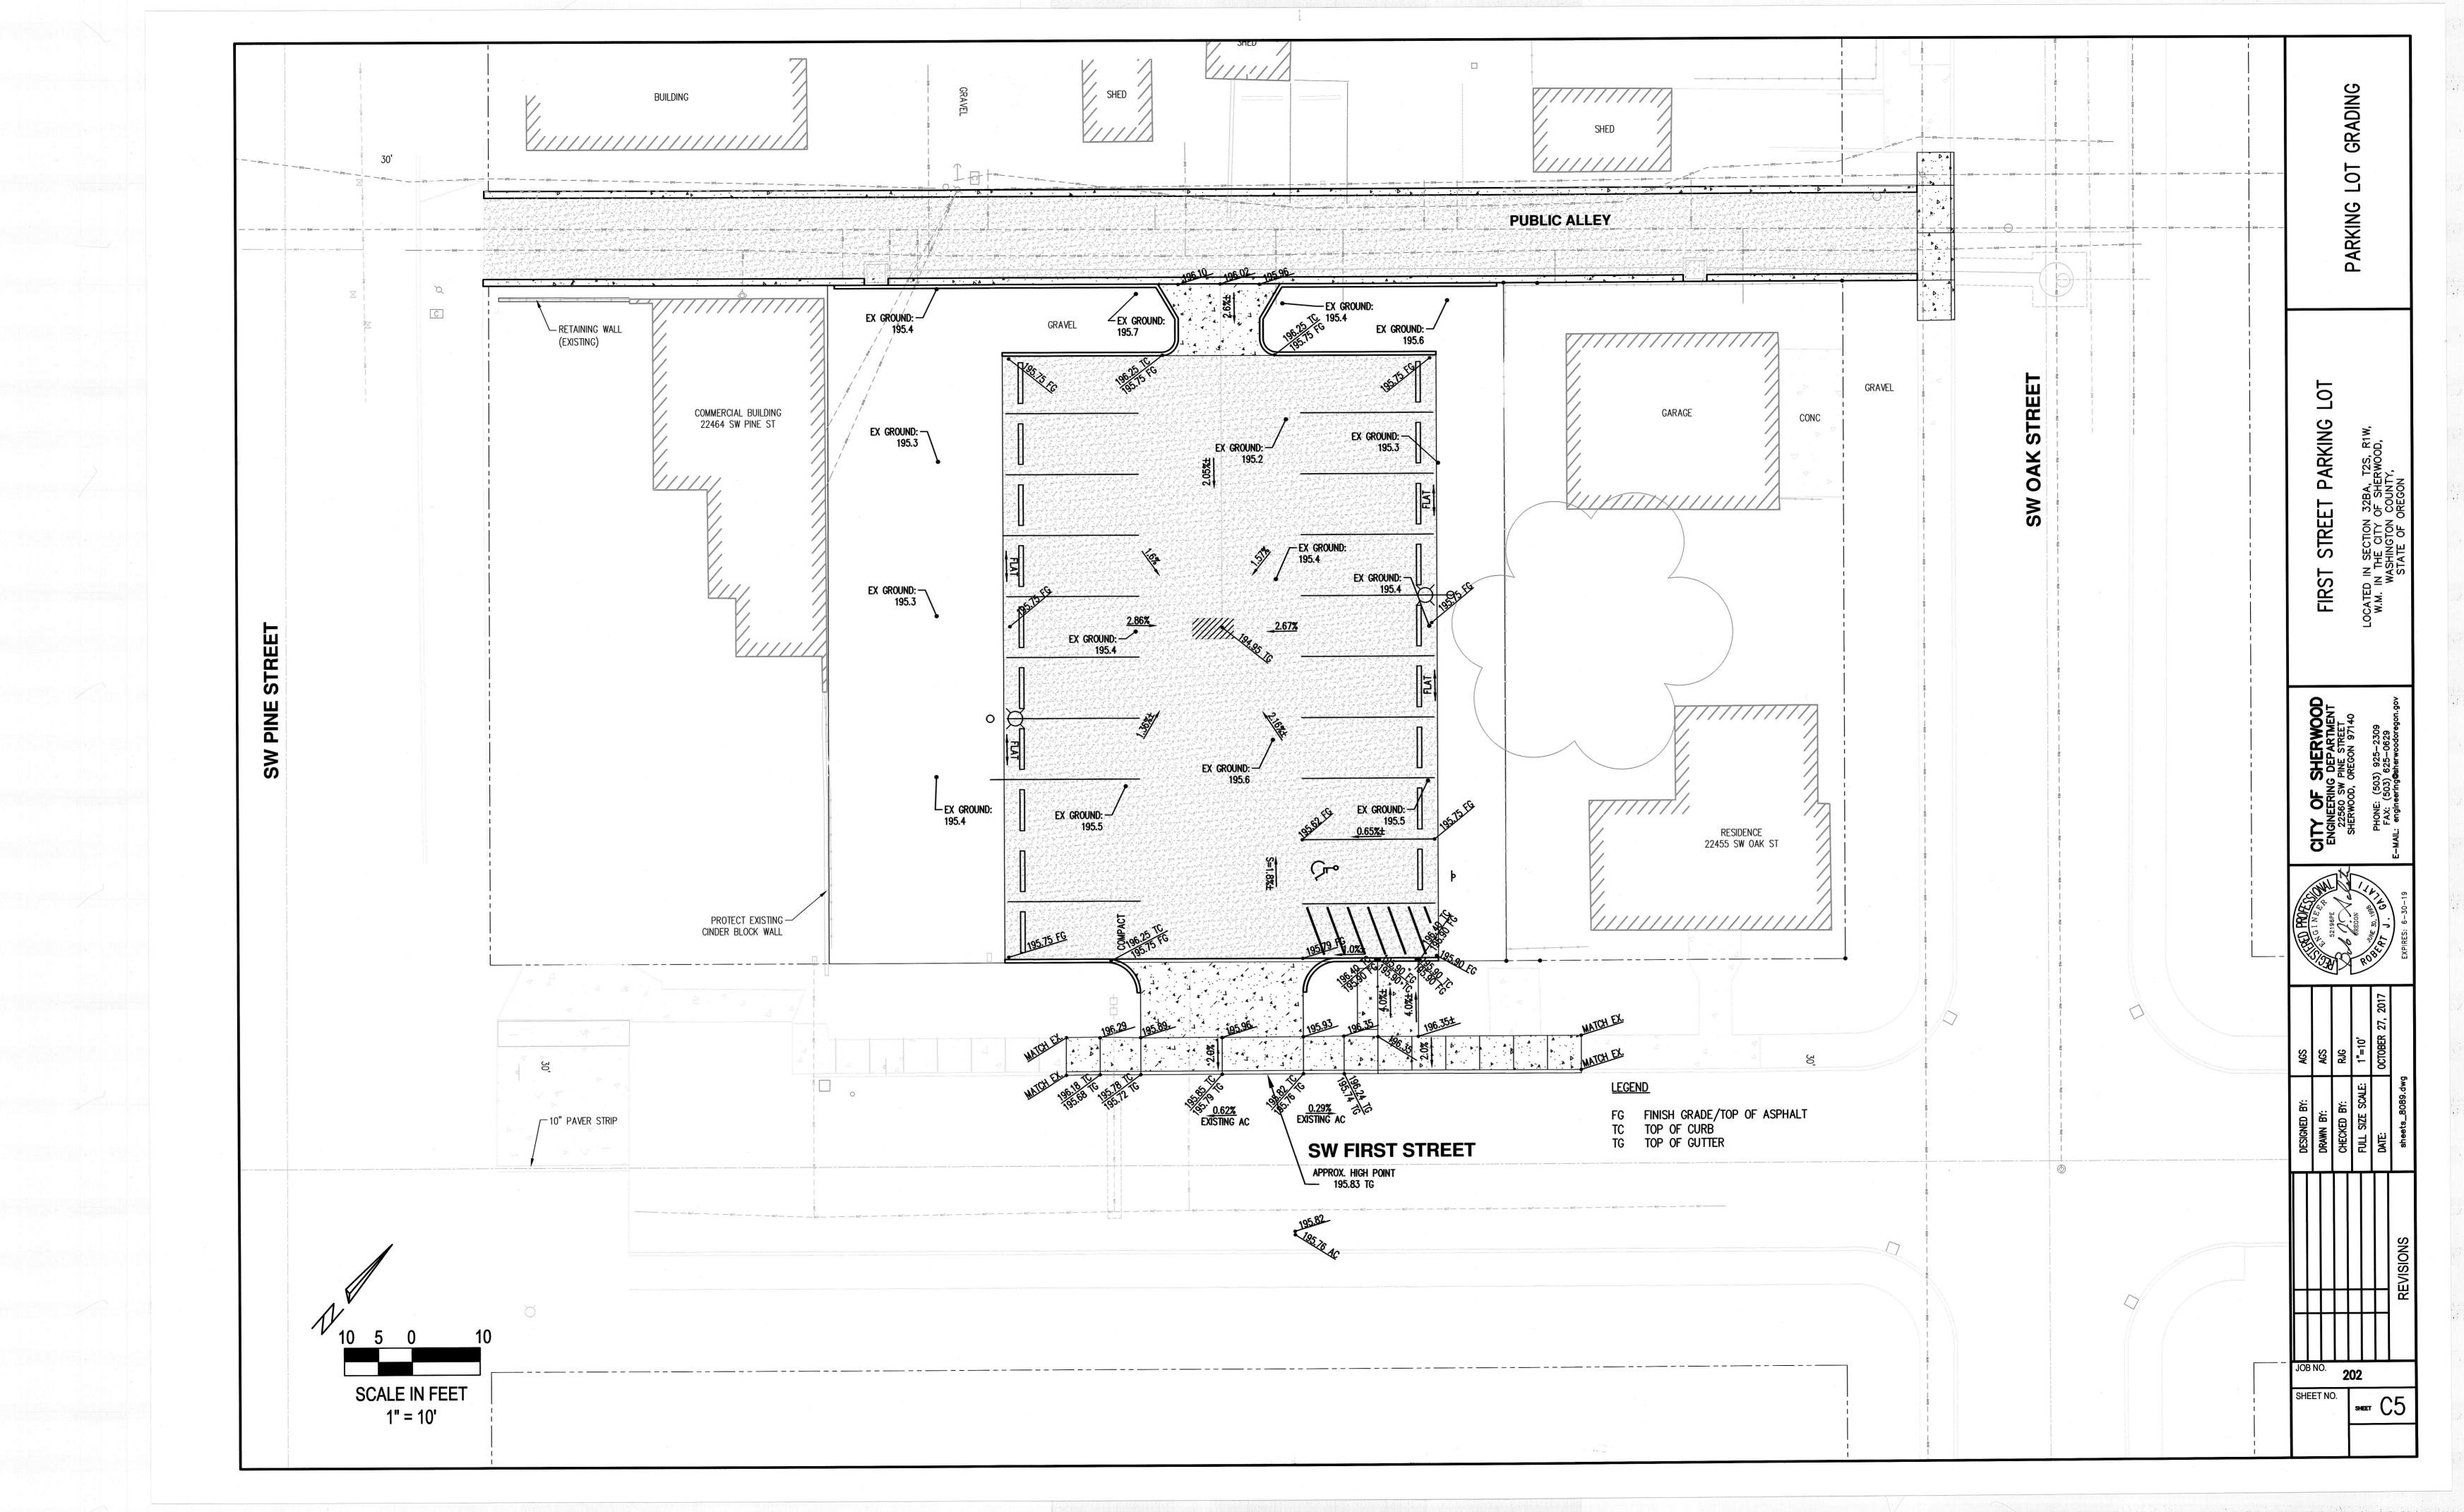
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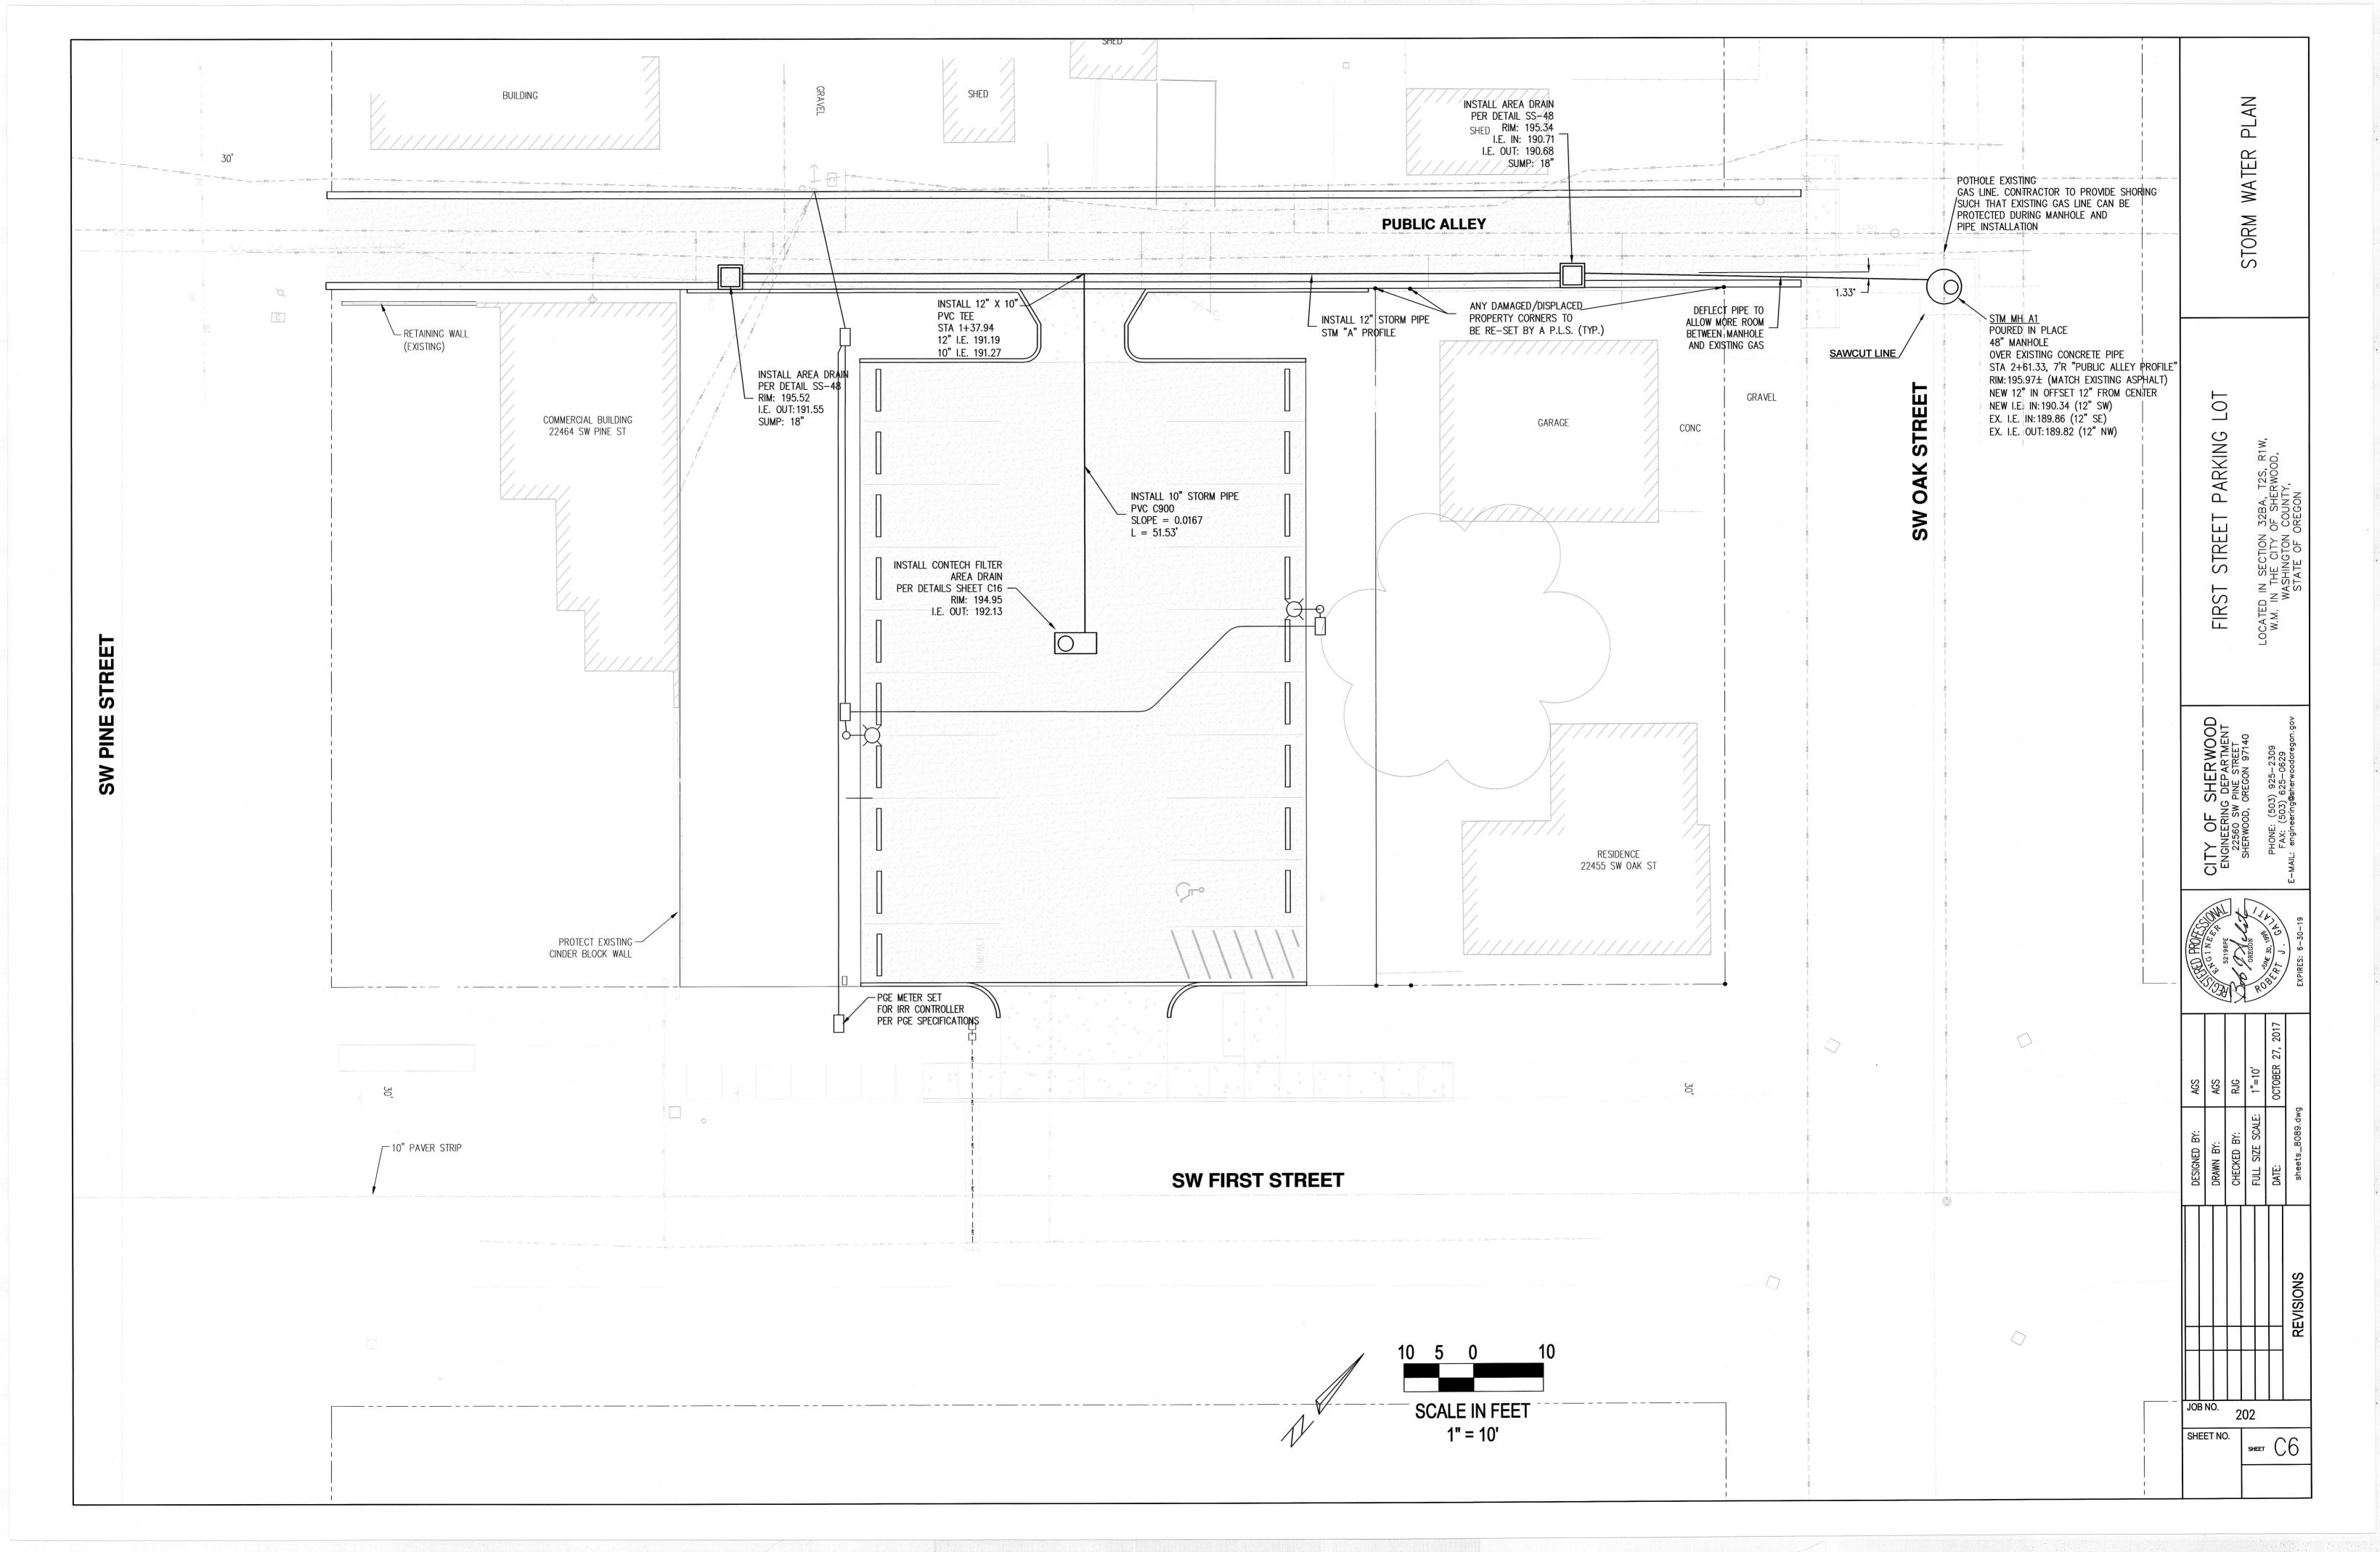
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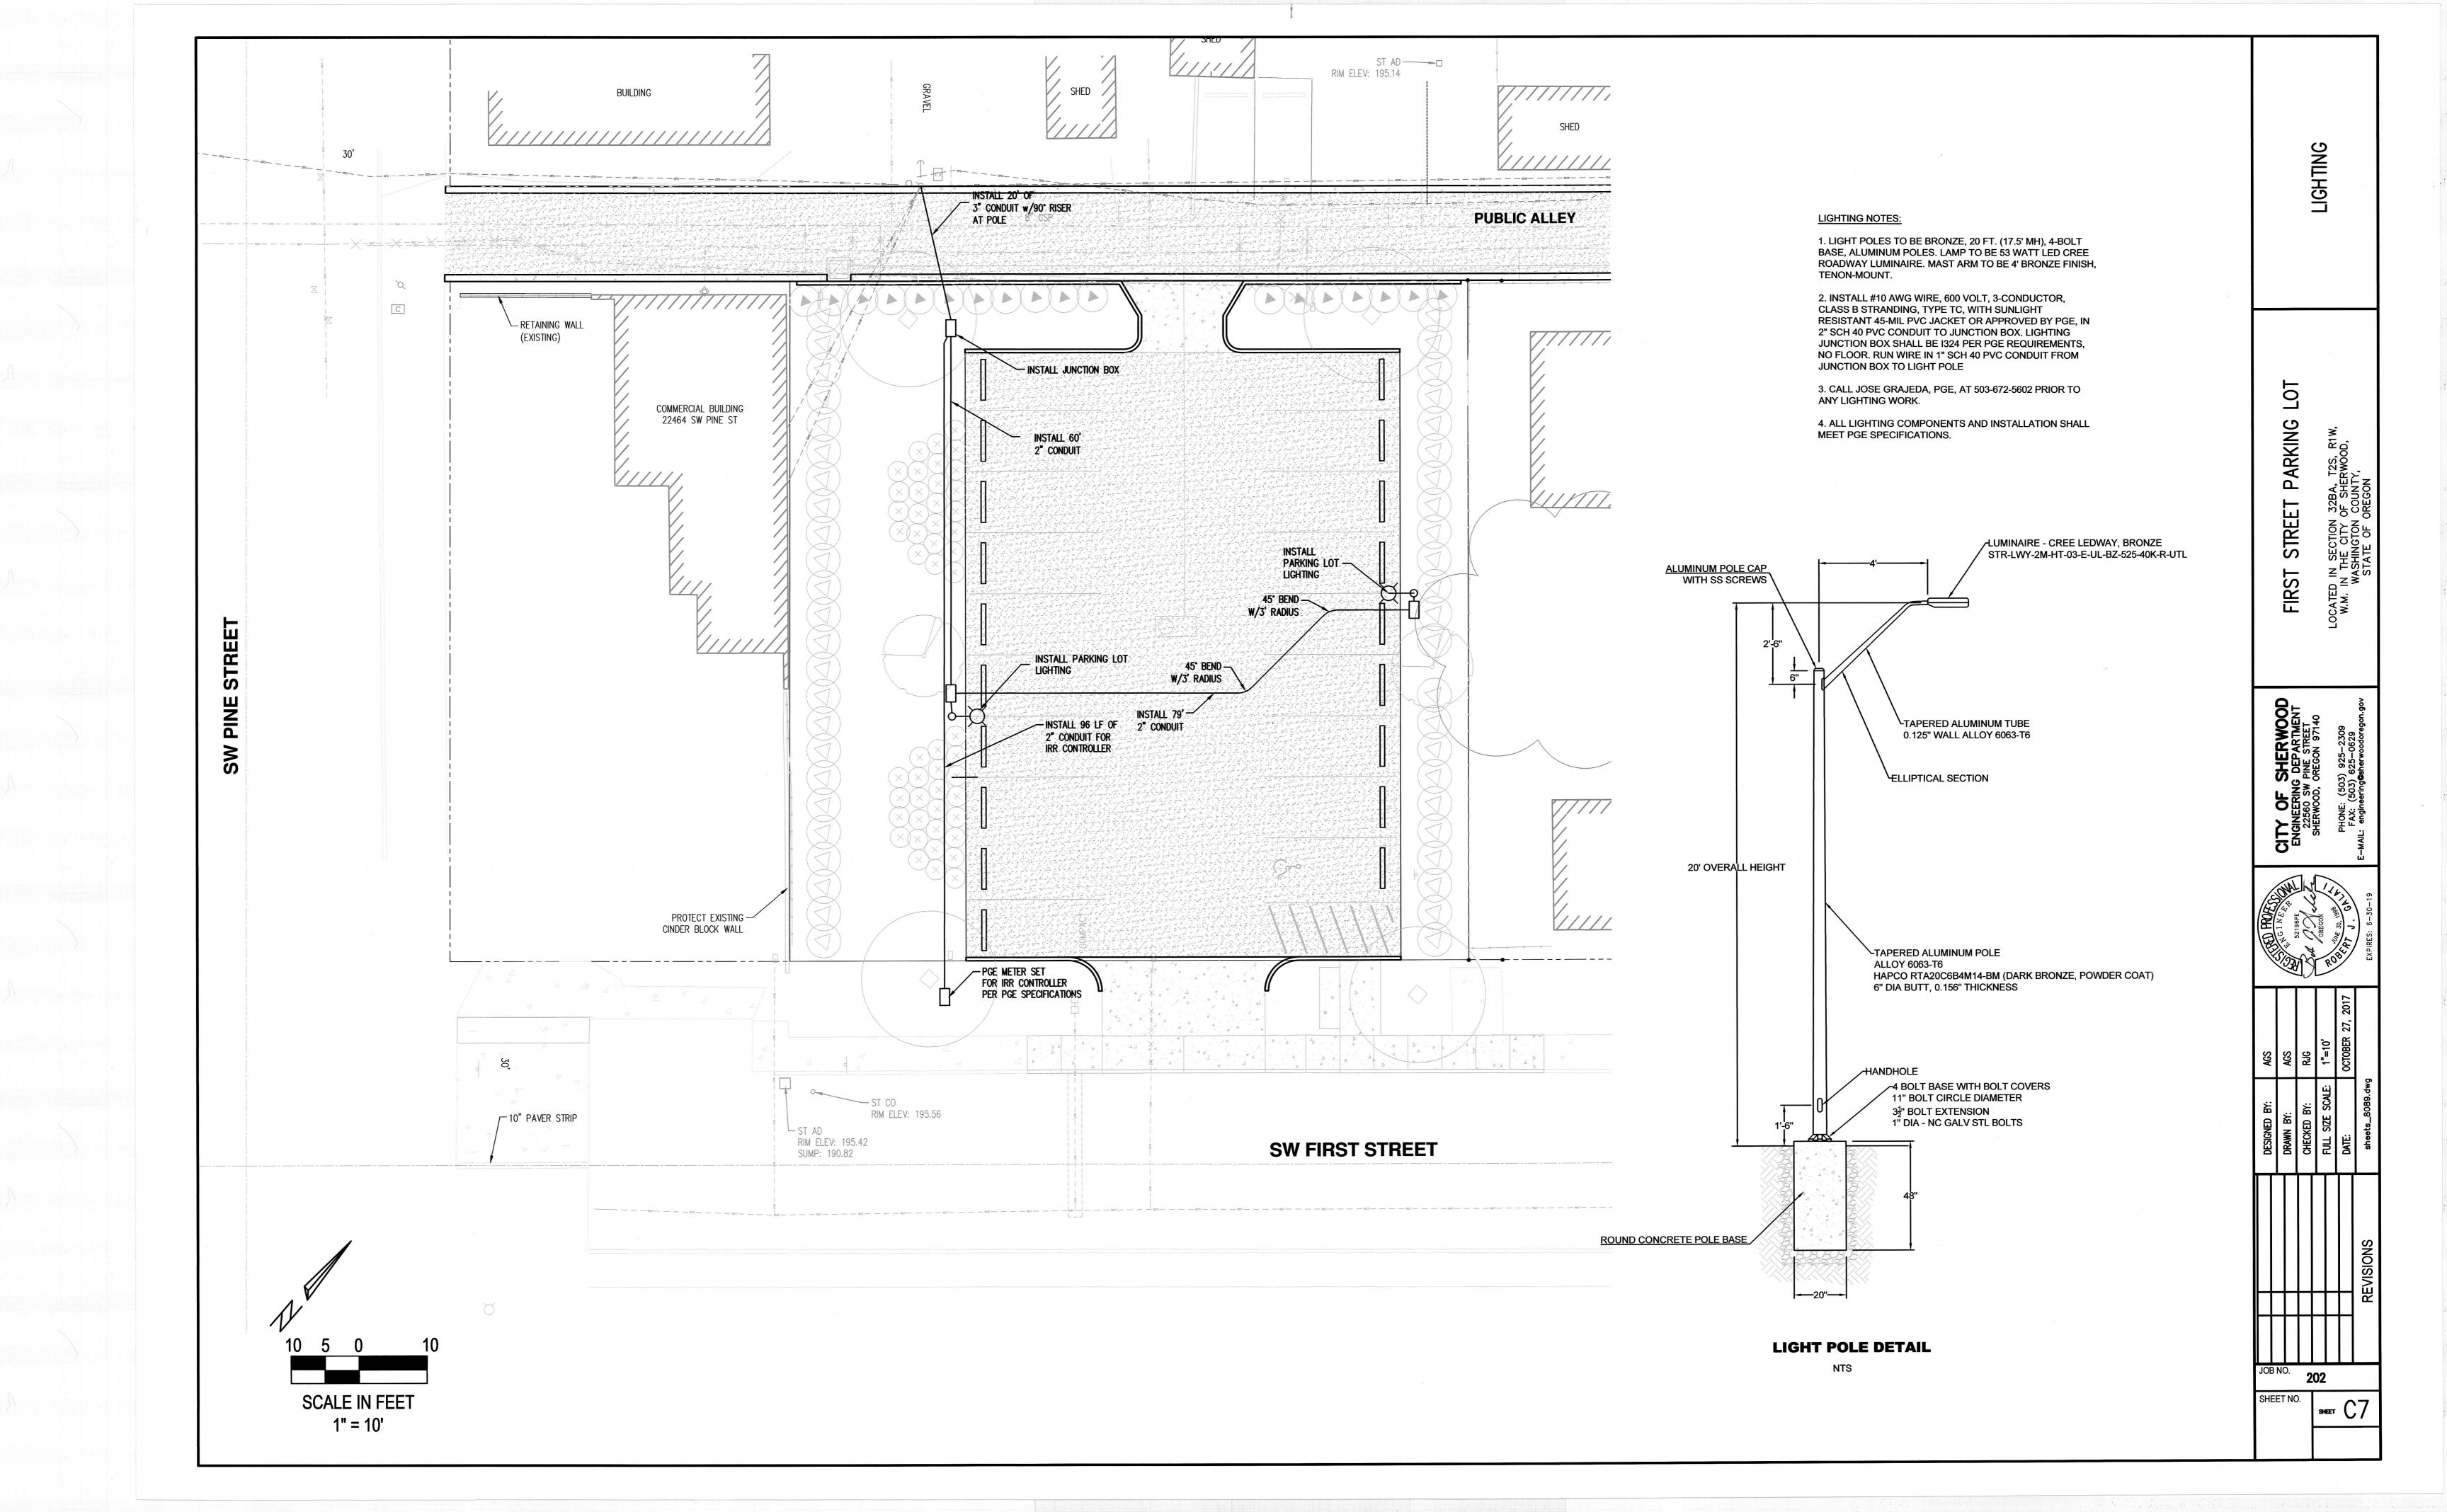
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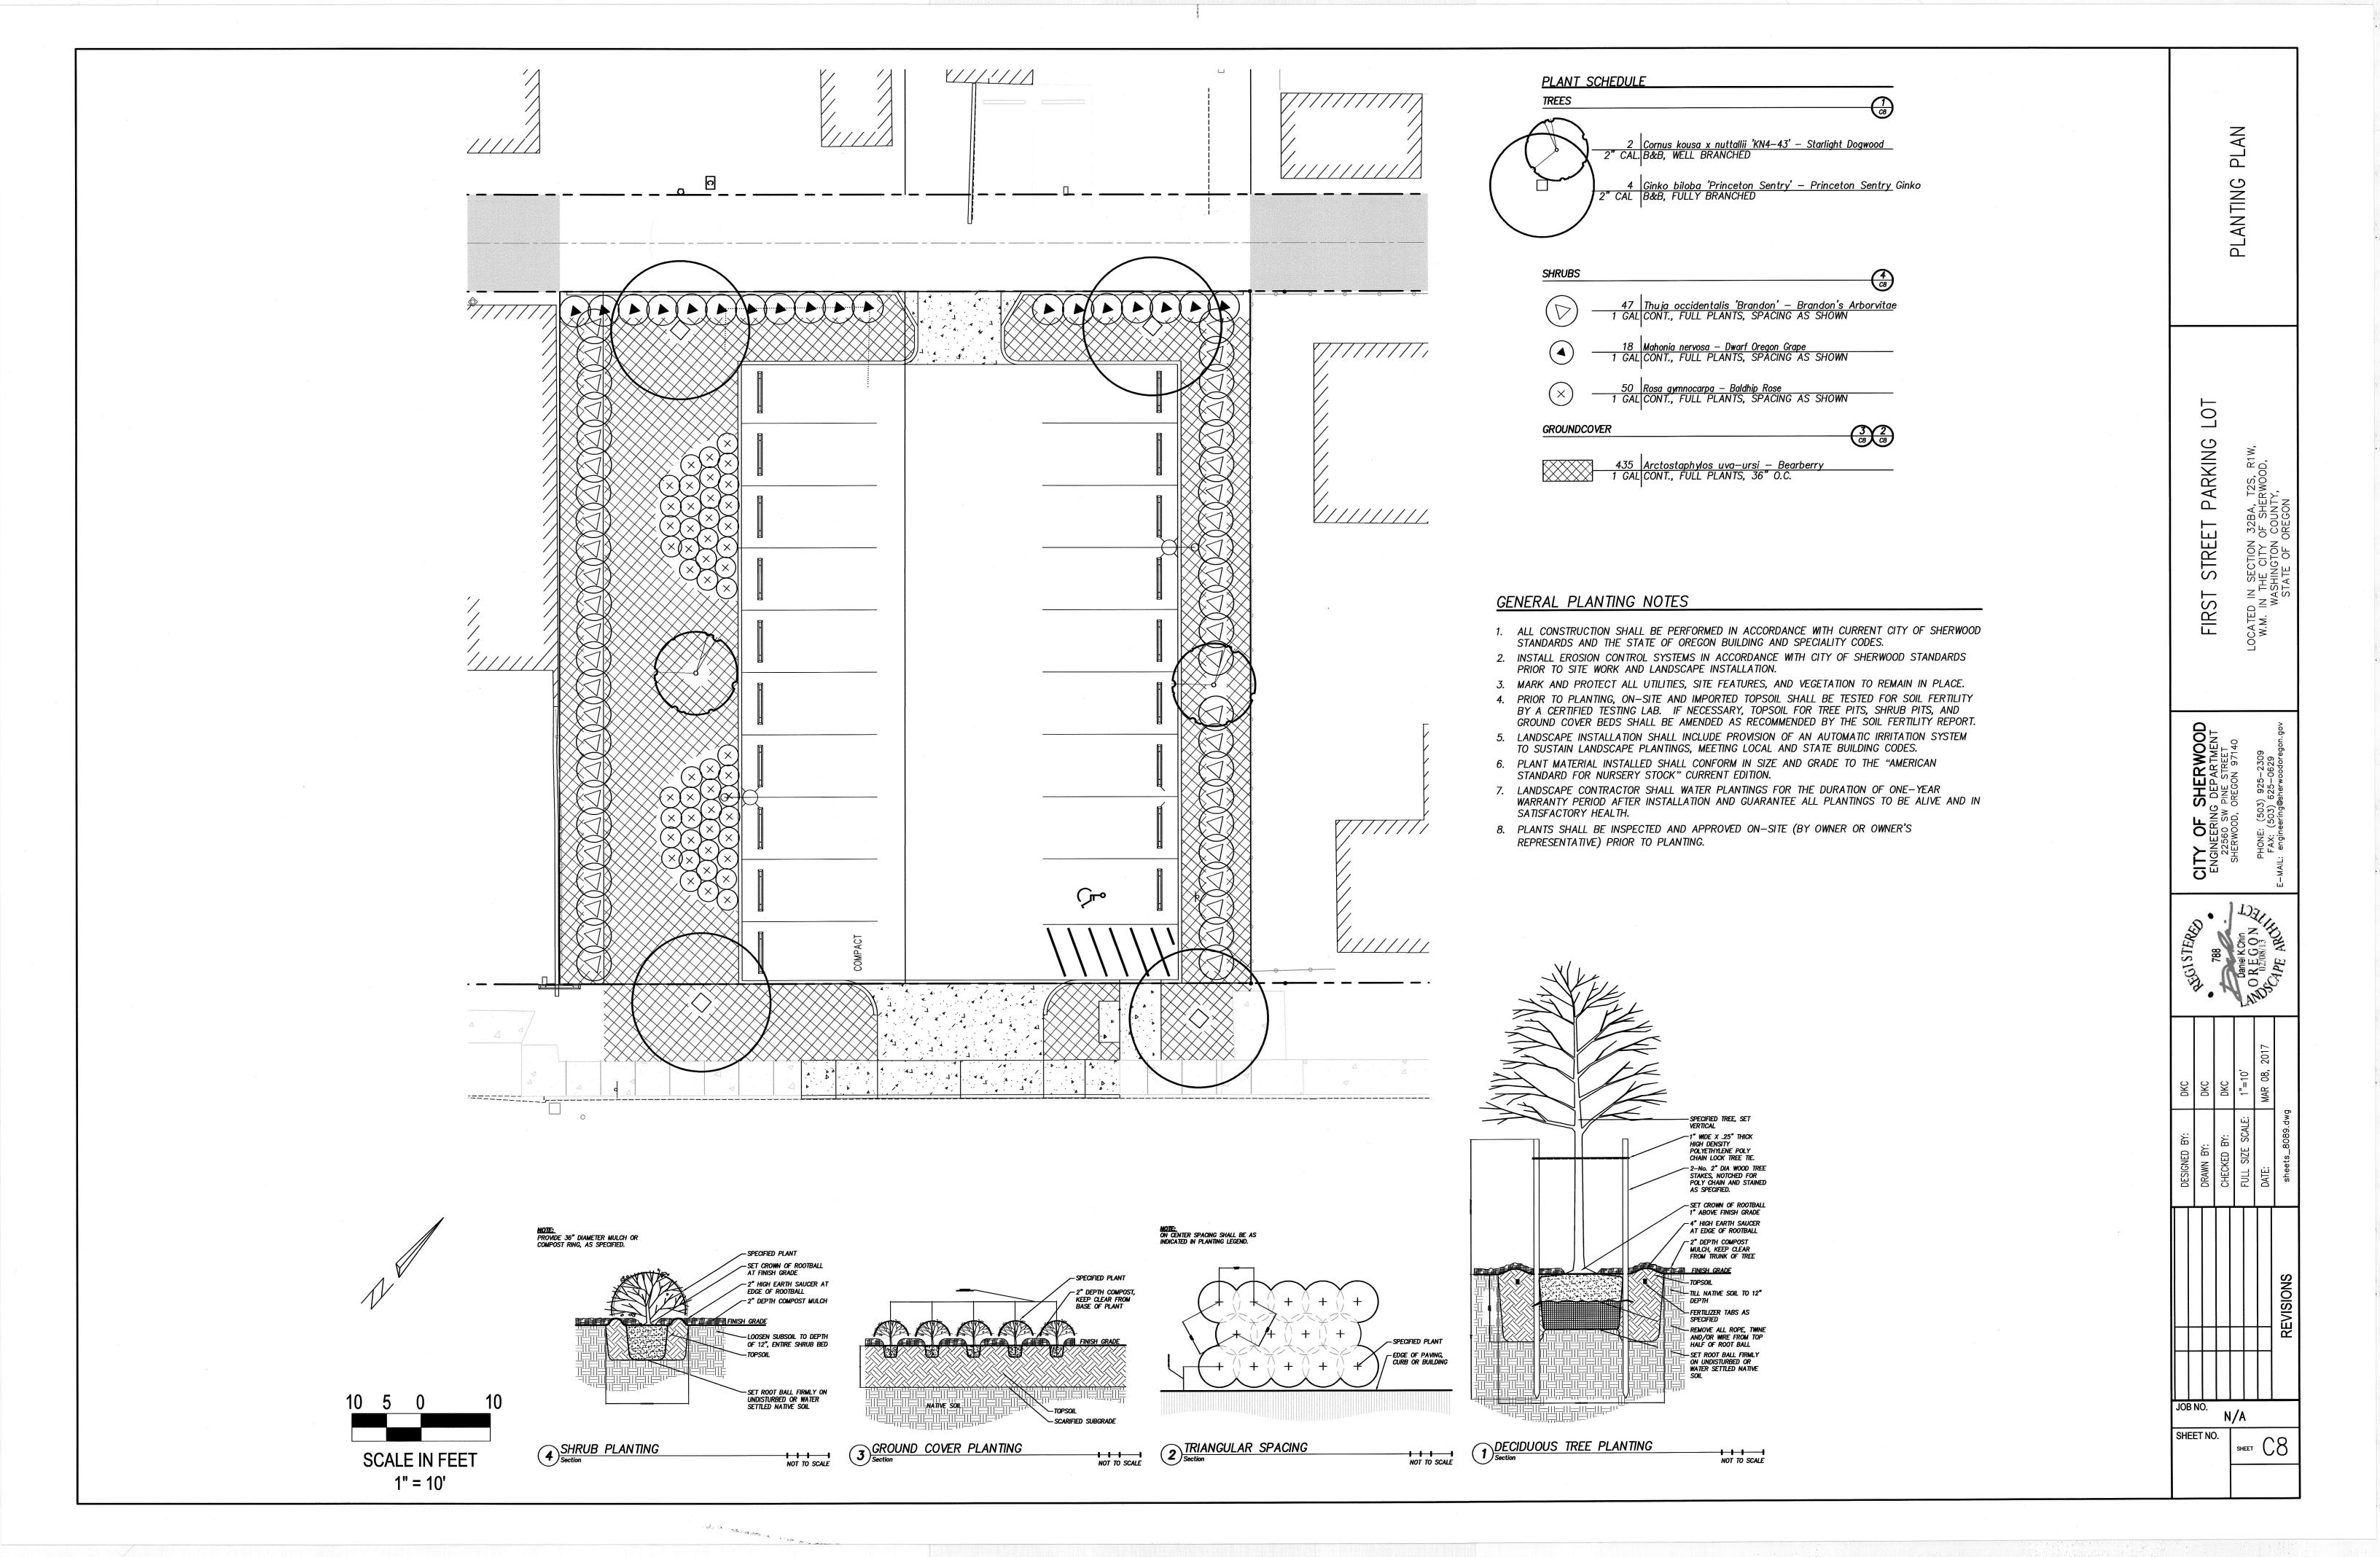












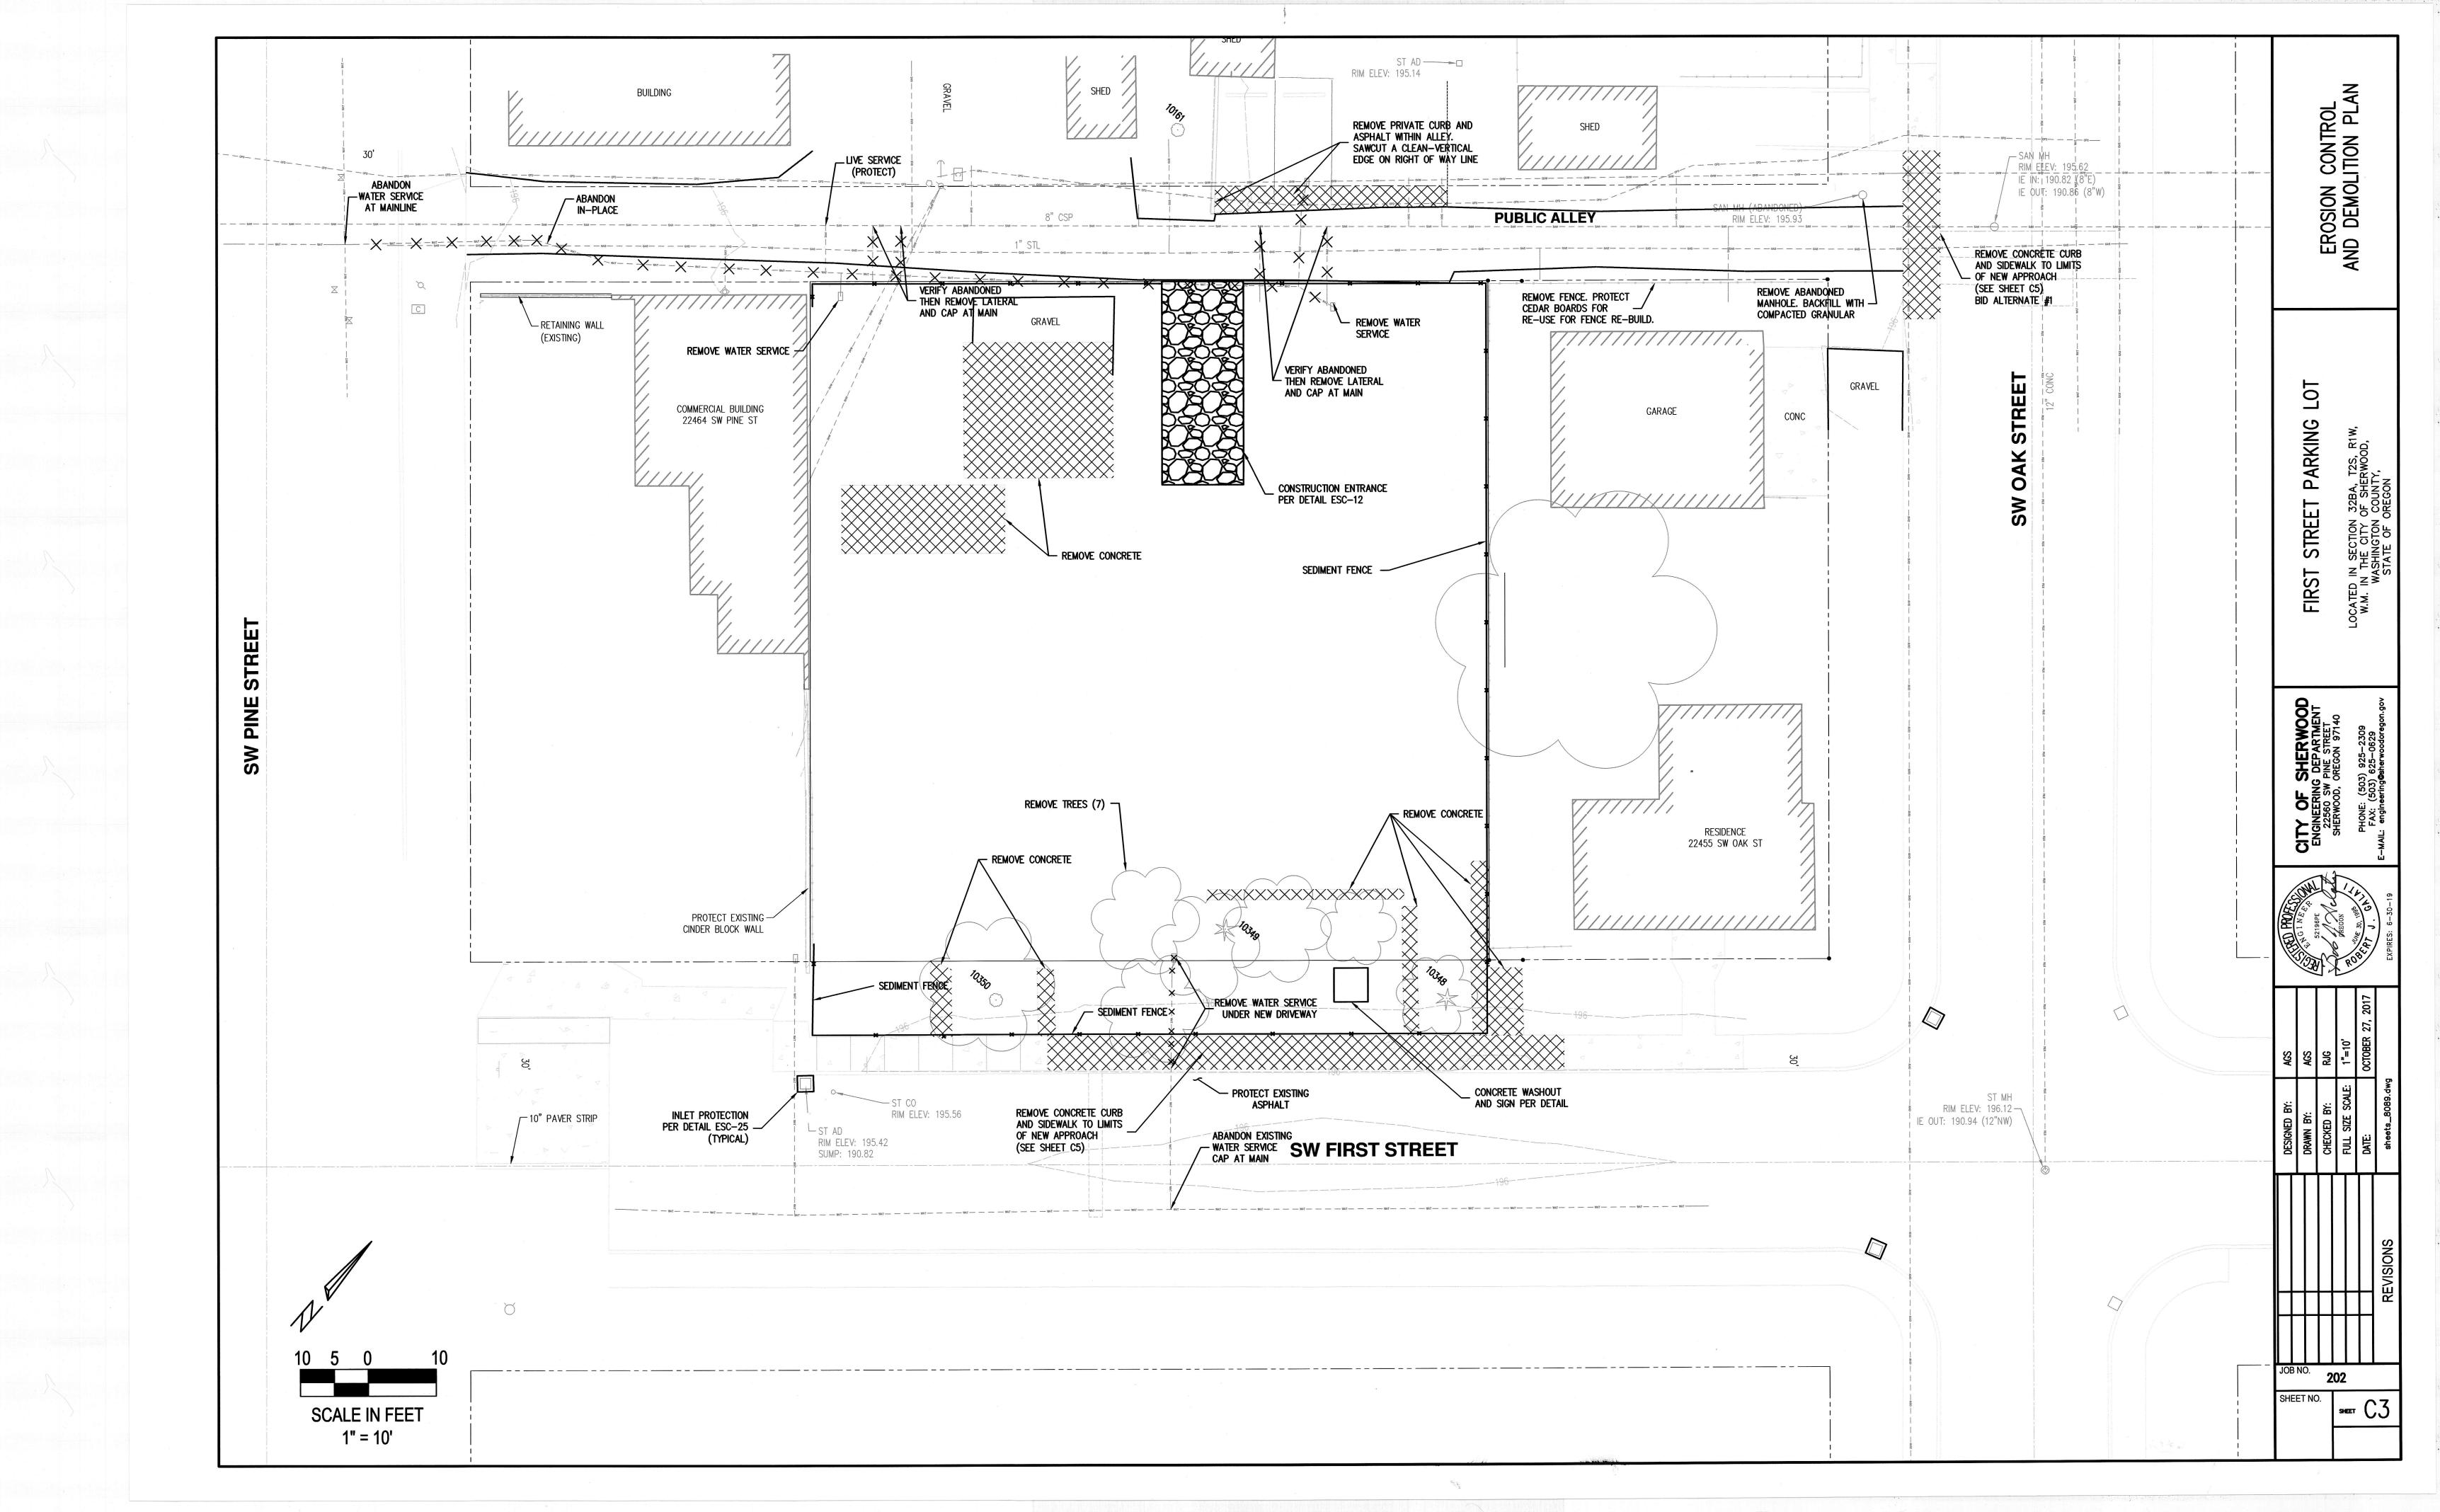


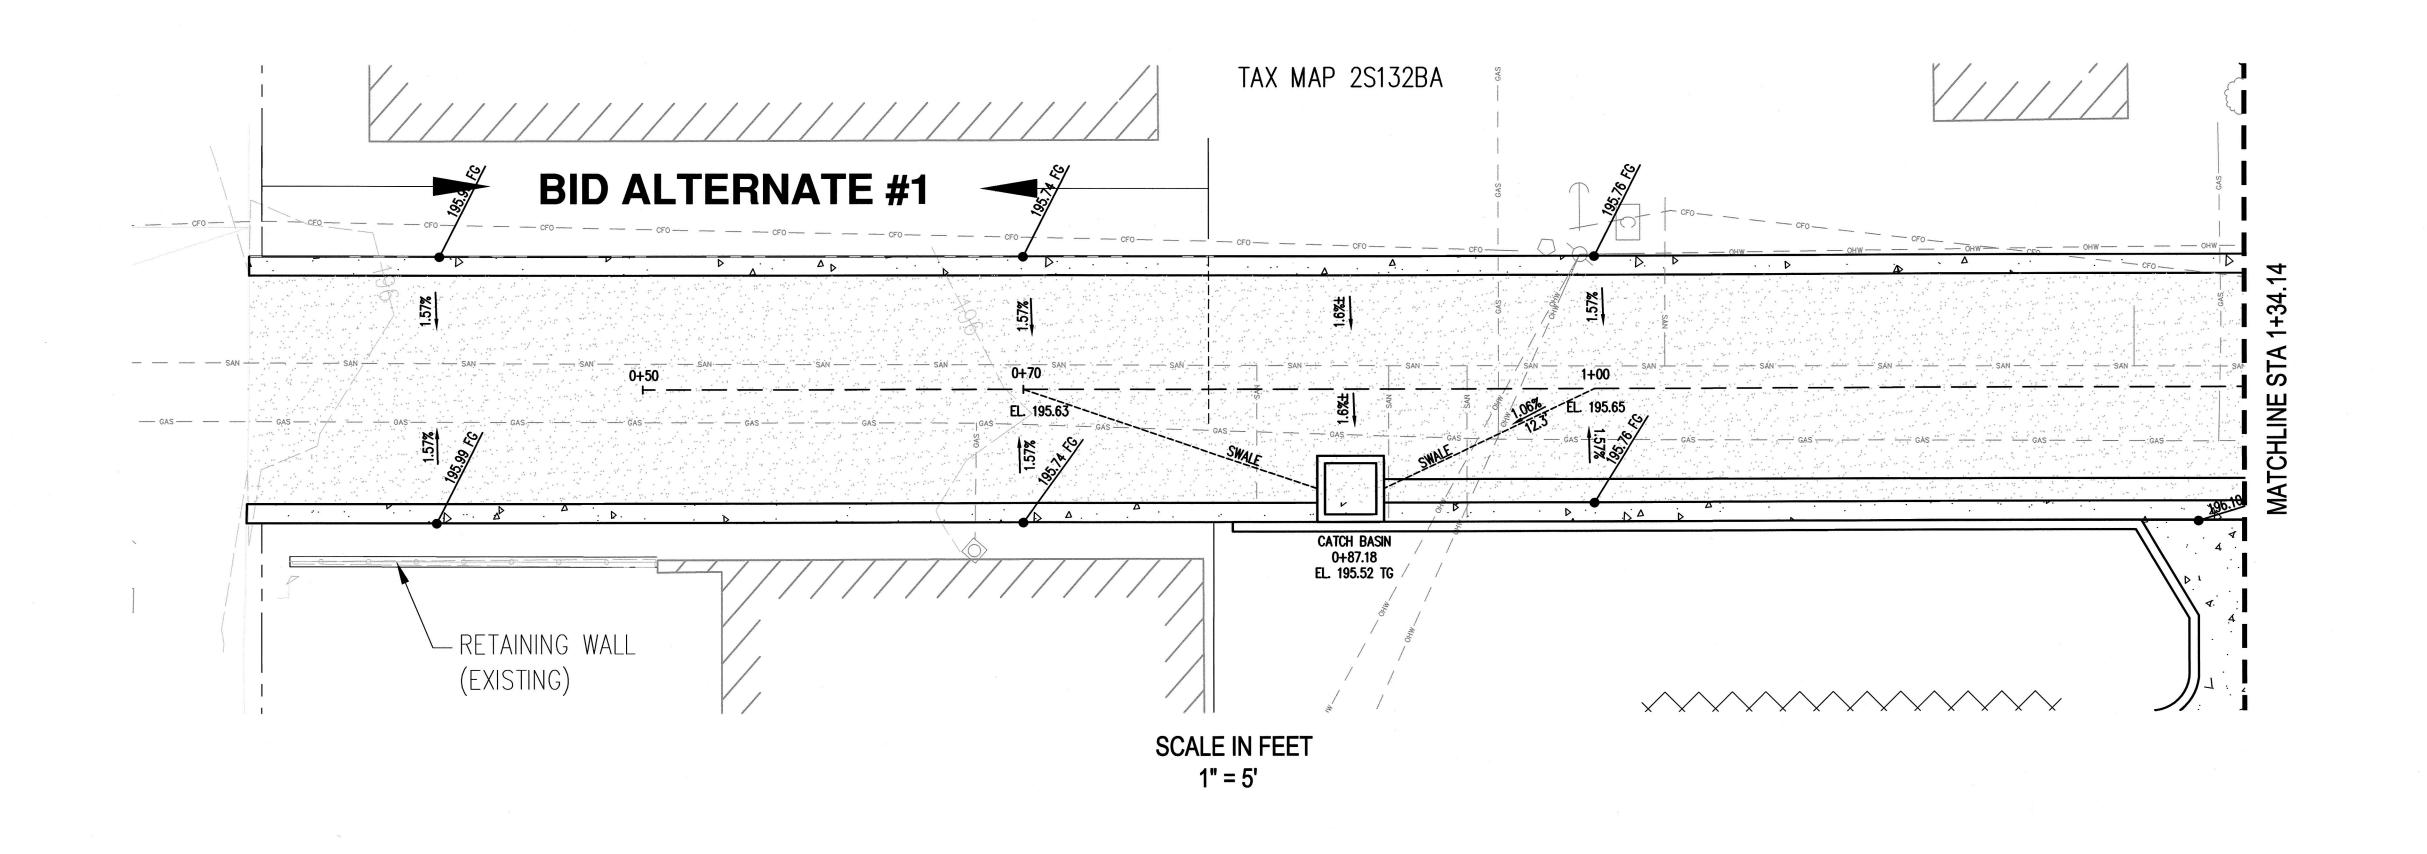


GRADING

FIRST STREET PARKING LOT

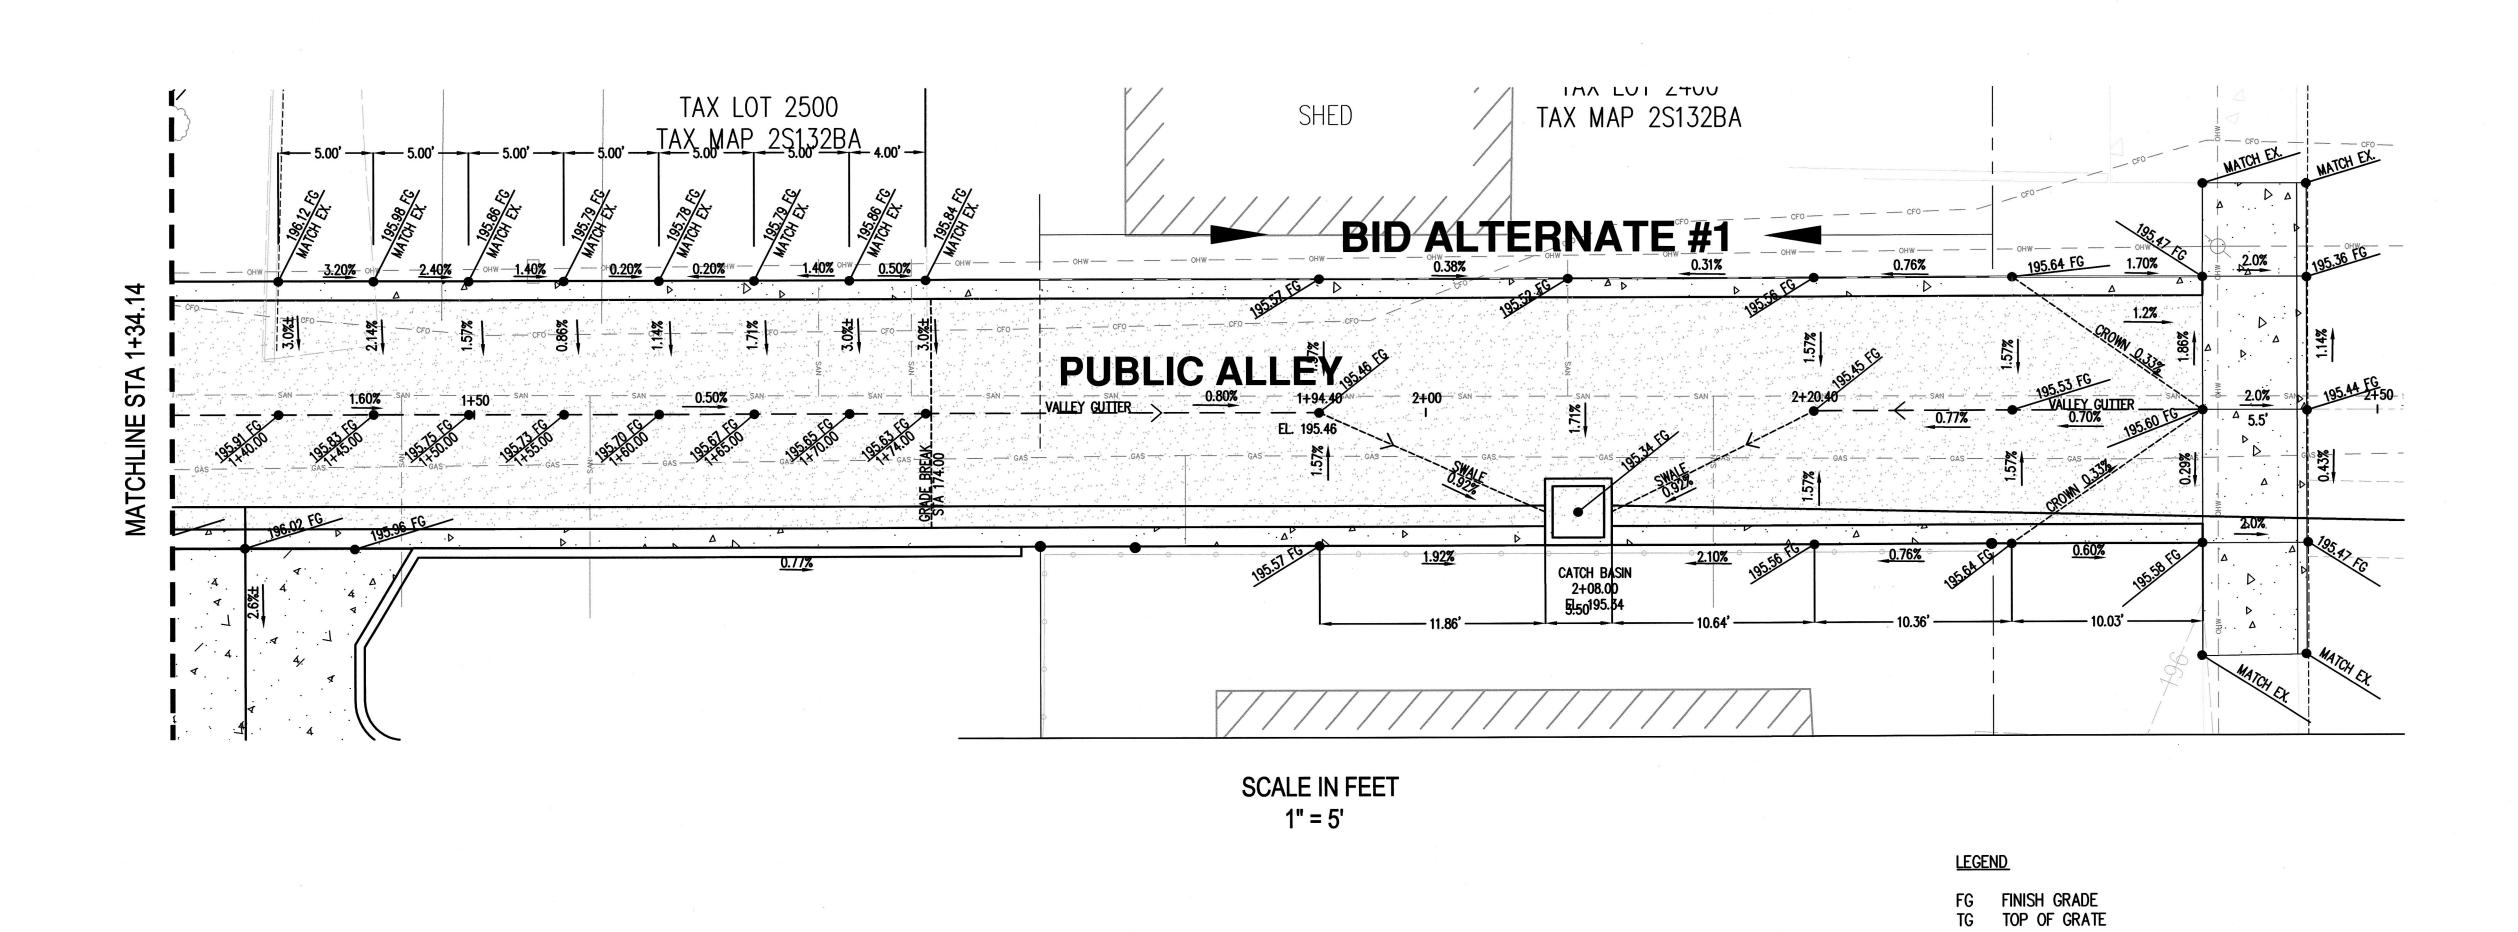

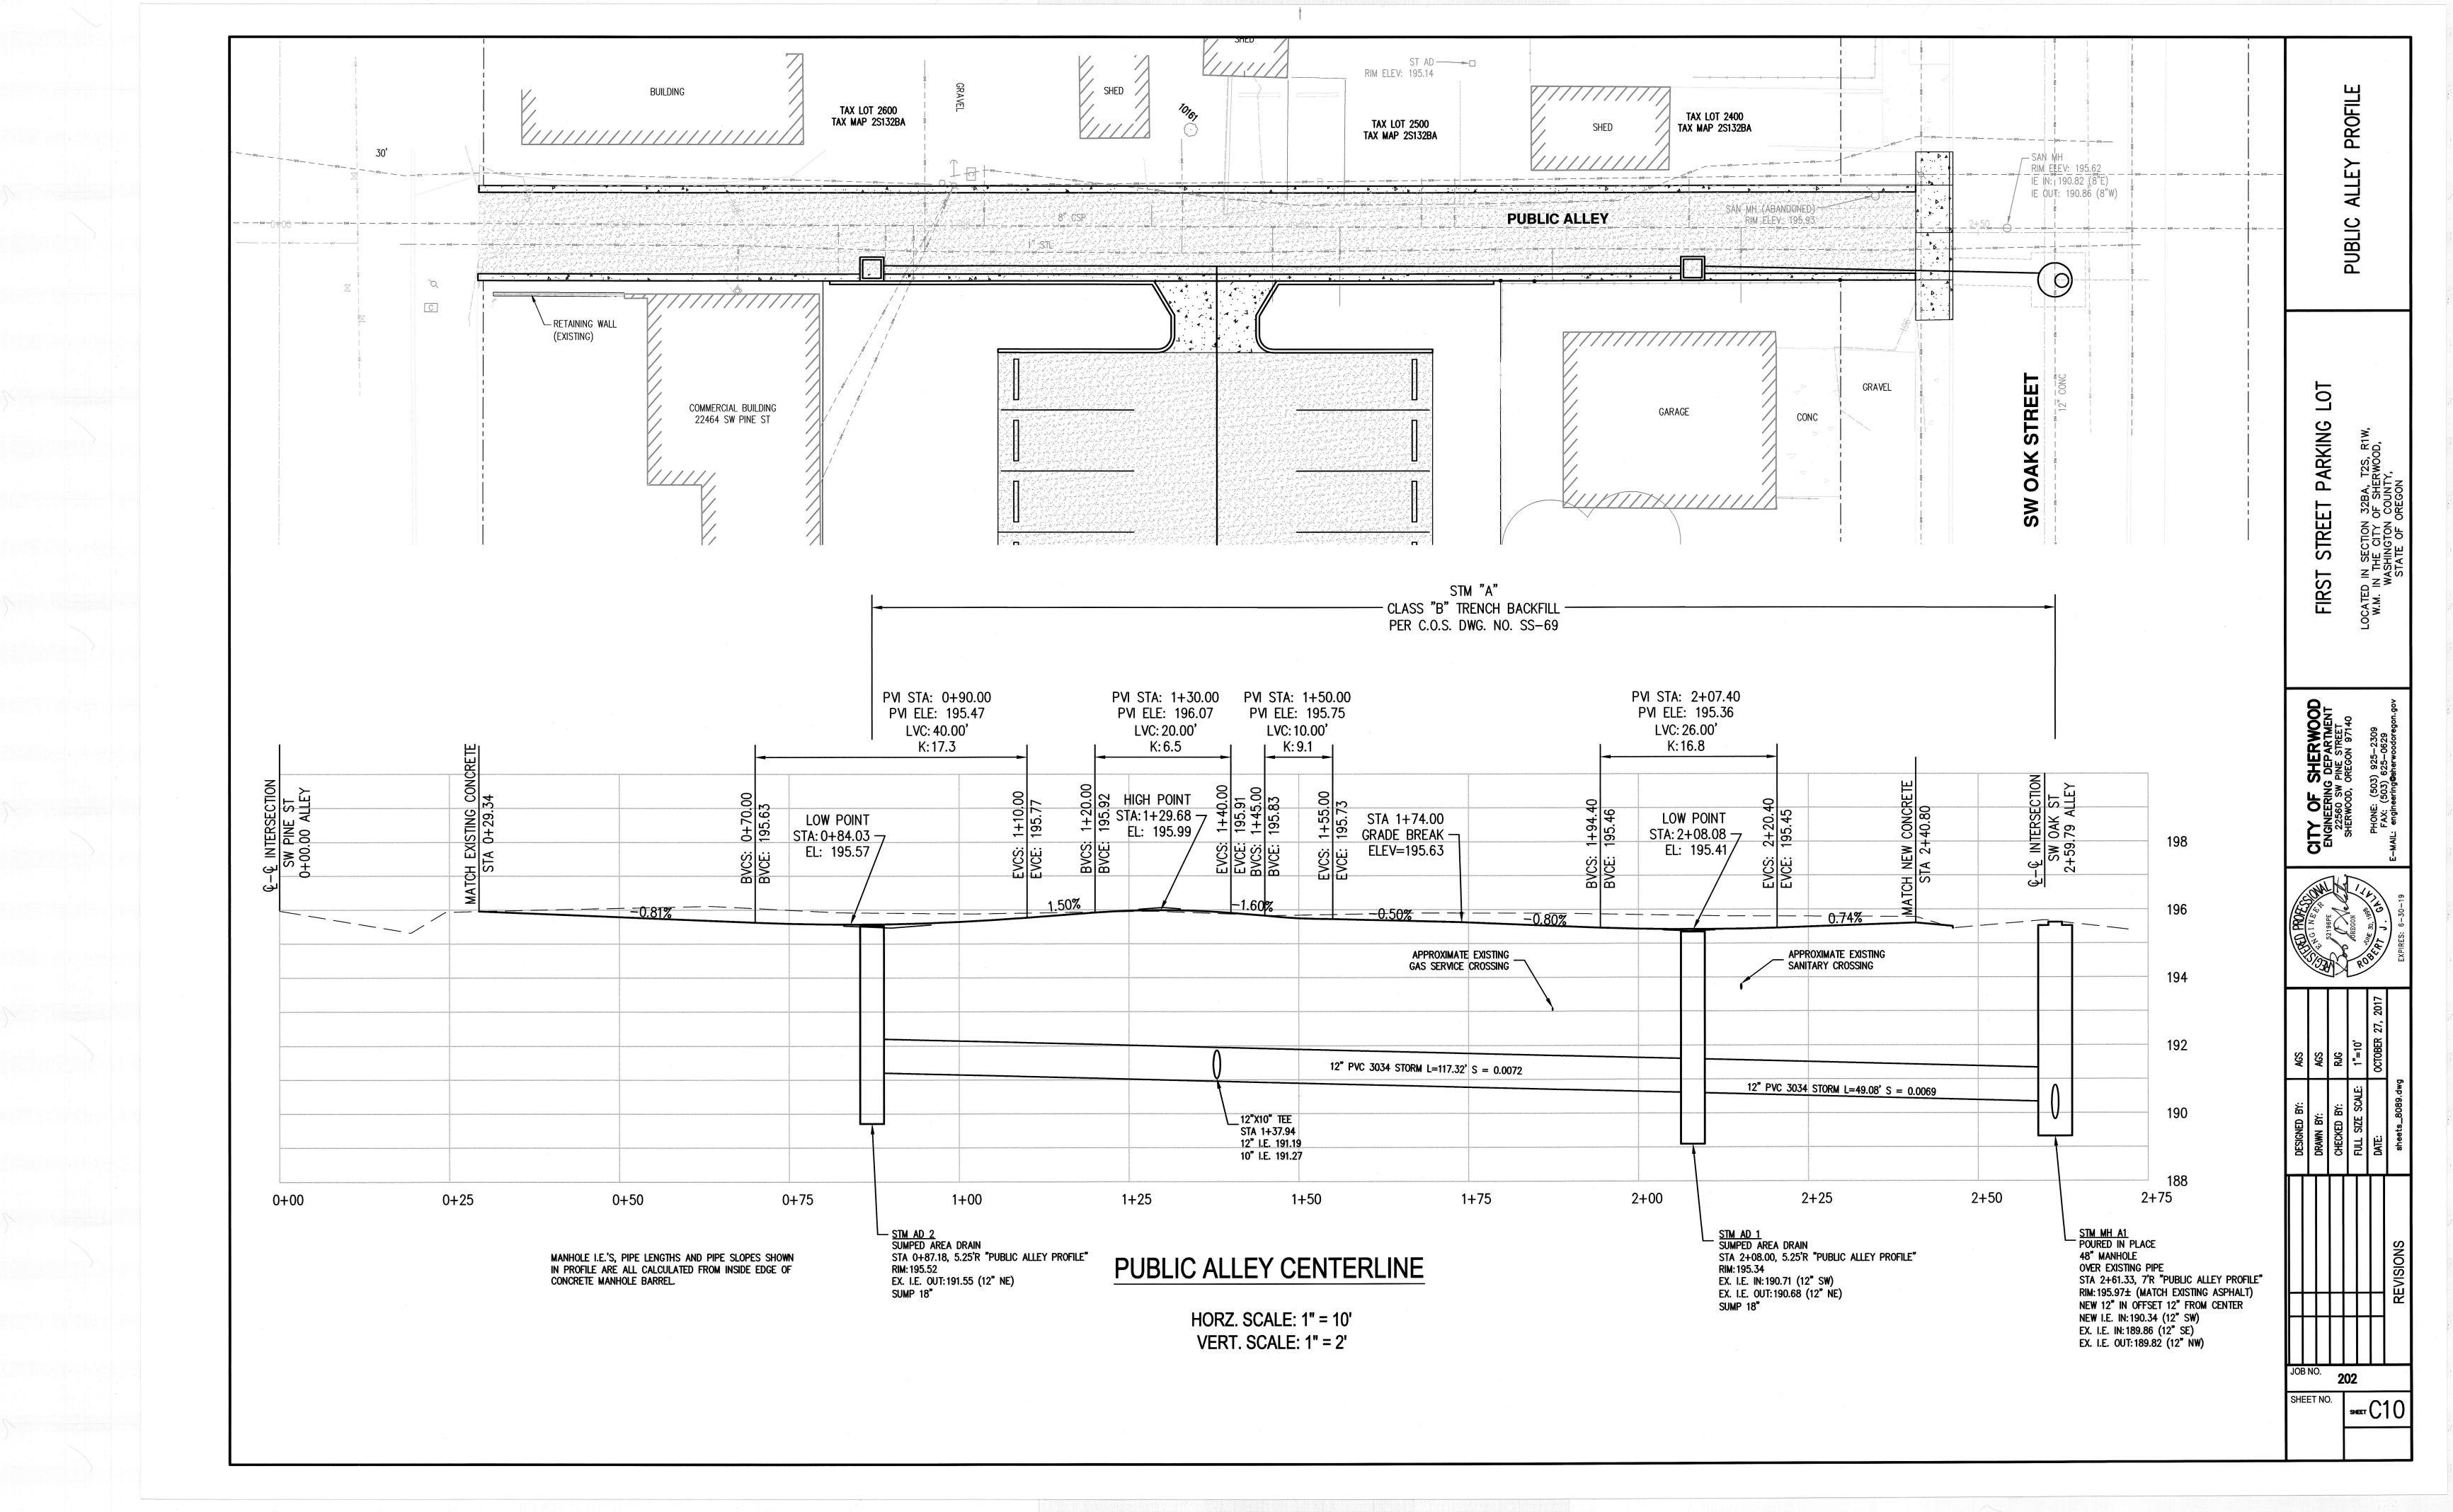


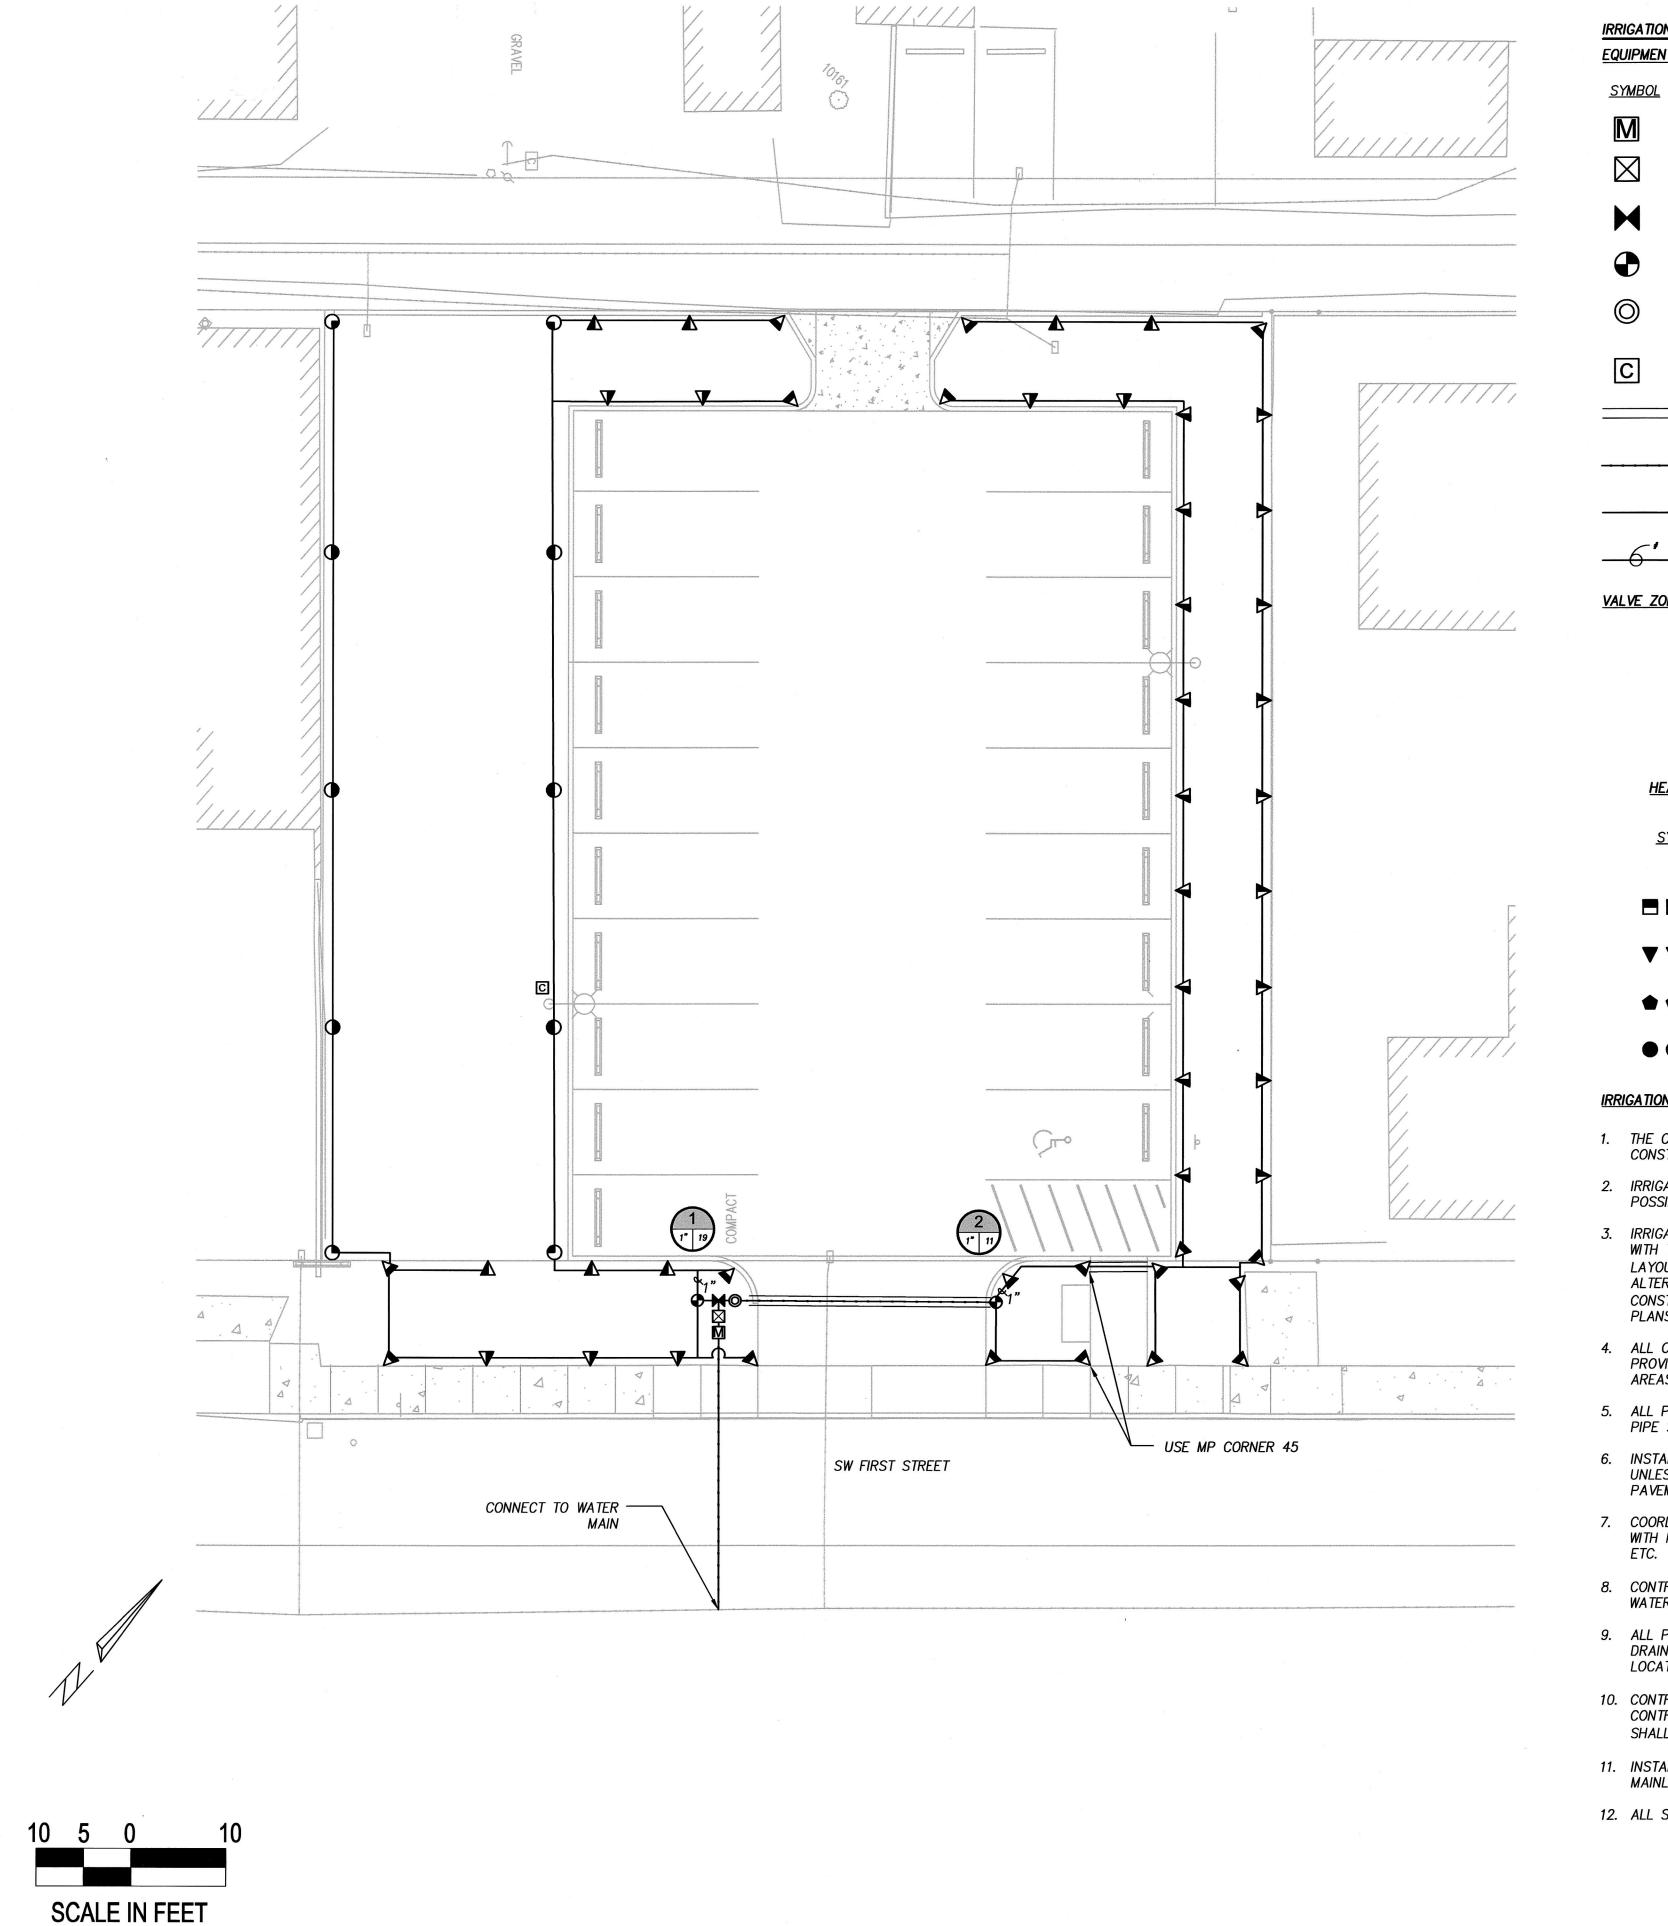

1" = 10'

IRRIGATION LEGEND **EQUIPMENT** <u>SYMBOL</u> <u>DESCRIPTION</u> WATER METER BACKFLOW PREVENTOR - FEBCO MODEL 850 Y, 1 1/2" OR APPROVED EQ. BALL VALVE - NIBCO T-560 OR APPROVED EQUAL. REMOTE CONTROL VALVE — HUNTER ICV OR APPVD EQ, SIZE AS SHOWN REMOTE CONTROL VALVE QUICK COUPLER - HUNTER HQ3 OR APPROVED EQUAL. CONTROLLER - HUNTER I-CORE (ICC-600-M). INSTALL IN METAL PEDESTAL & PROVIDE 120/230 VAC POWER SUPPLY. SLEEVING - 4" SLEEVE FOR PIPES < 2", 6" SLEEVE FOR PIPES 2.5"-4" _____ MAINLINE - 1 1/2" SCH. 40 PVC _____LATERAL LINE - .75", CLASS 200 PVC ______ LATERAL LINE - SIZE AS INDICATED, CLASS 200 PVC

VALVE ZONE KEY

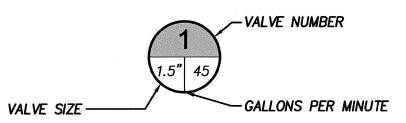



HEAD SCHEDULE			$\begin{pmatrix} 1 \\ C-12 \end{pmatrix}$		
<u>SYMBOL</u> HUN	DESCRIPTION TER MPR40 HEADS W/ MP ROTATOR NOZZLES	<u>PSI</u>	<u>RADIUS</u>	<u>GPM</u>	
	MPSS530, MPLCS515 & MPRCS515	40	5X30', 5'X15'	.44, .22	
▼ ▼ ▶	MP1000 (360, 180, 90)	40	8'–15'	.75, .37, .19	
••	MP2000 (360, 180, 90)	40	13'-21'	1.47, .74, .40	
$\bullet \bullet \bullet$	MP3000 (360, 180, 90)	40	22'-30'	3.64, 1.82, .86	


IRRIGATION GENERAL NOTES


- 1. THE CONTRACTOR SHALL INSPECT THE SITE AND VERIFY CONDITIONS AND DIMENSIONS PRIOR TO CONSTRUCTION.
- 2. IRRIGATION PLANS ARE SCHEMATIC DRAWINGS ONLY. PLACE LINES IN A COMMON TRENCH WHENEVER POSSIBLE. FIELD ADJUST LINES TO AVOID CONFLICT WITH UTILITIES.
- 3. IRRIGATION IS COORDINATED WITH THE PLANTING PLAN AND SITE IMPROVEMENTS AND IS DESIGNED WITH TRIANGULAR SPACING GIVING HEAD TO HEAD COVERAGE. COORDINATE IRRIGATION HEAD LAYOUT WITH NEW PLANT MATERIALS, LOCATE SPRAY HEADS 30" FROM BASE OF TREE. DO NOT ALTER HEAD LOCATION, PIPE LAYOUT, OR VALVE LOCATION WITHOUT WRITTEN APPROVAL FROM THE CONSTRUCTION MANAGER. NOTIFY OWNER'S REPRESENTATIVE IF DISCREPANCIES OCCUR BETWEEN THE PLANS AND FIELD CONDITIONS.
- 4. ALL COMPONENTS OF IRRIGATION SYSTEM SHALL BE INSTALLED AND PROPERLY ADJUSTED TO PROVIDE ADEQUATE COVERAGE AND MINIMIZATION OF OVER SPRAY ONTO WALKS, BUILDINGS, PARKING AREAS, ETC.
- 5. ALL PIPE SIZES INDICATED ARE MINIMUMS. CONTRACTOR MAY NOT DECREASE PIPE SIZE. LARGER PIPE SIZES MAY BE USED AT NO ADDITIONAL COST TO OWNER.
- 6. INSTALL ALL IRRIGATION PIPE AND CONTROL WIRES IN PVC SLEEVE BELOW ALL PAVED SURFACES UNLESS OTHERWISE INDICATED ON THE PLANS. INSTALL SLEEVES PRIOR TO PLACEMENT OF PAVEMENT SURFACES. COORDINATE WITH PLACEMENT OF SUB-BASE.
- 7. COORDINATE IRRIGATION POINTS OF CONNECTION AND LOCATION OF AUTOMATIC CONTROL VALVES WITH PROJECT MANAGER. COORDINATE ALL WORK WITH OTHER TRADES, I.E. ELECTRICAL, MASONRY,
- 8. CONTRACTOR TO PROGRAM AUTOMATIC CONTROLLER TO ALLOW FOR THE EQUIVALENT OF 1" OF WATER PER WEEK, OR PER SITE AND PLANTING NEEDS FOR BEST PLANT HEALTH.
- 9. ALL PIPES SHALL BE TRENCHED. PROVIDE FOR POSITIVE DRAINAGE OF MAINLINE. PLACE MANUAL DRAIN AT LOW POINTS IN MAINLINE. LOCATIONS TO BE DETERMINED IN THE FIELD. IDENTIFY LOCATIONS ON AS-BUILTS.
- 10. CONTRACTOR TO INSTALL CONTROLLER AND ACCESSORIES PER MANUFACTURERS' SPECIFICATIONS. CONTRACTOR TO FURNISH CONTROL WIRES FROM VALVES TO CONTROLLER. GENERAL CONTRACTOR SHALL BE RESPONSIBLE FOR COORDINATING 120/230 VAC SERVICE AND CONNECTION TO CONTROLLER.
- 11. INSTALL FOUR (4) ADDITIONAL CONTROL WIRES AND GROUND WIRE FROM CONTROLLER TO END OF MAINLINE EXTENSIONS.
- 12. ALL SPRINKLER BODIES TO BE 12-INCH POP-UP TYPE.


IRRIGATION PARKING CITY OF SHERWOOD ENGINEERING DEPARTMENT

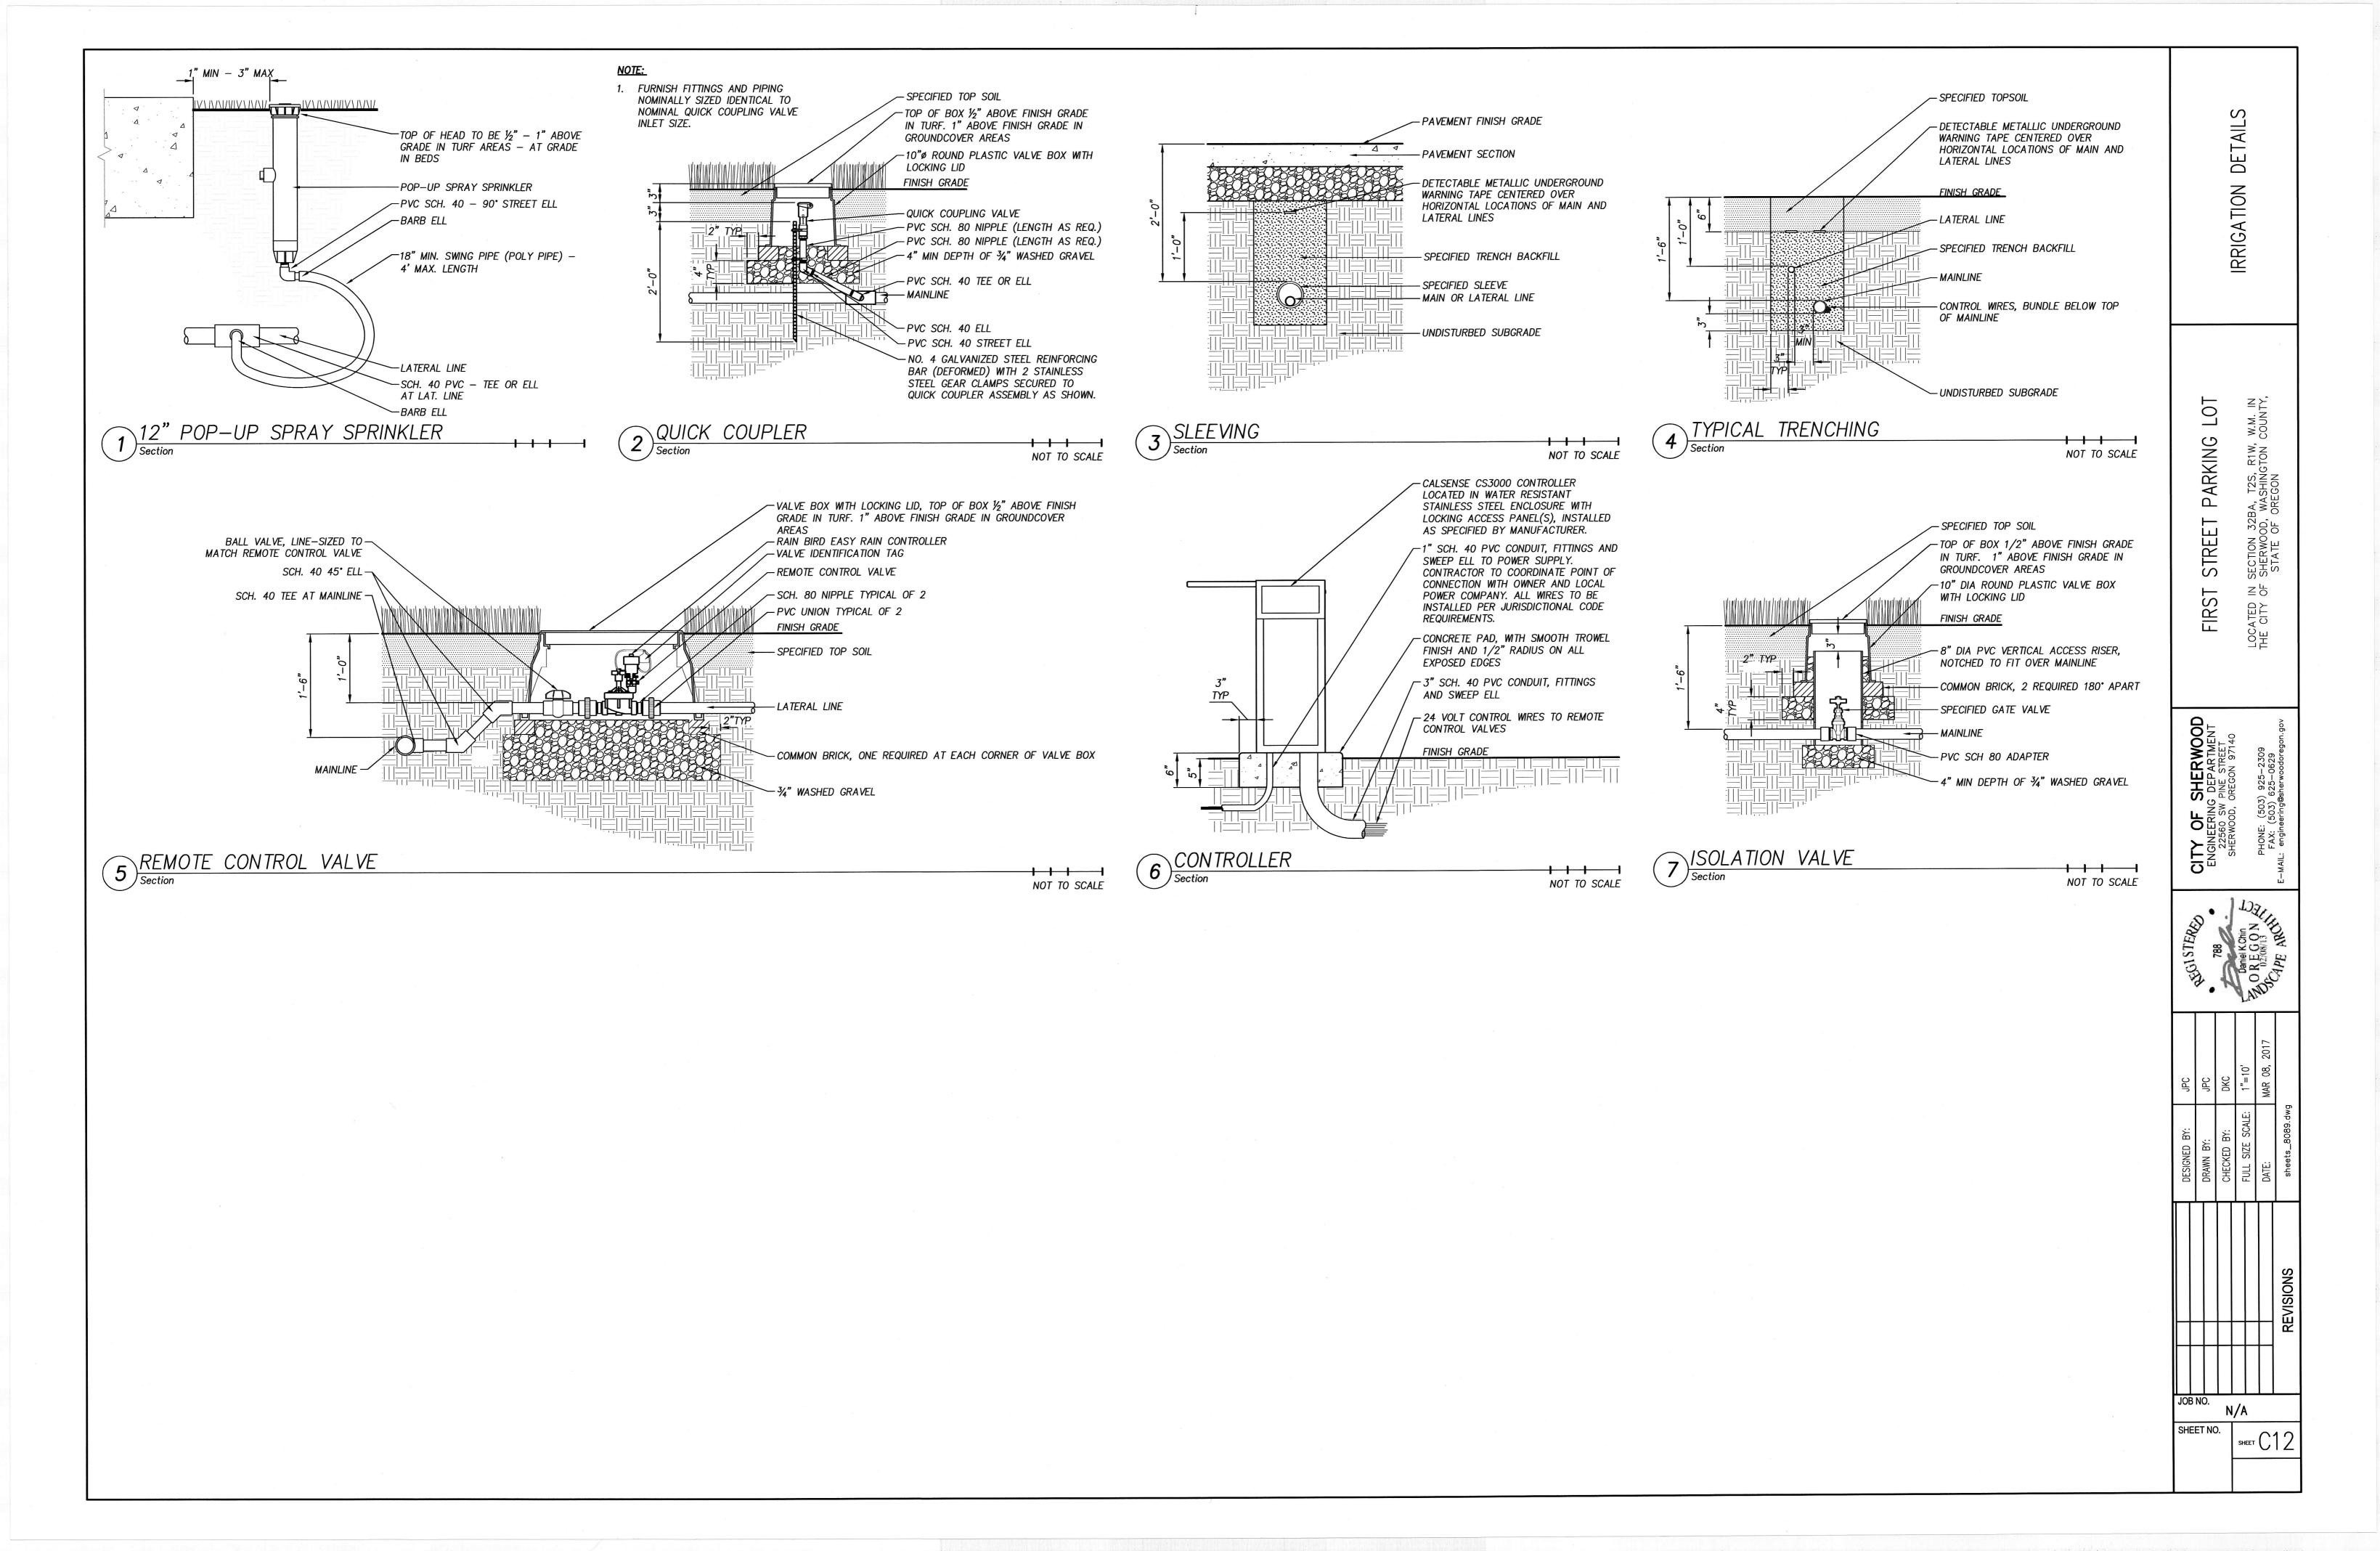


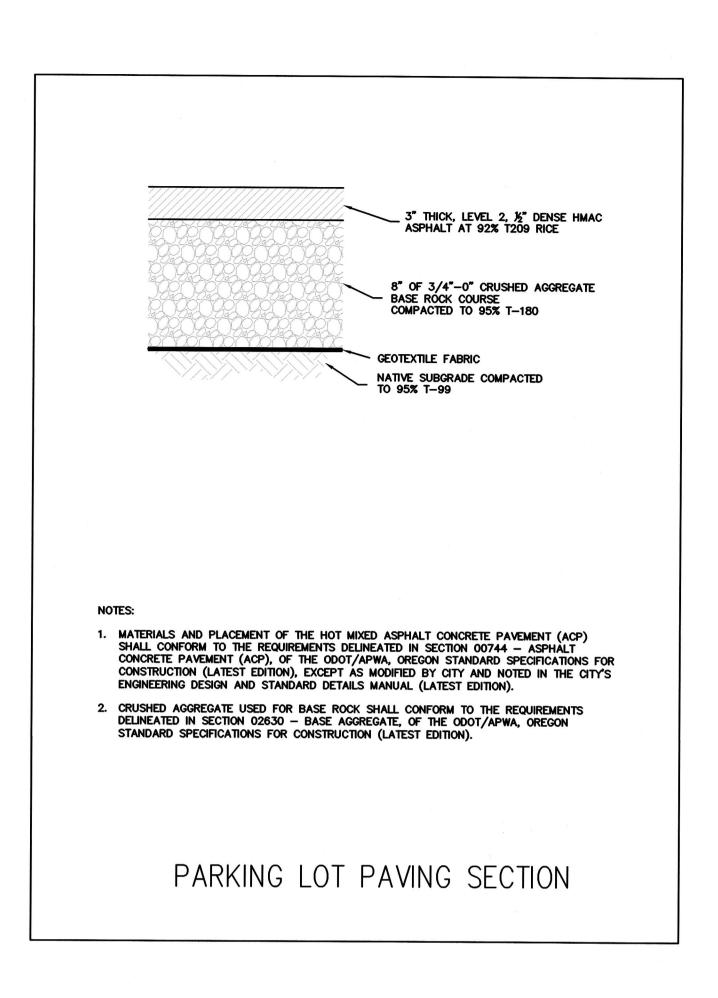


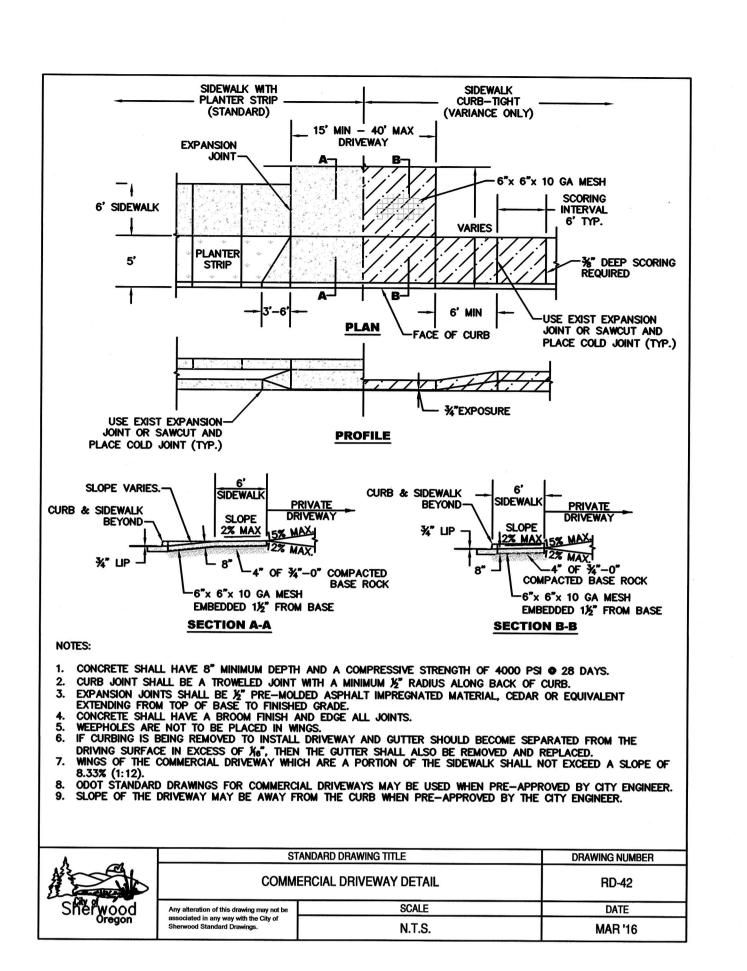


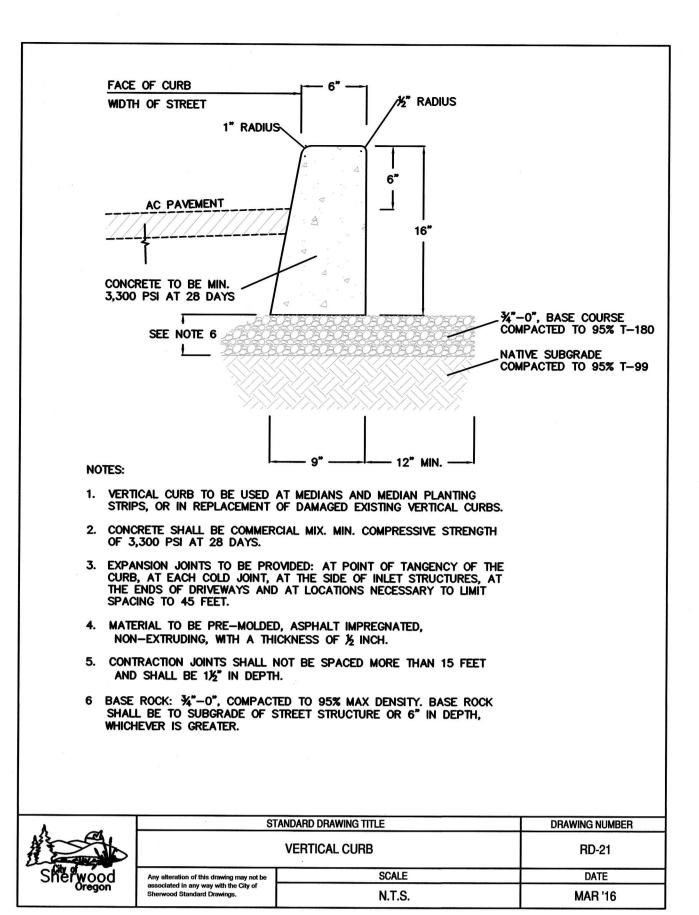


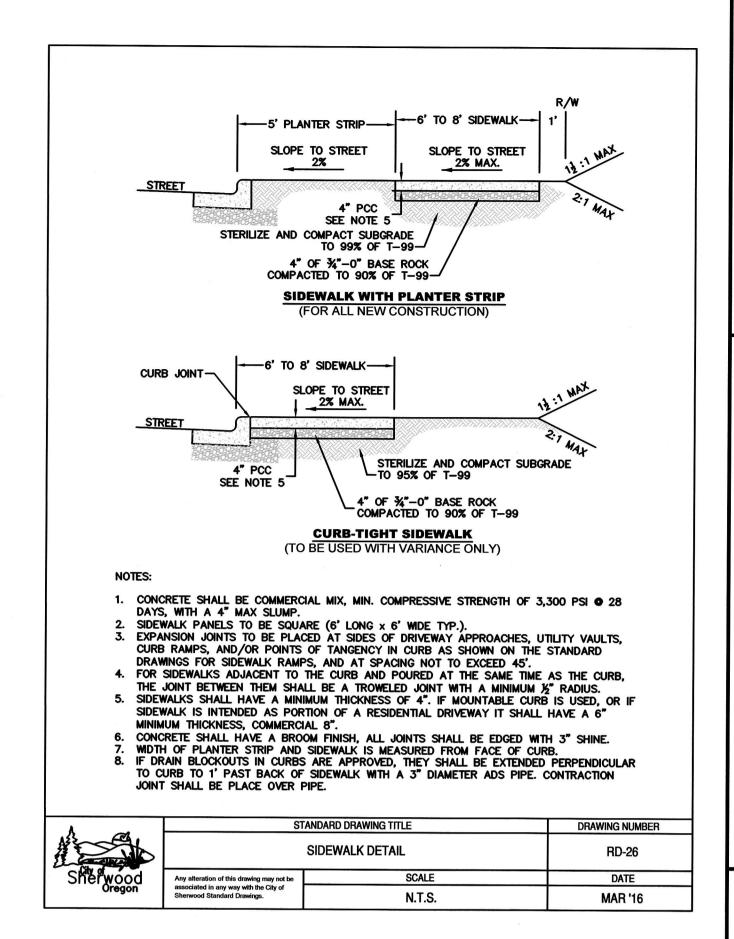


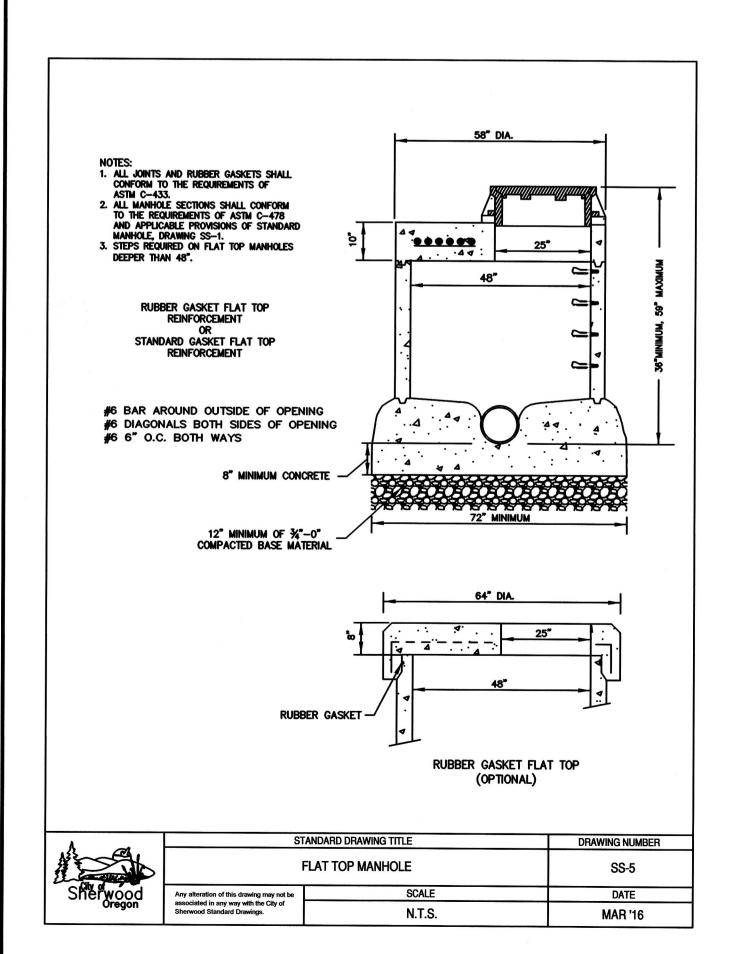

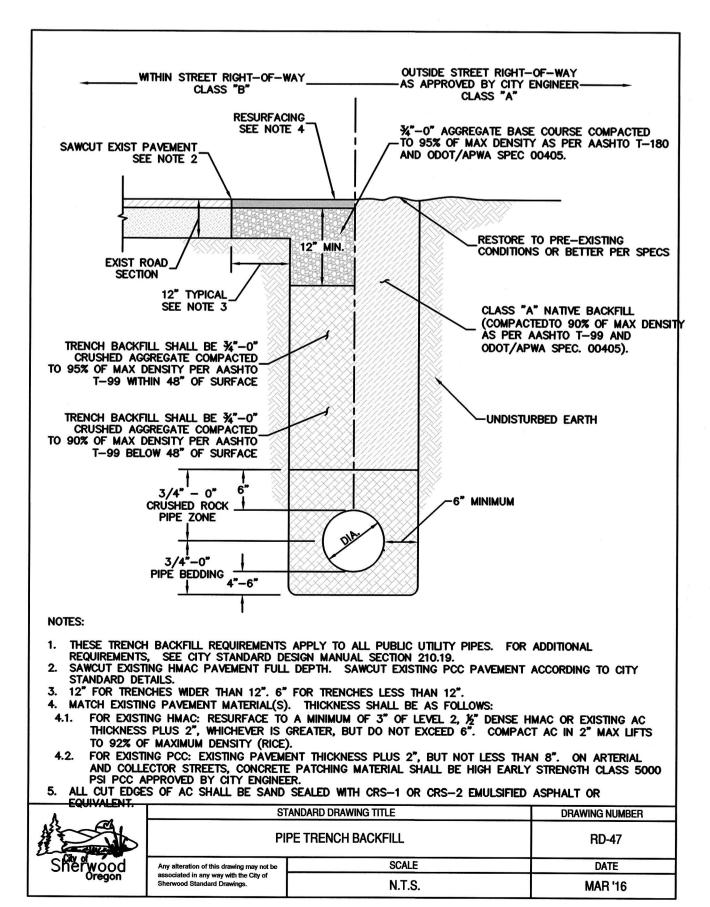

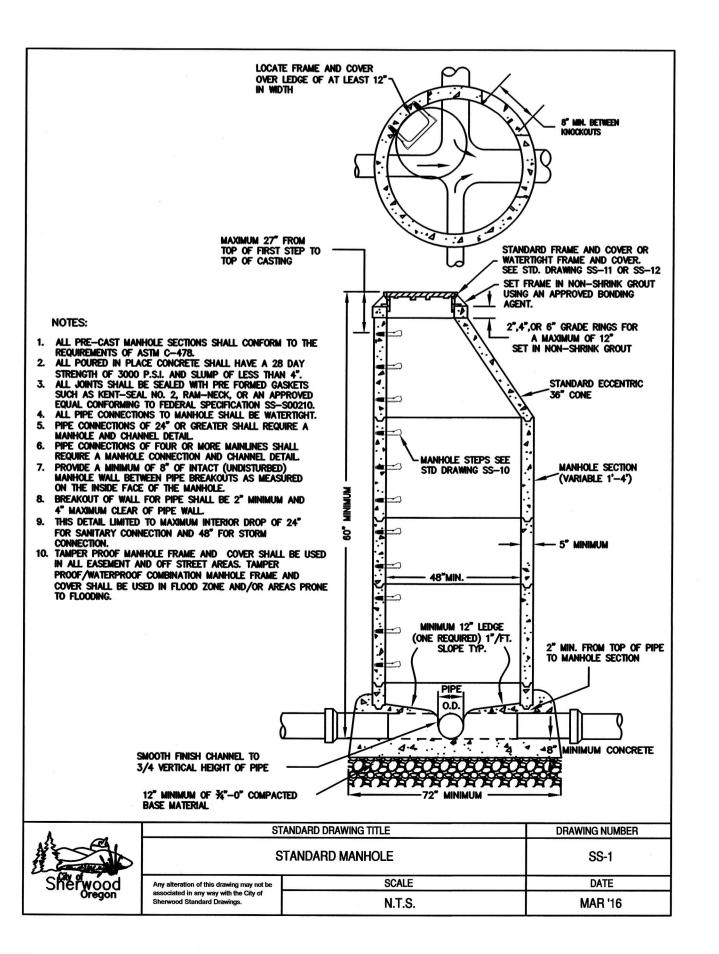

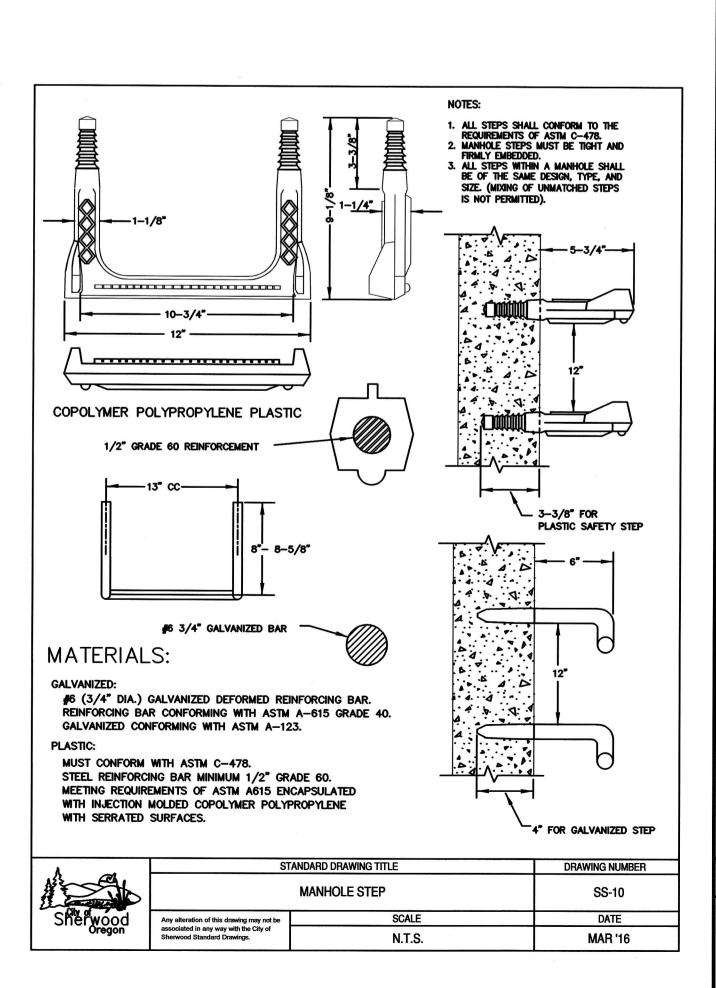

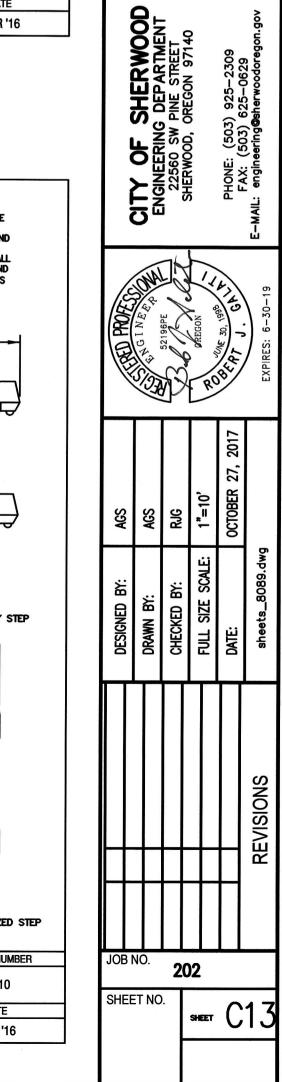

DETAIL


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PARKING

STREET

FIRST

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N.T.S.

WHEN RAINFALL AND RUNOFF OCCURS DAILY INSPECTIONS OF THE EROSION AND SEDIMENT CONTROLS AND DISCHARGE OUTFALLS MUST BE PROVIDED

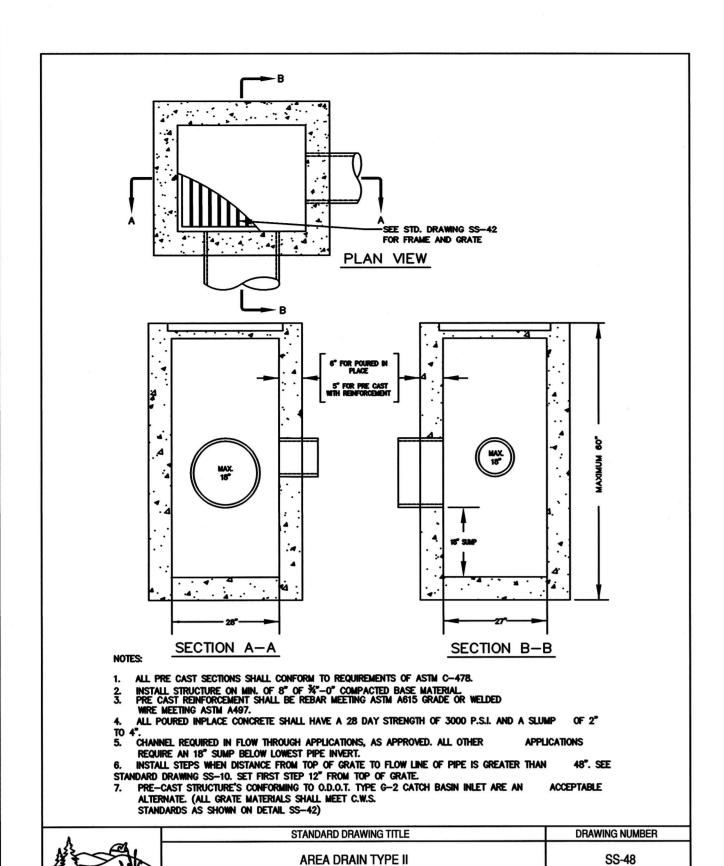CONSTRUCTION ACTIVITIES MUST AVOID OR MINIMIZE EXCAVATION AND CREATION OF BARE GROUND FROM OCTOBER 1 THROUGH MAY 31 EACH YEAR.

SIGNIFICANT AMOUNTS OF SEDIMENT WHICH LEAVES THE SITE MUST BE CLEANED UP WITHIN 24 HOURS AND PLACED BACK ON THE SITE AND STABILIZED OR PROPERLY DISPOSED. THE CAUSE OF THE SEDIMENT RELEASE MUST BE FOUND AND PREVENTED FROM CAUSING A RECURRENCE OF THE DISCHARGE WITHIN THE SAME 24 HOURS. ANY IN-STREAM CLEAN UP OF SEDIMENT SHALL BE PREFORMED ACCORDING TO THE OREGON DEPARTMENT OF STATE LANDS REQUIRED TIME FRAME.

SEDIMENT MUST BE REMOVED FROM BEHIND ALL SEDIMENT CONTROL MEASURES WHEN IT HAS REACHED A HEIGHT OF 1/3RD THE BARRIER HEIGHT,

CLEANING OF ALL STRUCTURES WITH SUMPS MUST OCCUR WHEN THE SEDIMENT RETENTION CAPACITY HAS BEEN REDUCED BY 50% AND AT COMPLETION OF PROJECT.

2. THE APPLICATION RATE OF FERTILIZERS USED TO REESTABLISH VEGETATION MUST FOLLOW MANUFACTURER'S RECOMMENDATIONS.

11. THE PERMITTEE MUST PROPERLY MANAGE HAZARDOUS WASTES, USED OILS, CONTAMINATED SOILS, CONCRETE WASTE, SANITARY WASTE, LIQUID WASTE, OR OTHER TOXIC SUBSTANCES DISCOVERED OR GENERATED DURING CONSTRUCTION.

NUTRIENT RELEASES FROM FERTILIZERS TO SURFACE WATERS MUST BE MINIMIZED. TIME RELEASE FERTILIZERS SHOULD BE USED AND CARE SHOULD BE MADE IN APPLICATION OF FERTILIZERS WITHIN ANY WATER WAY RIPARIAN ZONE.

OWNER OR DESIGNATED PERSON SHALL BE RESPONSIBLE FOR PROPER INSTALLATION AND MAINTENANCE OF ALL EROSION AND SEDIMENT CONTROL MEASURES, IN ACCORDANCE WITH CURRENT CLEAN WATER SERVICES STANDARDS AND STATE, AND FEDERAL REGULATIONS.

I. PRIOR TO ANY LAND DISTURBING ACTIVITIES, THE BOUNDARIES OF THE CLEARING LIMITS, VEGETATED BUFFERS, AND ANY SENSITIVE AREAS SHOWN ON THIS PLAN SHALL BE CLEARLY DELINEATED IN THE FIELD. UNLESS OTHERWISE APPROVED, NO DISTURBANCE IS PERMITTED BEYOND THE CLEARING LIMITS. THE OWNER/PERMITTEE MUST MAINTAIN THE DELINEATION FOR THE DURATION OF THE PROJECT.

NOTE: VEGETATED CORRIDORS TO BE DELINEATED WITH ORANGE CONSTRUCTION FENCE OR APPROVED EQUAL.

5. PRIOR TO ANY LAND DISTURBING ACTIVITIES, THE BMPS THAT MUST BE INSTALLED ARE GRAVEL CONSTRUCTION ENTRANCE, PERIMETER SEDIMENT CONTROL, AND INLET PROTECTION. THESE BMPS MUST BE MAINTAINED FOR THE DURATION OF THE PROJECT.

IF VEGETATIVE SEED MIXES ARE SPECIFIED, SEEDING MUST TAKE PLACE NO LATER THAN SEPTEMBER 1ST; THE TYPE AND PERCENTAGES OF SEED IN THE MIX ARE AS IDENTIFIED ON THE PLANS OR AS SPECIFIED BY THE DESIGN ENGINEER.

ALL PUMPING OF SEDIMENT LADEN WATER MUST BE DISCHARGED OVER AN UNDISTURBED, PREFERABLY VEGETATED AREA, AND THROUGH A SEDIMENT CONTROL BMP (I.E. FILTER BAG).

9. THE ESC PLAN MUST BE KEPT ONSITE. ALL MEASURES SHOWN ON THE PLAN MUST BE INSTALLED PROPERLY TO ENSURE THAT SEDIMENT LADEN WATER DOES NOT ENTER A SURFACE WATER SYSTEM, ROADWAY, OR OTHER PROPERTIES.

20. THE ESC MEASURES SHOWN ON THIS PLAN ARE THE MINIMUM REQUIREMENTS FOR ANTICIPATED SITE CONDITIONS. DURING THE CONSTRUCTION PERIOD, THESE MEASURES SHALL BE UPGRADED AS NEEDED TO MAINTAIN COMPLIANCE WITH ALL REGULATIONS.

22. IN AREAS SUBJECT TO WIND EROSION, APPROPRIATE BMPS MUST BE USED WHICH MAY INCLUDE THE APPLICATION OF FINE WATER SPRAYING, PLASTIC SHEETING, MULCHING, OR OTHER APPROVED MEASURES.

11. WRITTEN ESC LOGS ARE SUGGESTED TO BE MAINTAINED ONSITE AND AVAILABLE TO DISTRICT INSPECTORS UPON REQUEST.

23. ALL EXPOSED SOILS MUST BE COVERED DURING WET WEATHER PERIOD.

7. WATER-TIGHT TRUCKS MUST BE USED TO TRANSPORT SATURATED SOILS FROM THE CONSTRUCTION SITE. AN APPROVED EQUIVALENT IS TO DRAIN THE SOIL ON SITE AT A DESIGNATED LOCATION USING APPROPRIATE BMPS; SOIL MUST BE DRAINED SUFFICIENTLY FOR MINIMAL SPILLAGE.

SEDIMENT CONTROLS MUST BE INSTALLED AND MAINTAINED ON ALL DOWN GRADIENT SIDES OF THE CONSTRUCTION SITE AT ALL TIMES DURING

ALL ACTIVE INLETS MUST HAVE SEDIMENT CONTROLS INSTALLED AND MAINTAINED AT ALL TIMES DURING CONSTRUCTION, UNLESS OTHERWISE APPROVED, A SURFACE MOUNTED AND ATTACHABLE, U-SHAPED FILTER BAG IS REQUIRED FOR ALL CURB INLET CATCH BASINS.

3. DURING WET WEATHER PERIOD, TEMPORARY STABILIZATION OF THE SITE MUST OCCUR AT THE END OF EACH WORK DAY.


SEDIMENT MUST NOT BE INTENTIONALLY WASHED INTO STORM SEWERS, DRAINAGE WAYS, OR WATER BODIES.


10. ANY USE OF TOXIC OR OTHER HAZARDOUS MATERIALS MUST INCLUDE PROPER STORAGE, APPLICATION, AND DISPOSAL


NOTES:


DATE

MAR '16

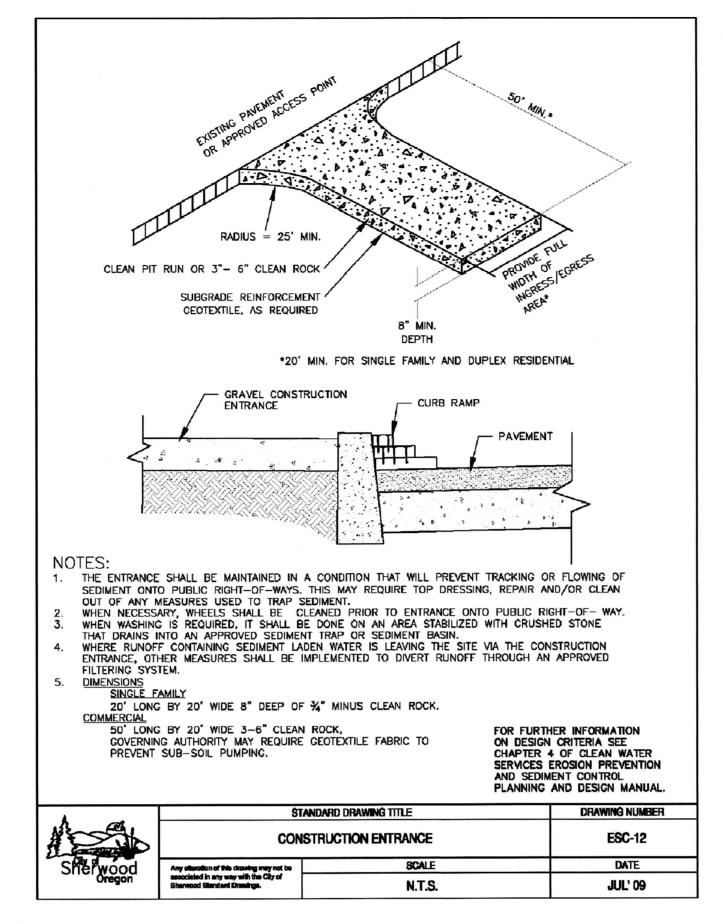


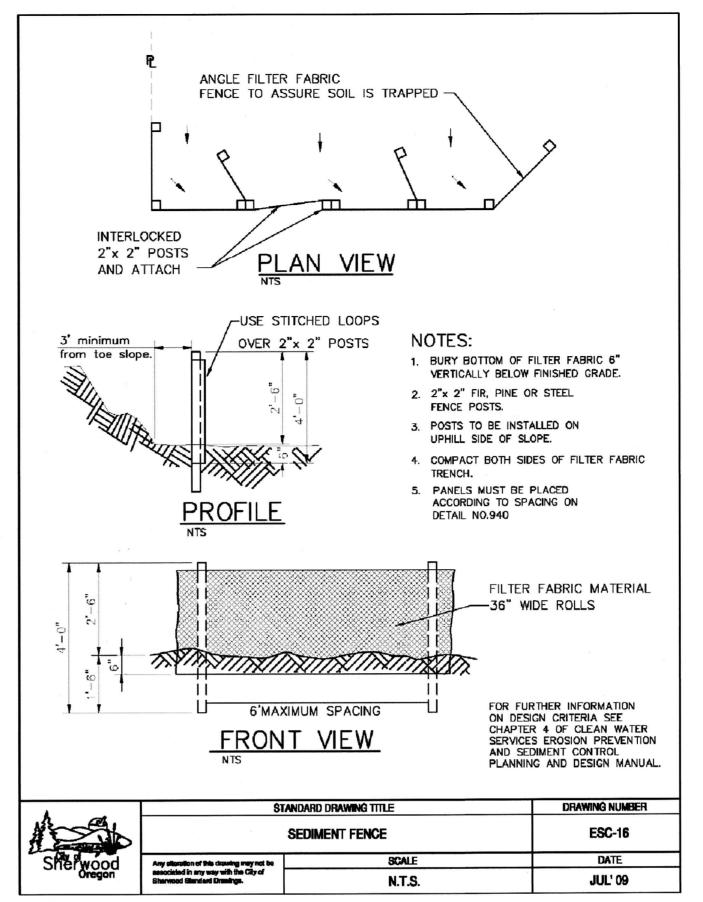


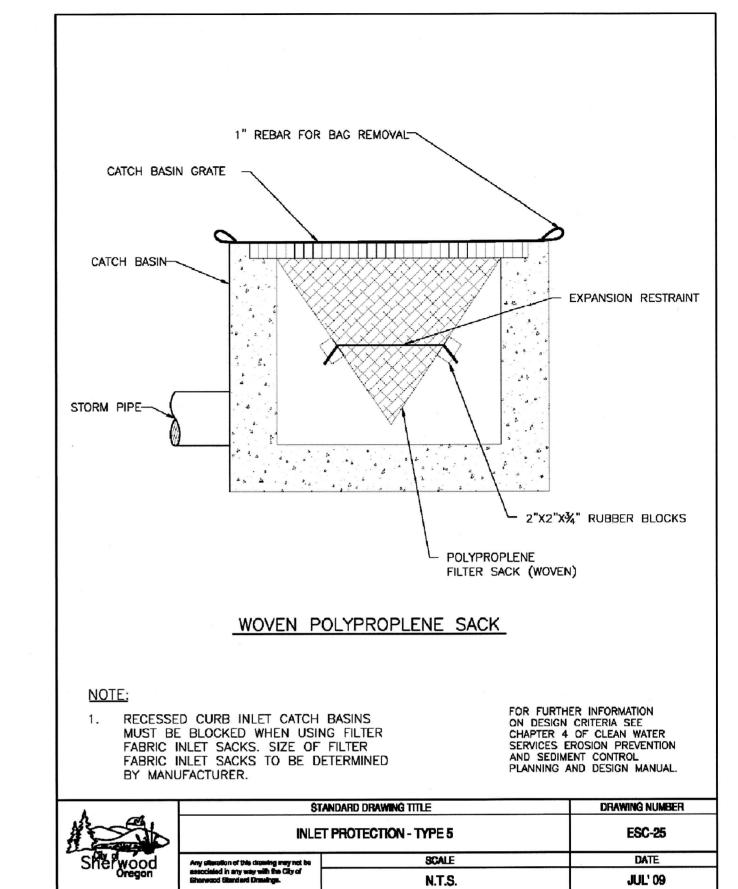

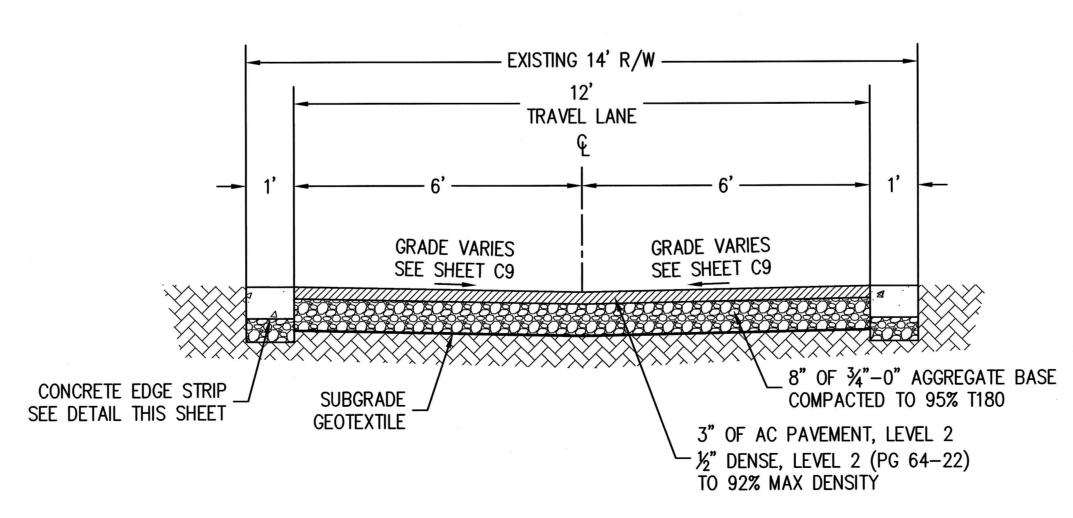



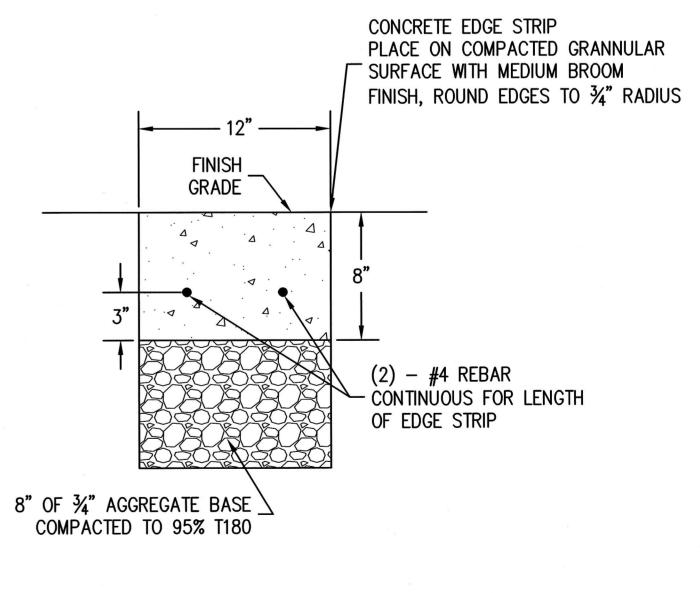

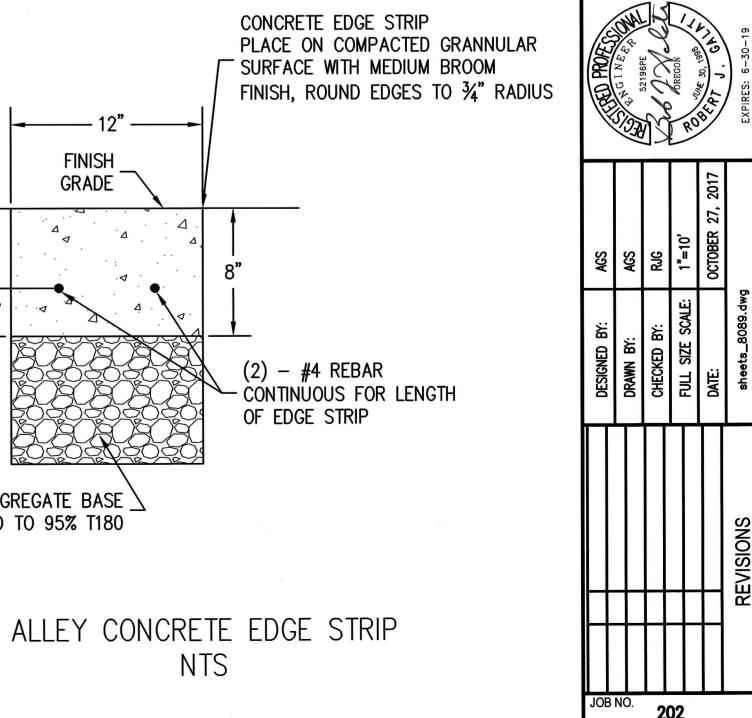



SHEET NO.


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SHEET NO.

1-CARTRIDGE CATCHBASIN - TOP VIEW 1
3 CONCRETE CATCHBASIN STORMFILTER

GENERAL NOTES

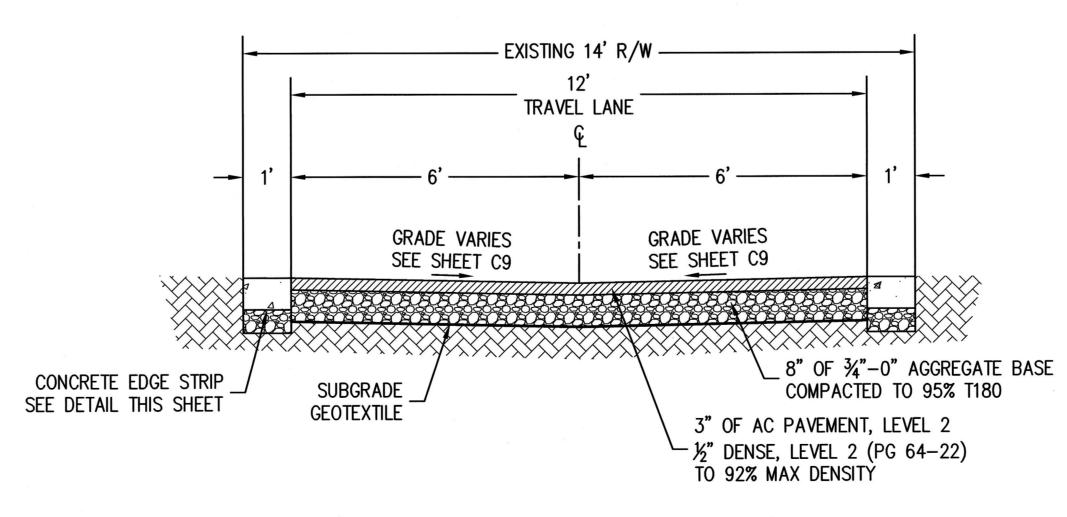1) STORMFILTER BY CONTECH STORMWATER SOLUTIONS; PORTLAND, OR (800) 548-4667; SCARBOROUGH, ME (877) 907-8676;

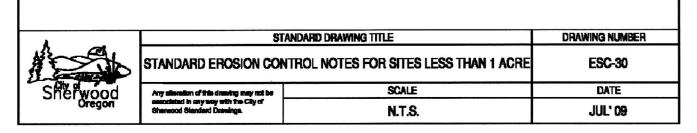2) FILTERS TO BE SIPHON-ACTUATED AND SELF-CLEANING. STANDARD DETAIL SHOWS MAXIMUM NUMBER OF CARTRIDGES. EXACT NUMBER REQUIRED TO BE SPECIFIED ON SITE PLANS.

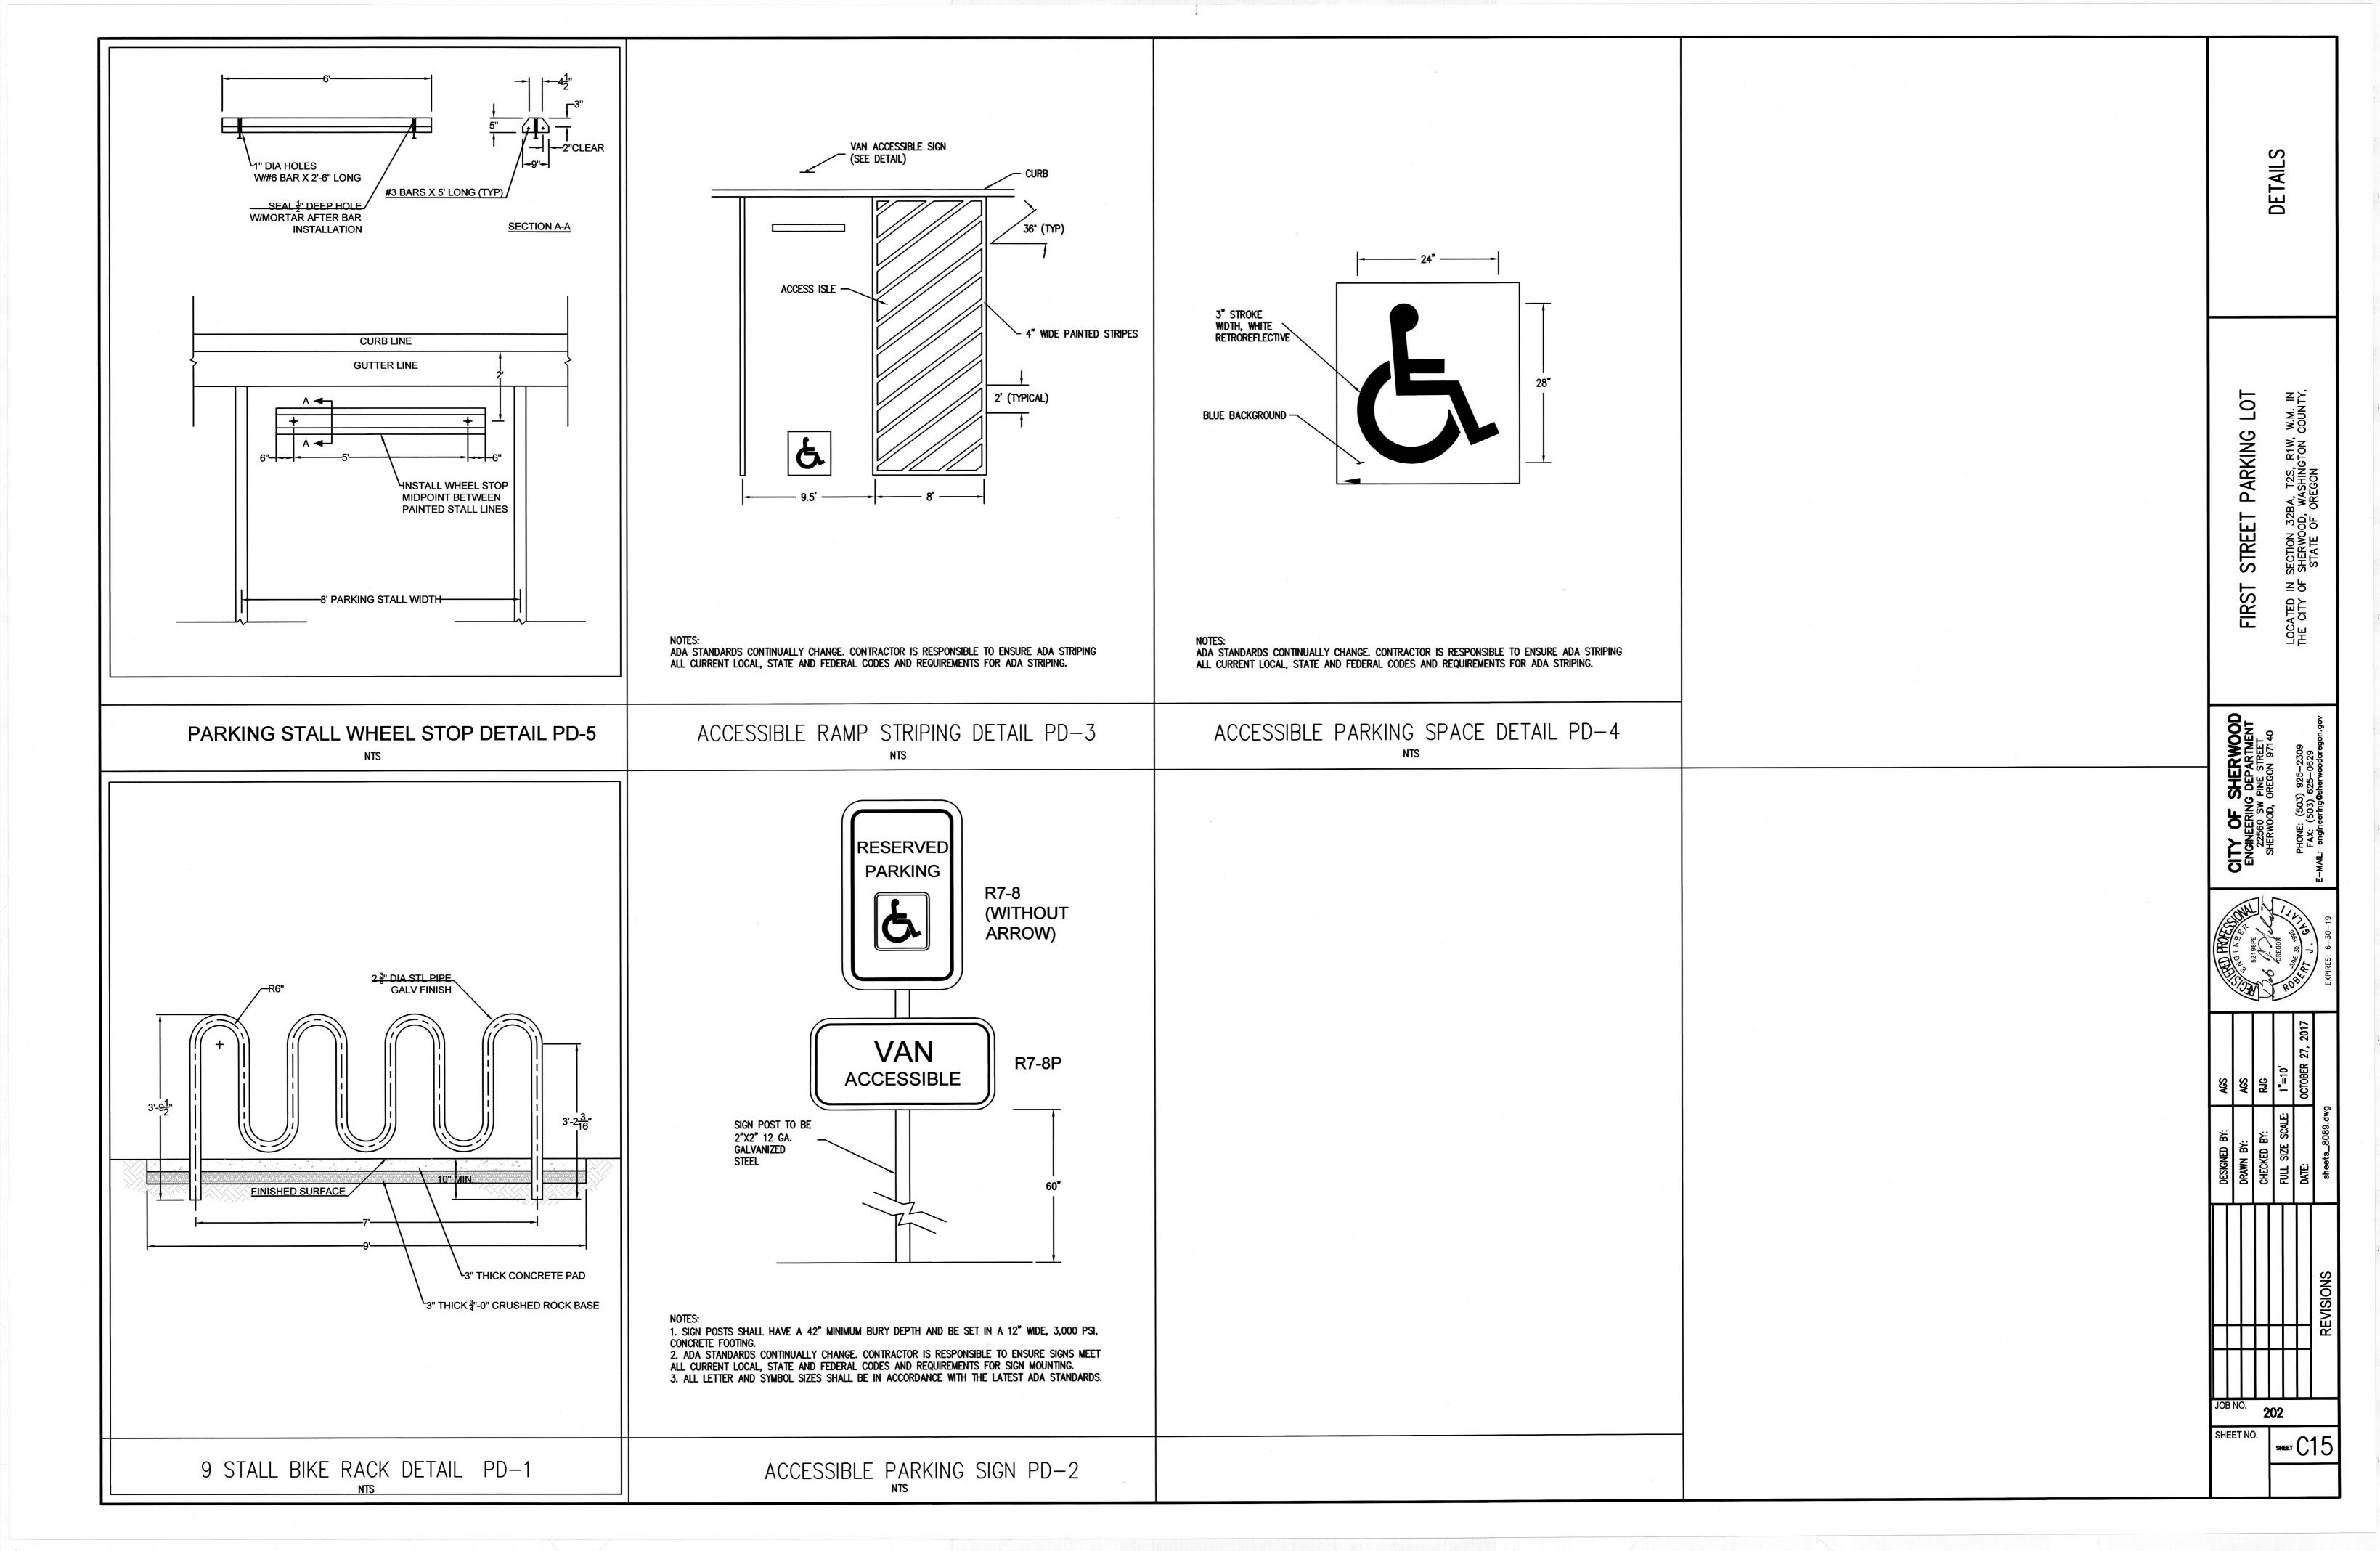4) STORMFILTER REQUIRES BETWEEN 2.75' AND 2.9' OF DROP FROM RIM TO OUTLET. INLET (IF APPLICABLE) AND OUTLET PIPING TO BE SPECIFIED BY ENGINEER AND PROVIDED BY CONTRACTOR. PIPES TO BE GROUTED INTO PROVIDED CORINGS BY

5) ALL STORMFILTERS REQUIRE REGULAR MAINTENANCE. REFER TO OPERATION AND MAINTENANCE GUIDELINES FOR MORE

1CARTRIDGE CONCRETE CATCH BASIN STORMFILTER DATA

 PIPE DATA:
 I.E.
 MATERIAL
 DIAMETER

 INLET
 N/A
 N/A
 N/A

 OUTLET
 192.03
 C-900_PVC
 10"

OPTIONS (AVAILABLE AT EXTRA COST):

HOLE FOR OUTLET STUB OTHER THAN 12"
CLEAN-OUT IN WEIR OTHER THAN 4"
CORED HOLE FOR INLET PIPE
DEEP OUTLET CORING
OTHER: OTHER

STRUCTURE ID
WATER QUALITY FLOW RATE (cfs)
PEAK FLOW RATE (<1 cfs)
RETURN PERIOD OF PEAK FLOW (yrs)
CARTRIDGE FLOW RATE (15 OR 7.5 gpm)
MEDIA TYPE (CSF, PERLITE, ZPG)
RIM ELEVATION

3) INLET AND OUTLET PIPES TO BE GROUTED INTO HOLES PROVIDED. JOINTS TO BE WATER-TIGHT.

CONFIGURATION

LINTHICUM, MD (866) 740-3318.

ENGINEERED SOLUTIONS LLC

NFORMATION.

TOP VIEW, DATA AND NOTES

3 1 CARTRIDGE UNIT - STANDARD DETAIL DRAWN: MJW CHECKED: ARG

